Revitalising Historic Buildings Through Partnership Scheme

Former North Kowloon Magistracy

Resource Kit

Date: 6 July 2020



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I. <u>Introduction</u>

1.1 The purpose of the resource kit is to provide applicants with information to prepare proposals for the historic buildings under the Revitalising Historic Buildings Through Partnership Scheme (the Revitalisation Scheme). Information provided include:

Section I Introduction;

Section II Historical Background and Architectural Merits;

Section III Site Information;
Section IV Building Information:
Section V Vicinity and Access;
Section VI Conservation Guidelines;
Section VII Town Planning Issues;

Section VIII Land and Tree Preservation Issues;

Section IX Slope Maintenance;

Section X Technical Compliance for Possible Uses; and

Section XI Special Requirements of the Project

- 1.2 In drawing up proposals, applicants should in particular endeavour to:
 - (a) bring out the historical significance of the buildings;
 - (b) follow the conservation guidelines; and
 - (c) strike a balance between maintaining the architectural authenticity of the buildings and complying with current statutory requirements.

We appreciate that 1.2 (c) will be a complex task. We have the following suggestions for the applicants' consideration:

- when undergoing major alteration and addition works and material change of use, the historic buildings should be properly upgraded for compliance with the current building safety and health standards under the Buildings Ordinance (Cap.123). The need for preserving the significant architectural features, site constraints and / or prohibitive upgrading cost may limit the type of uses that may be chosen for the buildings; and
- (ii) every effort should be made to preserve the elements of significance and character-defining elements of the historic buildings. Addition and alteration works, if necessary, should be undertaken at less visually intrusive locations.
- 1.3 We have listed out a number of uses under Outline Zoning Plan which can be considered for adaptive-reuse of the site. However, the technical feasibility of such a case will need to be further examined.
- 1.4 The dimensions, areas and datum levels presented in this resource kit including the

drawings and perspectives are for reference only. A thorough cartographic survey for the building and topographic survey for the site should be carried out by authorised specialists to verify the dimensions, areas and datum levels before detailed design is carried out.

- 1.5 The information that has been assembled is to give a general understanding of the site and the historic buildings. Key parameters available at the time of preparation of the resource kit are for the applicants' convenience and may not be exhaustive. Because of the unique nature and requirements of each proposal, applicants are strongly advised to verify the provided data before finalising their proposals.
- 1.6 The Secretariat of the Revitalisation Scheme will provide a one-stop service to assist applicants and where necessary, refer them to concerned departments. Applicants may contact the Secretariat at:-

Address: Revitalising Historic Buildings Through Partnership Scheme

Secretariat

c/o Commissioner for Heritage's Office, Development Bureau

Unit 701B, 7/F., Empire Centre, 68 Mody Road, Tsim Sha Tsui East,

Kowloon, Hong Kong

Email: rhb_enquiry@devb.gov.hk

Phone.: 2906 1560 Fax: 2906 1574

II. <u>Historical Background and Architectural Merits</u>

2.1 Historical Background

Original Use

The Former North Kowloon Magistracy (the Magistracy) was built in 1960 to handle offences within the Kowloon district. It is located at 292 Tai Po Road, Kowloon. The seven-storey building with two open forecourts on the south and north sides was designed by Palmer & Turner Architects. There were two magistracies responsible for handling offences in Kowloon before 1942. One of them was located in Shanghai Street at the junction of the Public Square and the Market Street. The other was the Kowloon Magistracy in Gascoigne Road, built in 1936 and renamed as the South Kowloon District Court in 1957. The magistracy in Shanghai Street was demolished in 1957 while the Former North Kowloon Magistracy was subsequently built in 1960. In 2000, the magistracy in Gascoigne Road was closed and Former North Kowloon Magistracy became the sole judicial court handling offences in Kowloon. The Magistracy could be considered as one of the busiest magistracies in Hong Kong.

The Magistracy used to handle cases in the Kowloon District, which covered Mong Kok, Sham Shui Po, Shek Kip Mei, Cheung Sha Wan and Ho Man Tin. The Magistracy ceased operation on 3 January 2005 due to consolidation of magistracies from nine to six, and had been vacant until 2009. The cases of the Magistracy were then distributed and handled at three additional courts established in Kwun Tong Magistracy and Kowloon City Magistracy.

Within the judiciary structure, all criminal proceedings commence in the Magistrates' Courts and thus, the Magistracy is classified as the lowest court that covers a wide range of indictable and summary offences. Former North Kowloon Magistracy consisted of up to eleven Magistrates' Courts during the busiest days including a Juvenile Court, and offices of government departments. The Juvenile Court handles cases against children and teenagers under the age of 16. Minor offences, such as hawking, traffic convictions and littering are also heard in the Magistrates' Courts by Special Magistrates. The maximum sentence in the Magistracy is two years' imprisonment and a fine of \$100,000. In certain circumstances, the Magistrates may impose sentences of up to three years' imprisonment and a fine of \$5,000,000. Relatively more serious cases are referred to courts of higher jurisdiction, such as the District Courts or the Court of First Instance. According to a senior inspector who had worked in the Magistracy when it was still in use, there were more than forty defendants appearing in the court daily and could reach up to eighty occasionally.

Revitalisation in 2009

In 2009, the Former North Kowloon Magistracy was revitalised into the Savannah College of Art and Design (SCAD) (Hong Kong) by the SCAD Foundation (Hong Kong) Limited, which commenced operation in September 2010 under Revitalising Historic Buildings Through Partnership Scheme (the Revitalisation Scheme) launched by Development Bureau for the provision of non-local higher education courses in art and design. The revitalisation project received an "Honourable Mention" in the 2011 United Nations Educational, Scientific and Cultural Organization (UNESCO) Asia-Pacific Heritage Awards for Culture Heritage Conservation. The current tenancy of SCAD (Hong Kong) would expire in July 2020 and the College would not renew the tenancy upon the expiry. The Government would take over the historic building from 1 August 2020.

2.2 Architectural Merits

The seven-storey Magistracy comprises of a series of tall and narrow windows symmetrically designed on the main elevation dominated the front façade, it also features a double-canopied central projecting bay and a grand entrance double staircase facing Tai Po Road. The Magistracy was constructed in Stripped Classical Style. The façade design visually emphasizes the structural and proportion systems, while most of the traditional mouldings, ornament and details have been elided. It was a reinforced concrete structure with granite ashlar blocks forming the base walls on lower ground floor, and a central light well from the third to the fifth floors, originally designed to provide natural lighting to the internal corridors as well as central staircase on the second floor.

Internally, the Magistracy displays elegant architectural features and incorporates the use of borrowed light to illuminate the interior by means of central light well. Internal decorative features include heavily panelled and moulded hardwood doors, moulded architraves, teak panelling to walls, marble wall finish, stone flooring to entrance hall and central hall staircases, splayed and moulded cornices, and ornamental ironwork in the form of balustrades, metal guard bars and grilles displaying a fleur-de-lis motif throughout. Also, there is a central staircase lit by glass block roof light above with ornamental ironwork balustrades featuring fleur-de-lis motifs. Originally, the Magistracy was divided into three functional zones and characterized by independent circulation access for general public and staff, magistrates, and defendants/prisoners respectively.

The Magistracy is a representative example of functional civic buildings of the period, and therefore could be considered as a rarity.

In 2009, revitalization works were carried out to revitalize the Magistracy into the SCAD (Hong Kong) campus. Localised alteration works at the building facades adopted minimum intervention approach, whereas authenticity and integrity of the external elevations of the Magistracy had been retained and preserved, and the stripped classical architectural style has been respected. Internally, key character defining elements with high level of significance and contributing to its heritage value, such as Court Room No. 1, central staircase and one detention cell etc., were preserved in-situ, while the remaining areas were adaptive reused to suit the new functional requirement. Such intervention to the interior was carried out in a reversible manner, so that the disturbance to the spatial character of the interior was limited and the building fabric would not be adversely impaired. It is considered to be a successful demonstration of adaptive reuse for historic building into a new lease of life.

III. Site Information

3.1 Location

Former North Kowloon Magistracy is located at No. 292 Tai Po Road in Sham Shui Po. The Location Plan of Former North Kowloon Magistracy is shown at **Appendix I**.

3.2 Site Description

The elongated rectangular site for this revitalization project is located at the foot of a hill of height about 90m at the junction of Sham Shui Po and Shek Kip Mei. Two access roads leading up about 4m from Tai Po Road to its North Open Forecourt and South Open Forecourt flanking a seven-storey building sitting on its middle. The main elevation of the building is elevated and facing Tai Po Road, one of the main routes connecting New Territories and Kowloon Central. There are a two-storey temporary building, temporary storage containers and plant building at the South Open Forecourt, adjacent to them are the neighboring school building.

3.3 Site Boundary

The Site Boundary Plan is shown at Appendix II.

3.4 Site Area

The Former North Kowloon Magistracy has been allocated to the Development Bureau under Permanent Government Land Allocation (PGLA) No. GLA-NK 757. According to the land allocation plan in **Appendix XIII**, the site area of the Former North Kowloon Magistracy is approximately 4,815 sq. metres.

3.5 Major Datum Levels

The major datum levels of the site range from around +20.0mPD at the South Open Forecourt to around +23.1mPD at the North Open Forecourt. The forecourts are elevated above the open spaces at pavement level facing Tai Po Road. The major datum levels of the open spaces range from around +16.5mPD at south of central grand double staircase to around +19.8mPD at north of the staircase. The approximate datum levels of the area are shown at **Appendix IV**.

3.6 Topographic Survey

A set of topographic survey plan of Former North Kowloon Magistracy as in May 2020 is shown at **Appendix VI(D)**. The PDF and AutoCAD format of the

survey plans can be obtained at the Revitalisation Scheme Secretariat by submitting a completed request form.

A summary of the site and building information is given in $\mathbf{Appendix}\ \mathbf{V}_{\bullet}$

IV. Building Information

4.1 **Building Description**

The Former North Kowloon Magistracy is abutting Tai Po Road. The site includes the following buildings, structures and areas:

- a) Former North Kowloon Magistracy (a seven-storey building located in the middle of the site with slopes at the north and east sides)
- b) FS & Sprinkler Pump Room & Tank (a plant building at the south of the site)
- c) Temporary Structure (a two-storey temporary building)
- d) Temporary Storage (temporary containers)
- e) Open Forecourts (the South Open Forecourt and the North Open Forecourt)

From 2010 to 2020, the Savannah College of Art and Design (SCAD) Foundation (Hong Kong) Limited had adaptively re-used Former North Kowloon Magistracy as SCAD (Hong Kong) to provide non-local higher education courses in art and design. The SCAD (Hong Kong) ceased operation of the site and the Government will take over the site from 1 August 2020. The drawings approved by the Buildings Department for the above mentioned conversion works of the Magistracy are shown and attached at **Appendix VI(F)**.

The Former North Kowloon Magistracy now houses accommodation such as classrooms, offices, library, exhibiting area, studio and animation laboratory. One of the four original court rooms was conserved and used as lecture hall and the other three were converted into studio and classrooms. The building is in generally fair condition with minor defects on finishes.

The drawings showing the existing layouts of the Magistracy, including block plan, floor plans, major elevations and sections, are shown at **Appendix VI(A)**.

The photos showing the general appearance and internal layout of the Magistracy are shown at **Appendix VII**.

4.2 Historic Grading

The Former North Kowloon Magistracy was listed as Grade 2 Historic Building by the Antiquities Advisory Board on 18 December 2009. "Grade 2 historic building" is defined as a "Building of special merit. Efforts should be made to selectively preserve".

The Historic Building Grading Boundary Plan is shown at **Appendix III**.

4.3 Schedule of Accommodation

The approximate Net Operational Floor Area (NOFA)/ Net Floor Area and Construction Floor Area (CFA) of the Magistracy, other structures and areas provided in this section are indicative only. Applicants should verify such information on their own before adopting this information in their proposals.

Total CFA of the buildings including the Former North Kowloon Magistracy and FS & Sprinkler Pump Room & Tank is approximately 7,720 sq. metres.

Schedule of area is listed as follows:

4.3.1 Former North Kowloon Magistracy

Floor	Approximate Construction Floor Area (m²)	Accommodation	Approximate Net Operational Floor Area/ Net Floor Area (m²)
LG/F	419	TBE Room	16
		Flushing Water Pump Room	13
		Fresh Water Pump Room	18
		F.S. Control Room	4
		Caretaker	8
		Transformer Room	48
		Main Switch Room	30
		Existing AC Plant Room	121
		Water Meter Room	4
		Emergency Generator Room	37
		ST-1	9
		Lift Lobby	18
Sub-total:	419	Sub-total:	326

Floor	Approximate Construction Floor Area (m²)	Accommodation	Approximate Net Operational Floor Area/ Net Floor Area (m ²)
G/F	1315	Entrance Hall	85
		Library	210
		Office 1	10
		Office 2	16
		Office 3	21
		Office 4	10
		Conserved Cell Office 7D (Conserved Detention Cell No. 6)	10
		Office 7C (Old Detention Cell No. 5)	21
		Office 7B (Old Detention Cell No. 4)	22
		Office 7A (Old Detention Cell No. 3)	22
		Office 6	6
		Office 5	6
		AHU Room	5
		Office 8	17
		Office 9	15
		Office 10	10
		Student Works Exhibiting Area	108
		Elec. Meter Room	5
		IT Server Room (Old Detention Cell No. 2)	15
		PAU Room (Old Detention Cell No. 2)	20
		Common Area (Old Police Van Garage)	38
		Corridor	220
		Female Toilet	10
		U.A.T.	4
		Male Toilet	13
		Central Staircase	41
		Conserved Defendant Staircase	10
		ST-1	15
		ST-2	12
		ST-3	11
Sub-total	1: 1315	Sub-total:	1008

Floor	Approximate Construction Floor Area (m²)	Accommodation	Approximate Net Operational Floor Area/ Net Floor Area (m²)
1/F	1219	Lobby / Student Resting Area (Central Hall)	161
		Classroom 1	42
		Classroom 2	47
		Classroom 3	46
		Classroom 4	55
		Classroom 5	61
		Classroom 6	57
		Classroom 7	60
		Classroom 8	78
		Classroom 9	8
		Classroom 10	9
		Office 1	42
		PAU Room	13
		Female Toilet	24
		U.A.T.	3
		Male Toilet	32
		Central Staircase	39
		Conserved Defendant Staircase	17
		Corridor	147
		Elec. Meter Room	4
		Lift Lobby	8
		ST-1	15
		ST-2	17
		ST-3	30
Sub-total:	1219	Sub-total:	1015

Floor	Approximate Construction Floor Area (m²)	Accommodation	Approximate Net Operational Floor Area/ Net Floor Area (m ²)
2/F	1199	Lobby / Student Resting Area (Central Hall)	227
		Conserved No. 1 Court / Lecture Hall (Conserved Court Room No. 1)	139
		Studio (Old Court Room No. 2)	112
		Classroom 11 (Old Court Room No. 3)	45
		Sound Design Studio (Old Court Room No. 3)	87
		Classroom 13 (Old Court Room No. 4)	56
		Classroom 12 (Old Court Room No. 4)	77
		Female Toilet	27
		U.A.T.	3
		Male Toilet	27
		Central Staircase	38
		Conserved Defendant Staircase	29
		Conserved Magistrates' Staircase	15
		Corridor	67
		AHU Room	8
		Lift Lobby	5
		Elec. Meter Room	3
		ST-1	15
		ST-2	17
		ST-3	17
Sub-total:	1199	Sub-total:	1014

Floor	Approximate Construction Floor Area (m²)	Accommodation	Approximate Net Operational Floor Area/ Net Floor Area (m ²)	
3/F	1204	Office 1	44	
		Office 2	67	
		Duct Rooms (Grid D-F) (Old Ducts Room)	15	
		Duct Rooms (Grid A-C) (Old Ducts Room)	15	
		Store (Grid D-F) (Old Ducts Room)	15	
		Store (Grid A-C) (Old Ducts Room)	15	
		Elec. Meter Room	3	
		I.T. Server Room	9	
		PAU Room (Grid 5-6)	11	
		PAU Room (Grid 10-11)	17	
		Female Toilet	26	
		U.A.T.	5	
		Male Toilet	24	
		Central Light Well	40	
		Conserved Magistrates' Staircase	7	
		Corridor	169	
			Balcony	28
		Lift Lobby	5	
		ST-1	15	
		ST-2	17	
		ST-3	17	
Sub-total:	1204	Sub-total:	564	

Floor	Approximate Construction Floor Area (m²)	Accommodation	Approximate Net Operational Floor Area/ Net Floor Area (m ²)
4/F	1182	Classroom 14	46
		Classroom 15	47
		Classroom 16	46
		Classroom 17	46
		Classroom 18	47
		Classroom 19	55
		Classroom 20	55
		Classroom 21	48
		Classroom 22	46
		Classroom 23	43
		Office 1	44
		Office 2	41
		Stop Motion Animation Studio	93
		PAU Room (Grid 5-6)	11
		PAU Room (Grid 10-11)	17
		Female Toilet	26
		U.A.T.	5
		Male Toilet	29
		Corridor	171
		Lift Lobby	5
		Elec. Meter Room	3
		ST-1	15
		ST-2	17
		ST-3	17
Sub-total:	1182	Sub-total:	973

Floor	Approximate Construction Floor Area (m²)	Accommodation	Approximate Net Operational Floor Area/ Net Floor Area (m ²)
5/F	1182	Classroom 24	43
		Classroom 25	94
		Classroom 26	46
		Classroom 27	94
		Classroom 28	67
		Classroom 29	67
		Classroom 30	47
		Classroom 31	56
		Photo Studio	135
		PAU Room (Grid 5-6)	11
		PAU Room (Grid 10-11)	17
		Female Toilet	26
		U.A.T.	5
		Male Toilet	29
		Elec. Meter Room	2
		Lift Lobby	5
		Corridor	184
		ST-1	15
		ST-2	17
		ST-3	17
Sub-total:	1182	Sub-total:	977
Total:	7720	Total:	5877

4.3.2 FS & Sprinkler Pump Room & Tank

Floor	Approximate Construction Floor Area (m²)	Accommodation	Approximate Net Operational Floor Area/ Net Floor Area (m ²)
G/F	42	F.S. & Sprinkler Pump Room	24
		AC Pump Room	12
Total:	42	Total:	36

4.3.3 Temporary Structure

Floor	Accommodation	Approximate Construction Floor Area (m ²)
G/F	Temporary Structure	137
1/F	Temporary Structure	100
	Total:	237

4.3.4 Open Forecourts

Floor	Accommodation	Approximate Area (m²)
LG/F	South Open Forecourt	450
G/F	North Open Forecourt	595
	Total:	1045

4.4 Materials of Construction

4.4.1 Former North Kowloon Magistracy

Materials	Roof	- Reinforced Concrete with concrete roof tiles - Glazed skylight
		- Glazed lift overrun enclosure
	Wall	Reinforced Concrete
	Floor	Reinforced Concrete
	Staircase	ST-1, ST-2 & ST-3
		- Steel
		<u>Central Staircase, Conserved Defendant</u> <u>Staircase & Conserved Magistrates' Staircase</u>
		- Reinforced Concrete
	Window	Steel frame with glazed panel
	Door	Main Entrance Door
	D001	- Bronze studded panel cladding
		Side Entrance Door
		- Wooden
		Old Court Rooms
		- Wooden
		Offices, Classrooms, Toilets, Staircases &
		Lift Lobby
		- Wooden;
		- Stainless Steel; or
		- Aluminum frame with glazed panel
		Plant Rooms
		- Wooden
Finishes	Exterior	Front Elevation facing Tai Po Road
		- Decorative glazed tiles
		- Granite
		- Ashlar-faced
		- Grooved Stucco
		South and North Elevations
		- Ashlar-faced
		- Grooved Stucco
		East Elevation
		- Ashlar-faced
		- Grooved Stucco

Finishes	Interior – Staircases	S
	Central Staircase	Wall
		- Marble Cladding
		Skirting
		- Black Mable
		Treads and Riser
		- Stone
		Ceiling
		- Roof Light with Glass Blocks over the
		landing
	Conserved	Wall
	Defendant	- Ceramic Tiles
	Staircase	Treads and Riser
		- Screeding with ceramic nosing tiles
	Conserved	Wall
	Magistrates'	- Emulsion Paint
	Staircase	Skirting
		- Mosaic Tiles
		Treads and Riser
		- Mosaic tiles with ceramic nosing tiles
-	ST-1	Wall_
	ST-2	- Emulsion Paint
	ST-3	
	31-3	Skirting - Emulsion Paint
		Floor
		- Screeding with stainless steel nosing strip
		Ceiling - Emulsion Paint
	Interior I C/E	- Emulsion Fami
	Interior – LG/F	XX7_11
	Lift Lobby	Wall
		- Emulsion Paint
		Skirting
		- Vinyl Floor Finishes
		Floor
		- Screeding
		Ceiling
		- Emulsion Paint
	Caretaker	Wall
		- Emulsion Paint
		Skirting
		- Vinyl
		<u>Floor</u>
		- Screeding
		Ceiling
		- Suspended Ceiling with Fiber Panel

Finishes	Interior – LG/F	
	Plant Rooms	Wall
		- Emulsion Paint
		Floor
		- Screeding
		Ceiling
		- Emulsion Paint
	Interior – G/F	
	Entrance Hall	Wall
		- Marble Cladding
		Skirting
		- Black Marble
		<u>Floor</u>
		- Stone
		Ceiling
		- Suspended Ceiling with Gypsum Board
	Conserved Cell	Wall
	Office 7D	- Emulsion Paint
	(Conserved	- Ceramic Tiles (in Squat Toilet)
	Detention Cell	<u>Floor</u>
	No.6)	- Screeding
		- Mosaic Tiles (in Squat Toilet)
		Ceiling
		- Emulsion Paint
	Offices	Wall
		- Emulsion Paint
		Skirting
		- Vinyl
		<u>Floor</u>
		- Carpet
		- Vinyl Sheet
		Ceiling Finishes
		- Suspended Ceiling with Aluminum Panel
	Student Works	Wall
	Exhibiting Area	- Emulsion Paint
		Skirting
		- Vinyl
		Floor
		- Screeding
		Ceiling
		- Emulsion Paint

Finishes	Interior – G/F	
	Library	Wall
		- Emulsion Paint
		Skirting
		- Vinyl
		<u>Floor</u>
		- Carpet
		Ceiling
		- Emulsion Paint
	Common Area	Wall
		- Emulsion Paint
		Skirting
		- Vinyl
		<u>Floor</u>
		- Screeding
		Ceiling
		- Emulsion Paint
	Corridor	Wall
		- Emulsion Paint
		Skirting
		- Vinyl
		<u>Floor</u>
		- Screeding
		- Carpet
		Ceiling
		- Emulsion Paint
	Lift Lobby	Wall
		- Emulsion Paint
		Skirting
		- Vinyl
		<u>Floor</u>
		- Screeding
		<u>Ceiling</u>
		- Emulsion Paint
	Toilets	Wall
		- Homogenous Tiles
		<u>Floor</u>
		- Homogenous Tiles
		Ceiling
		- Suspended Ceiling with Fiber Panel

Finishes	Interior – G/F	
	Plant Rooms	Wall
	Tiant Rooms	- Emulsion Paint
		Skirting
		- Vinyl
		Floor
		- Screeding
		Ceiling
	T . 1/D	- Emulsion Paint
	Interior – 1/F	*** 11
	Lobby/ Student	Wall
	Resting Area	- Marble Cladding
	(Central Hall)	Skirting
		- Black Marble
		<u>Floor</u>
		- Ceramic Tiles
		<u>Ceiling</u>
		- Suspended Ceiling with Gypsum Board
	Offices	Wall
		- Emulsion Paint
		Skirting
		- Vinyl
		<u>Floor</u>
		- Carpet
		- Vinyl Sheet
		Ceiling
		- Suspended Ceiling with Aluminum Panel
	Classrooms	Wall
		- Emulsion Paint
		Skirting
		- Vinyl
		<u>Floor</u>
		- Vinyl Sheet
		- Carpet
		Ceiling
		- Suspended Ceiling with Fiber Panel
	Corridor	Wall
		- Emulsion Paint
		Skirting
		- Vinyl
		Floor
		- Screeding
		Ceiling
		- Suspended Ceiling with Fiber Panel
		Suspended Coming with Floor Funct

Finishes	Interior – 1/F	
	Lift Lobby	Wall
		- Emulsion Paint
		Skirting
		- Vinyl
		Floor
		- Screeding
		Ceiling
		- Emulsion Paint
	Toilets	Wall
		- Ceramic Tiles
		<u>Floor</u>
		- Homogenous Tiles
		Ceiling
		- Suspended Ceiling with Fiber Panel
	Plant Rooms	Wall
		- Emulsion Paint
		<u>Floor</u>
		- Screeding
		<u>Ceiling</u>
		- Emulsion Paint
	Interior – 2/F	
	Lobby/ Student	Wall
	Resting Area	- Marble Cladding
	(Central Hall)	Skirting
		- Black Marble
		<u>Floor</u>
		- Ceramic Tiles
		Ceiling
		- Suspended Ceiling with Gypsum Board
	Conserved No. 1	Wall
	Court/ Lecture	- Fiber Acoustic Panel
	Hall	- Timber Panel
		Skirting
		- Timber
		<u>Floor</u>
		- Timber Parquet Flooring
		Ceiling
		- Emulsion Paint

Finishes	Interior – 2/F	
	Studio	Wall
		- Emulsion Paint
		Skirting
		- Vinyl
		Floor
		- Screeding
		- Carpet
		Ceiling
		- Emulsion Paint
	Classrooms	Wall
		- Emulsion Paint
		Skirting
		- Vinyl
		<u>Floor</u>
		- Vinyl Sheet
		- Carpet
		<u>Ceiling</u>
		- Suspended Ceiling with Fiber Panel
	Corridor	Wall
		- Emulsion Paint
		Skirting
		- Vinyl
		<u>Floor</u>
		- Screeding
		Ceiling
		- Suspended Ceiling with Fiber Panel
	Lift Lobby	Wall
		- Emulsion Paint
		Skirting
		- Vinyl
		<u>Floor</u>
		- Screeding
		Ceiling
		- Emulsion Paint
	Toilets	Wall
		- Ceramic Tiles
		<u>Floor</u>
		- Homogenous Tiles
		Ceiling
		- Suspending Ceiling with Fiber Panel

Finishes	Interior – 2/F	
	Plant Rooms	Wall
		- Emulsion Paint
		Floor
		- Screeding
		Ceiling
		- Emulsion Paint
	Interior – 3/F	
	Central Light	Wall
	Well	- Texture Paint
		Skirting
		- Emulsion Paint
		Floor
		- Glass Blocks with Screeding
		Ceiling
		- Roof Skylight
	Offices	Wall
		- Emulsion Paint
		Skirting
		- Vinyl
		Floor
		- Carpet
		Ceiling
		- Suspended Ceiling with Fiber Panel
	Balcony	Wall
		- Emulsion Paint
		Skirting
		- Mosaic Tiles
		<u>Floor</u>
		- Mosaic Tiles
		Ceiling
		- Emulsion Paint
	Corridor	Wall
		- Emulsion Paint
		Skirting
		- Vinyl
		Floor
		- Screeding
		- Carpet
		Ceiling
		- Suspended Ceiling with Fiber Panel

Finishes	Interior – 3/F	
	Lift Lobby	Wall
		- Emulsion Paint
		Skirting
		- Vinyl
		Floor
		- Screeding
		Ceiling
		- Emulsion Paint
	Toilets	Wall
		- Ceramic Tiles
		<u>Floor</u>
		- Homogenous Tiles
		Ceiling
		- Suspended Ceiling with Fiber Panel
	Plant Rooms	Wall
		- Emulsion Paint
		<u>Floor</u>
		- Screeding
		Ceiling
		- Emulsion Paint
	Interior – 4/F	
	Classrooms	Wall
		- Emulsion Paint
		Skirting
		- Vinyl
		<u>Floor</u>
		- Carpet
		<u>Ceiling</u>
		- Suspended Ceiling with Fiber Panel
	Stop Motion	Wall
	Animation Room	- Emulsion Paint
		Skirting
		- Vinyl
		<u>Floor</u>
		- Vinyl Sheet
		Ceiling
		- Suspended Ceiling with Fiber Panel

Finishes	Interior – 4/F	
	Offices	Wall
		- Emulsion Paint
		Skirting
		- Vinyl
		<u>Floor</u>
		- Carpet
		Ceiling
		- Suspended Ceiling with Fiber Panel
	Corridor	Wall
		- Emulsion Paint
		Skirting
		- Vinyl
		<u>Floor</u>
		- Screeding
		- Carpet
		Ceiling
		- Suspended Ceiling with Fiber Panel
	Lift Lobby	Wall
		- Emulsion Paint
		Skirting
		- Vinyl
		<u>Floor</u>
		- Screeding
		<u>Ceiling</u>
		- Emulsion Paint
	Toilets	Wall
		- Ceramic Tiles
		Floor
		- Homogenous Tiles
		<u>Ceiling</u>
		- Suspended Ceiling with Fiber Panel
	Plant Rooms	Wall
		- Emulsion Paint
		<u>Floor</u>
		- Screeding
		Ceiling
		- Emulsion Paint

Finishes	Interior – 5/F	
	Classrooms	Wall
		- Emulsion Paint
		Skirting
		- Vinyl
		<u>Floor</u>
		- Carpet
		- Vinyl Sheet
		<u>Ceiling</u>
		- Suspended Ceiling with Fiber Panel
	Photo Studio	Wall
		- Emulsion Paint
		Skirting
		- Vinyl
		<u>Floor</u>
		- Screeding
		<u>Ceiling</u>
		- Suspended Ceiling with Fiber Panel
	Corridor	Wall
		- Emulsion Paint
		Skirting
		- Vinyl
		<u>Floor</u>
		- Screeding
		- Carpet
		Ceiling
		- Suspended Ceiling with Fiber Panel
	Lift Lobby	Wall
		- Emulsion Paint
		Skirting
		- Vinyl
		<u>Floor</u>
		- Screeding
		Ceiling
		- Emulsion Paint
	Toilets	Wall
		- Ceramic Tiles
		<u>Floor</u>
		- Homogenous Tiles
		Ceiling
		- Suspended Ceiling with Fiber Panel

Finishes	Interior – 5/F	
	Plant Rooms	Wall
		- Emulsion Paint
		Floor
		- Screeding
		Ceiling
		- Emulsion Paint

4.4.2 FS & Sprinkler Pump Room & Tank

Materials	Roof	Reinforced Concrete
	Wall	Reinforced Concrete
	Floor	Reinforced Concrete
	Door	Stainless Steel
Finishes	Exterior	Paint
	Interior	Wall:
		- Emulsion Paint
		Floor:
		- Screeding
		<u>Ceiling</u> :
		- Emulsion Paint

4.4.3 Temporary Structure

Materials	Roof	Metal Corrugated Sheeting
	Wall	Aluminum Panel
	Floor	Metal Sheet
	Door	External: Glass
		Internal: Timber
	Window	Aluminum Window
Finishes	Exterior	Cement rendering & aluminum panel
	Interior	Floor:
		- Screeding, Carpet & Vinyl Sheet
		<u>Ceiling:</u>
		- Suspended Ceiling with Fiber Panel
		Staircase:
		- Steel Staircase

4.4.4 Open Forecourts

Materials	Floor	Concrete
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4.5 Circulation

4.5.1 General Description

There are four numbers of building access for the Former North Kowloon Magistracy. The main pedestrian entrance is by way of entry door facing South Open Forecourt. Daily traffic and delivery to the building through the previous user occurred at the North Open Forecourt. Exit door on 1/F of ST-3 leads to G/F and LG/F open spaces at the rear of the building.

Circulation inside the Magistracy could be referred to the six internal staircases and the accessible lift.

The three staircases (ST-1, ST-2 & ST-3) at the south, north and east of the building are directly connected to the exterior and they are fire escape routes as required under Buildings Ordinance. ST-1 and ST-2 are serving 5/F to LG/F and 5/F to G/F respectively. ST-3 is serving 5/F to 1/F internally and 1/F to G/F externally. These three staircases are steel staircases.

The other three internal reinforced concrete staircases namely Central Staircase, Conserved Defendant Staircase and Conserved Magistrates' Staircase, are conserved. They previously provided independent circulation and access for general public and staff, magistrates and defendants/prisoners respectively. Central Staircase is serving G/F to 2/F at the Central Halls, communicating the Entrance Hall on G/F, Lobby/Student Resting Area on 1/F and 2/F. Conserved Defendant Staircase is serving G/F to 2/F, allowing circulation between Corridor (Old Control Corridor) on G/F and the Conserved No. 1 Court/ Lecture Hall on 2/F, while Conserved Magistrates' Staircase is partly conserved and now serving Conserved No. 1 Court/ Lecture Hall on 2/F to the corridor on 3/F only.

The roof floor is currently only accessible by a cat ladder for maintenance.

FS & Sprinkler Pump Room & Tank and the Temporary Structure can be directly accessed from South Open Forecourt.

4.5.2 Barrier Free Access

Barrier free access is provided at the south entry door of the building where a tactile ramp facilitating entry of wheel-chair users is provided. Together with an accessible lift serving 5/F to LG/F, they were completed

under Batch I of the Revitalisation Scheme. A designated accessible parking space is located at the south car park adjacent to the entry door. The required staircases serving as exit routes and lift lobby on LG/F are also finished with tactile guide path and warning tiles.

4.6 Major Alterations and Additions

The Former North Kowloon Magistracy had undergone major alterations and additions (A&A) in 2010 under Batch I of the Revitalisation Scheme. The major works included the following:-

- a) Extension of glazed lift overrun enclosure;
- b) Demolition of one lift well;
- c) Addition and alteration of the staircases as means of escape required under Buildings Ordinance;
- d) Demolition of internal staircases;
- e) Alteration of toilets;
- f) Addition of skylight system on light well of R/F;
- g) Alteration of internal partition layout with change of uses;
- h) Provision of barrier free access; and
- i) Construction of FS & Sprinkler Pump Room & Tank in South Open Forecourt.

4.7 Preliminary Structural Appraisal

This section summarizes the structural conditions of the buildings with reference to an independent Structural Condition Survey (SCS). The SCS can be obtained at the Revitalisation Scheme Secretariat by submitting a completed request form. The SCS is mainly prepared on the basis of visual site inspections and site measurements by the Registered Structural Engineer and his team in May 2020. No destructive test such as coring laboratory test or concrete cover opening up at existing concrete member has been carried out. Applicants shall verify the information before adopting in their proposals or for any related purpose.

4.7.1 Structural Information

A set of structural record drawings of the Magistracy and a set of structural record drawings for the A&A works carried out in 2010 under the Batch I of the Revitalisation Scheme are both appended in **Appendix VI(C)**.

The major works carried out in 2010 includes the following items in general:

- (a) Addition of F.S. & Sprinkler Pump Room & Tank and Cooling Towers at the South Open Forecourt;
- (b) Addition of a lift in the Magistracy;

- (c) Addition of three staircases (ST-1, ST-2 and ST-3) in the Magistracy; and
- (d) Addition of a skylight, covering the original central light well at R/F of the Magistracy.

4.7.2 Structural System

4.7.2.1 The Magistracy

The Magistracy is a 7-storey structure constructed as a typical reinforced concrete (RC) beam-slab floor system with RC columns supporting on RC pad footings.

All of LG/F and part of G/F are on-grade reinforced concrete slabs. The remaining part of G/F and all other floors from 1/F to R/F are suspended RC beam-slab structures, except the floor area at the light well at 3/F. This floor area is constructed with mini RC beams in a waffle layout, with glass panel infills to serve as a translucent floor system.

The following are cantilevered RC structures:

- (a) The front canopy extended from 1/F above the Grand Staircase, between grid line A6 and grid line A10;
- (b) The front balcony extended from 3/F between grid line A5 and grid line A11;
- (c) The roof terrace extended from 4/F, covering the aforementioned front balcony; and
- (d) The canopy extended from R/F, running all around the perimeter of the building.

The staircases (ST-1 to ST-3) added to the Magistracy in 2010 are steel structures, while the original Central Staircase, Defendant Staircase and Conserved Magistrates' Staircase are typical RC construction.

The skylight at R/F is a steel frame with glass panels, covering the central light well that goes from R/F to 3/F.

4.7.2.2 F.S. & Sprinkler Pump Room & Tank

The F.S. & Sprinkler Pump Room & Tank structure is a RC structure supported on a raft footing. Two cooling towers are located adjacent to it and supported on a raft rooting.

4.7.3 Structural Alterations

There has been no identifiable structural alteration or improvement

works done to the entire historical premise since Batch I of the Revitalisation Scheme carried out in 2010.

4.7.4 Structural Conditions of Buildings

4.7.4.1 The Magistracy

Minor local spalling, cracks and water seepage were observed in various locations in the Magistracy; however, the overall structural system of the Magistracy is considered to be in fair condition. For the details and locations of the structural defects, please refer to the SCS.

4.7.4.2 F.S. & Sprinkler Pump Room & Tank

The F.S. & Sprinkler Pump Room & Tank structure is in good condition without any identifiable structural defects.

4.7.5 Loading Assessment

The building was built in 1960, and its design is assumed to follow Code of Practice 3 (CP3): Chapter V – 1952 (LCC 1952), which specifies the design floor loading of 80lb/sq.ft. (equivalent to 3.83kPa) for assembly areas with fixed seatings, bank halls, chapels and churches. Given that the Magistracy falls into this category, the original design load for most of its floors shall be 3.83kPa.

Based on the age of the Magistracy, it is reasonable to assign a reduction to the original design load of 3.83kPa. Under the Batch I of the Revitalisation Scheme in 2010, an imposed load of 3.0kPa was proposed in general with consideration of the intended use in educational institution.

Numerous floor areas were altered and/or strengthened under the Batch I of the Revitalisation Scheme. For these floor areas, the imposed loads shall refer to that specified in the Plans approved by the Building Authority in 2010 (refer to **Appendix VI(C)**).

Location	Floor	Original Use	Proposed Usage in 2010 under Batch I Scheme	Original Design Imposed Load (kPa)	Estimated Current Imposed Loading Capacity (kPa)
Magistracy	LG/F (on-grade slab)	-	Plant Room	-	5.0**
	G/F (on-grade slab)	Courthouse	Education Institution	3.83#	5.0**
	G/F (suspended slab)	Courthouse	Education Institution	3.83#	3.0*
	1/F-5/F	Courthouse	Education Institution Plant Room	3.83 [#]	3.0* 5.0*
	R/F	Inaccessible Flat Roof	Inaccessible Flat Roof	0.72#	0.75*
F.S. &	G/F	-	Pump Room	-	7.5*
Sprinkler	1/F	-	Water Tank	-	-
Pump Room & Tank	R/F	-	Inaccessible Flat Roof	-	0.75*
North and South Open Forecourt	G/F (on-grade slab)	Carpark	Carpark	3.83#	5.0**

^{*}According to LCC 1952 as stated in para. 4.7.5.

4.7.6 Recommendation

From recent visual inspection, the Magistracy appears to be well taken care of since the revitalisation works in 2010. In addition, there has been no structural alteration works done since then. In light of the above, the Magistracy is considered to be in fair structural condition, with normal wear and defects which shall be repaired in order to prevent further deterioration.

For the F.S. & Sprinkler Pump Room & Tank, no structural defect was identified. Therefore, no repairing work is anticipated.

The selected applicant should verify validity of the estimated imposed loading capacities before adopting them for the design of their proposed

^{*}According to the A&A plans approved in 2010 (refer to **Appendix VI(C)**).

^{**}An estimated capacity for on-grade slab. Further investigation is required to determine its exact loading capacity.

use of the buildings. Should the applicant's proposed use involves greater imposed loads on floors, the applicant shall carry out sufficient tests and detailed analysis to assess the structural capacity and to implement necessary strengthening works depending on the finding of the structural assessment and proposed use.

4.8 Building Services and Utilities

A list of existing provisions of building services and utilities for the site of Former North Kowloon Magistracy is as follows:

4.8.1 Former North Kowloon Magistracy

Building Services	Existing Provisions		
Mechanical Ventilation and Air- Conditioning System Installation	1. 2 sets of water-cooled liquid chillers with 787kW cooling capacity are installed at A/C plant on LG floor and R134a refrigerant is used.		
	2. 2 sets of cooling towers with 994kW cooling capacity are installed next to the FS & Sprinkler Pump Room & Tank at South Open Forecourt.		
	3. 8 nos. of primary air units (PAU) are installed for pre-treating outdoor air. The pre-treated air is connected to the fan coil units (FCU) at the corridors, offices and function rooms inside the Magistracy. There are approximately 185 nos. of FCU on site in which 3 nos. of FCUs are not in used on 2/F.		
	4. 1 set CCMS (Central Control Monitoring System) for A/C system in G/F control Room.		
	5. 5 nos. of air handling units (AHU) are installed mainly for entrance hall, lobby/student resting area and conserved no.1 court/lecture hall inside the Magistracy.		
	6. 3 sets of chilled water pumps (2 duty & 1 standby) are installed for circulating chilled water to all FCUs, PAUs and AHUs on all floors inside the Magistracy.		
	7. 3 sets of condensing water pumps (2 duty & 1 standby) are installed for heat rejection.		

Building Services	Existing Provisions		
Mechanical Ventilation and Air- Conditioning System	8. Chemical tanks, make-up water tank and bleed-off water tank are found at the AC pump room at the South Open Forecourt.		
Installation (Cont'd)	9. 1 no. of chemical dosing pump is provided for chilled water and 3 nos. of chemical dosing pumps are provided for condensing water.		
	10. 2 nos. of blowdown water pumps are provided for the system.		
	11. A 50mm dia. fresh water supply for make-up usage is found (water meter no.: M18-451171).		
	12. Numbers of split type and window type airconditioning units are found.		
	13. Exhaust fans are installed for all plant rooms and toilets on each floor.		
Fire Services Installation	1. Automatic sprinkler system, fire hydrant and hose reel system, manual fire alarm system (MFA), visual fire alarm system (VFA) and automatic fire detection and alarm system (AFA) are installed in the Magistracy		
	2. A 80mm dia. F.S. water supply pipe is connected from the town main at Tai Po Road to serve the sprinkler system and F.S. system.		
	3. Fire hydrant and hose reel system		
	 a) 1 no. of 50mm dia. check meter position is provided for fire hydrant and hose reel system. 		
	b) 1 no. of 36m ³ reinforced concrete F.S. tank is located on the roof of F.S. and sprinkler pump room.		
	c) 2 nos. of fixed fire pumps (1 Duty & 1 standby, 30kW) with a jockey pump (1.5kW) are installed at the F.S. and sprinkler pump room.		
	d) F.S. inlets are installed at the exit of staircases ST-1 and ST-2.		

Building Services	Existing Provisions		
Fire Services Installation (Cont'd)	Automatic sprinkler system a) Automatic sprinkler system serves the whole magistracy except the plant rooms.		
	b) 1 no. of 80mm dia. check meter position is provided for sprinkler system.		
	c) The fire hazard of the Magistracy is classified as Ordinary Hazard Group I (OH I).		
	d) 1 no. of 47m ³ reinforced concrete sprinkler water tank is located on the roof of the F.S. and sprinkler pump room in the south open forecourt.		
	e) 2 nos. of sprinkler pump (1 Duty & 1 Standby, 15kW) with a jockey pump (1.1kW) are installed at the F.S. and sprinkler pump room.		
	f) Sprinkler inlet is installed next to the entrance at LG/F.		
	5. Fire extinguishers are provided inside the plant room.		
	6. Heat detectors are installed at the plant room.7. Emergency lighting and exit signs are installed inside the Magistracy.		
Electrical Installation	1. The electricity supply is provided by a CLP 1500kVA transformer in the transformer room at LG/F.		
	2. 1 no. of 2250A 4 pole air circuit breaker (ACB) is installed for protecting the whole system and is located at the main switch room at LG/F.		
	3. 100A TPN MCCB is provided for TBE room.		
	4. General lighting and power are provided in the Magistracy.		
	5. The emergency power is supplied by a 250kVA emergency generator at LG/F via a 400A 4 pole automatic changeover facility. The emergency power supplies to fire services installation and lift.		

Building Services	Existing Provisions		
Lift Installation	1.	There is a lift installed at the south of the building. The lift is used as fireman's lift and accessible lift.	
	2.	The rated capacity of the lift is 900kg.	
Security System Installation	1.	Closed circuit television system and door access control system will not be available inside the Magistracy.	
Plumbing Installation	2.	Potable Water Supply a) An existing 54mm dia. fresh water pipe with 40mm dia. water meter (meter no.: M13-228539) is provided for the Magistracy. The water meter is located in inside the water meter room at LG/F. The incoming water main is obtained from Tai Po Road. b) 1 no. of 4000L fibreglass potable water tank is installed at the fresh water pump room at LG/F. c) 2 nos. of potable water booster pump (flow: 14.4 m³/hr, pump head: 45m, power: 5.5kW) with 1 no. of 500L pressure vessels are installed at the fresh water pump room at LG/F. Flushing Water Supply a) Flushing water supply for the Magistracy is obtained from the 50mm dia. flushing water pipe from Tai Po Road. An existing 50mm dia. check meter position is provided for the Magistracy. b) The water check meter is located inside the water meter room at LG/F. c) 1 no. of 6000L fibreglass flushing water tank is installed at the flushing water pump room at LG/F. d) 2 nos. of flushing water booster pump (flow: 14.4 m³/hr, pump head: 35m cutin 45m cutout, power: 4kW) with 2 nos.	
		in 45m cutout, power: 4kW) with 2 nos. of 750L pressure vessels are installed at the flushing water pump room at LG/F.	

Building Services	Existing Provisions		
Plumbing Installation	3. Cleansing Water Supply		
(Cont'd)	 a) The cleansing water supply is teed off from the 54mm dia. potable water supply in the water meter room at LG/F. b) A 15mm dia. cleansing water meter (meter no.: M10-202123) is located in the water meter room at LG/F. c) 1 no. of 250L fibreglass cleansing water tank is installed at the fresh water pump room at LG/F. 		
	 2 nos. of cleansing water booster pump (flow: 1.44 L/s, pump head: 10m cut-in 20m cutout, power: 1.1kW) with 1 no. of 300L pressure vessels are installed at the fresh water pump room at LG/F. With reference to the record plan from the Buildings Department, 1 no. of waste water sump pump with 1 L/s and 9m Head is installed at the waste sump pit at AC plant room at LG/F. 		
Drainage Installation	1. Storm Water		
	 a) The rainwater on the roof of the building is discharged to down stacks leading to existing surface channels on ground or lower ground level of the site. 2. Foul Water 		
	a) The foul water from the building is discharged to the existing foul water manholes located inside the site and discharged to the government foul water manhole (FMH 4016510).		
	3. The location of the Drainage Services Department's (DSD) manholes and the existing terminal storm water manhole and foul water manhole in the site are shown in Appendix VI(B).		
Telecommunication	1. Fixed telecommunication network is available		
Facilities	on site.		

Building Services	Existing Provisions	
Gas Installation	1. With reference to the utility survey result,	
	there is an existing 80mm dia. underground	
	Town Gas pipe extended from Tai Po Road	
	and terminated at the south of the building.	
	2. Town gas is not used in the Magistracy.	

4.8.2 FS & Sprinkler Pump Room & Tank

Building Services	Existing Provisions
Mechanical Ventilation Installation	1. Exhaust fans are installed for all plant rooms.
Fire Services Installation	 Manual fire alarm system (MFA) and automatic fire detection and alarm system (AFA) are installed in plant rooms. Portable fire extinguishers are installed in plant rooms.
Electrical Installation	1. 1 no. of 250A TPN switch with 300A TPN busbar chamber is installed for F.S. pumps and sprinkler pumps. The electrical cables are connected from the Magistracy.
	2. Power supply for the AC system, including condenser water pumps, blow down water pump, cooling towers is connected from the Magistracy.
Drainage Installation	1. The rainwater on the roof of the building is discharged to down stacks leading to existing surface channels on ground level and then discharged to the existing government storm water drainage system.
	2. The floor drain for the plant rooms are discharged to the existing foul water manhole within the site and then discharged to the existing government foul water drainage system.

4.8.3 Open Forecourts

Building Services	Existing Provisions		
Electrical Installation	1. There is a lamp post in the North Open Forecourt.		
	2. No electrical installation is found in the South Open Forecourt.		
Plumbing Installation	 Potable Water Supply An existing 22mm dia. fresh water pipe, extended from the Magistracy, is provided for 6 nos. of water taps located next to the south entrance of the Magistracy. Cleansing Water Supply 		
	a) A cleansing water point is found next to the south entrance of the Magistracy.		
Drainage Installation	1. The surface rainwater of the slope proximity to the building is discharged to existing surface channels on ground or lower ground level.		
	2. The surface channels at north open forecourt are connected to the existing government storm water catch pit at north-west side of the site and storm water manhole at the footpath adjacent Tai Po Road.		
	3. The surface channels at south open forecourt are connected to the existing government storm water manhole at the footpath adjacent Tai Po Road.		

The building services reference drawings are provided in **Appendix VI(B).** The drawings were obtained from the previous user and may not reflect the actual site arrangement, the applicant shall check the correctness of these drawings before carrying out their design.

V. <u>Vicinity and Access</u>

5.1 Immediate Surrounding

The Former North Kowloon Magistracy is located at the western foot of a hillside beneath a service reservoir.

Within a few minutes' walk towards the south direction from the Magistracy is Mei Ho House, another historic building under Batch I of Revitalisation Scheme. Close to Mei Ho House is the public housing Shek Kei Mei Estate.

Adjacent to the site is the Saviour Lutheran School and Church. On its opposite side at Tai Po Road is a rest garden. Further away at Castle Peak Road and Sham Shui Po District is mainly for residential and commercial use.

The immediate surrounding is shown in the Location Plan at **Appendix I**

5.2 Access

Access to the Former North Kowloon Magistracy is shown in the Access Plan at **Appendix VIII**.

5.2.1 Vehicular Access

There are two existing vehicular accesses (both from Tai Po Road) with width of approximately 4.8m and 5.8m serving the two car parks on North Open Forecourt and South Open Forecourt of the building respectively.

5.2.2 Emergency Vehicular Access (EVA)

Fire engine can access the front facade of the building at Tai Po Road which served as an EVA to the building.

5.2.3 Loading and Unloading Area

No specific loading and unloading car parking spaces are located in the existing site.

5.2.4 Parking

Two open car parks are located at North Open Forecourt and South Open Forecourt of the building. 22 private car parking spaces, 8 motorcycle parking spaces and 1 accessible car parking space are provided at the open forecourts of the Magistracy.

5.2.5 Pedestrian Access

Pedestrian access to the Former North Kowloon Magistracy is available from Tai Po Road. It takes around several minutes to walk from the Former North Kowloon Magistracy to the nearest bus stop at Tai Po Road. Sham Shui Po MTR station is around 10 minutes' walking distance from the Magistracy.

5.2.6 Barrier Free Access (Site)

The barrier free access to the building is by means of vehicle to the south car park where an accessible parking space is available. An accessible lift is located at the south entrance lobby.

5.2.7 Refuse Collection Point

Refuse collection point is not provided on site according to the record plans of Buildings Department. The previous user converted a portion of open space at South Open Forecourt for temporary refuse collection and disposal.

VI. Conservation Guidelines

6.1 General Conservation Approach

- 6.1.1 All applicants are advised to give due regard to the latest editions of the Venice Charter (ICOMOS), the Burra Charter (Australia ICOMOS) and the Principles for the Conservation of Heritage Sites in China (ICOMOS China), which give the established international principles in heritage conservation in preparing their proposals for the conservation works.
- 6.1.2 We understand it will be a complex issue to strike a balance between maintaining the architectural authenticity of historic buildings and complying with the current statutory requirements under the Buildings Ordinance. On this issue, we would advise:
 - (a) when undergoing major alteration works and change of use, the historic building should be properly upgraded to meet the same level of safety in respect of the new use as in the case of new buildings. The need for preserving the significant architectural features (**Appendix IX** refers), site constraints or prohibitive upgrading cost may limit the type of use that may be chosen for the building; and
 - (b) every effort should be made to preserve the original facades of the historic building except unauthorized building structures, if any. Addition and alteration works, if necessary, should be undertaken at the back or other less visually prominent location of the building concerned. The original façades of the building should generally be left unaltered and must not be disturbed; i.e., no major external additions or alterations to the premises will be allowed, unless permitted under these Conservation Guidelines. External redecoration is restricted to design and colours that are compatible with the age and character of the building and the paint system is to be reversible¹. Any fixed signage should match the age and character of the external of the building(s) and is to be approved by the Antiquities and Monuments Office (AMO) prior to installation.
- 6.1.3 For the renovation works to comply with statutory building control requirements, the following general guidelines are given to the applicants for reference. However, they should not be treated as exhaustive and it is essential for the selected applicant to refer to the full requirements imposed by the relevant authorities in respect of their proposals, including Buildings Department, Fire Services Department, Drainage Services Department, etc.

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¹ "Reversibility" is an act or process which can be undone or removed at a later date without causing material injury, loss, damage or change to the historic site or the historic building as the case may be.

Possible Building Works	Conservation Guidelines
a) Means of Escape (MOE)	Any improvement works recommended to doorway openings, steps, etc. must respect the historical integrity of the building(s), and carry out at less prominent area. The existing provision of MOE staircase should be reused as far as practicable.
b) Natural Lighting and Ventilation	Alteration or enlargement of any original windows or provision of any new window openings must respect the historical integrity of the building(s), and carry out at less prominent area.
c) Barrier Free Access	Any proposed access improvement for persons with disability must respect historical integrity of the building and its surrounding, in particular the external elevation(s) of the building. The existing provisions of barrier free access, accessible lifts and accessible toilets should be reused as far as practicable.
d) Fire Resisting Construction to Floors, Doors, Walls and Staircase	Any necessary upgrading works proposed to meet current requirements must respect the historical integrity and materials of the element concerned, which will probably be required to be retained in-situ.
e) Floor Loadings	Any proposed upgrading works necessary to meet "change of use" requirements must respect the historical integrity and materials of the floor concerned. Advice of Registered Structural Engineer should be sought.

Possible Building Works	Conservation Guidelines		
f) Building Services	Any proposed upgrading of electrical supply air conditioning, fire services and plumbing installations should ensure that no "non reversible" works are carried out to the historic building. The existing provisions of building services system should be reused as far as practicable.		
g) Plumbing and Sanitary Fitments	No existing fittings are considered to be "historic features" and therefore they may be re-used, replaced or increased in number as required.		
h) Sewage, Drainage System and Waste Disposal Facilities	All drainage services that are to be retained should be checked and overhauled as necessary; the capacity of the existing system and adequacy of authorised waste disposal methods should also be confirmed and upgraded as necessary.		

- 6.1.4 The conditions of each historic building are unique. As such, the problems encountered in the renovation works of each historic building should be tackled on a case-by-case basis. If compliance with the conservation requirements as listed in these Conservation Guidelines cannot be achieved because of statutory requirements arising from the proposed adaptive re-uses, AMO's approval should be sought.
- 6.1.5 As the renovation works will inevitably cause impact on the historic building, the selected applicant should submit a Heritage Impact Assessment (HIA) to the AMO for agreement before the commencement of the works. Consultation with the Antiquities Advisory Board for the agreement would be necessary.
- 6.1.6 The selected applicant should engage a building contractor, for the renovation works, who is included in the Development Bureau's "List of Approved Contractors for Public Works – Buildings category" of appropriate group according value the works the estimated of contract (https://www.devb.gov.hk/Contractor.aspx?section=80&lang=1 for the list) and a **Buildings** Registered General Building Contractors of Department (https://www.bd.gov.hk/en/resources/online-tools/registerssearch/registrationsearch.html?reg type=GBC for the list). If the contractor to be appointed for the renovation works is not itself an approved specialist contractor included in the "List of Approved Suppliers of Materials and Specialist

Contractors for Public Works – Repair and Restoration of Historic Buildings category" (RRHB specialist contractor), the appointed contractor must engage a RRHB specialist contractor from the Approved List as its specialist subcontractor for carrying out the repair and restoration works of the "Architectural Features to be Preserved" to the historic building. All other specialist subcontractors for the renovation works should also be engaged from the relevant categories/groups in the Development Bureau's "List of Approved Suppliers of Materials and **Specialist** Contractors for Public Works" (http://www.devb.gov.hk/en/construction sector matters/contractors/supplier/ind ex.html for the list).

6.2 Specific Conservation Requirements

- 6.2.1 Former North Kowloon Magistracy sits on Tai Po Road witnesses the post-war historical development of Sham Shui Po area. Besides, the building had continued to serve as a magistracy building for over 44 years, witnessing the judicial development of Hong Kong, and is strongly associated with the law and order in Hong Kong. These historical and social significances, together with the architectural significance of being a representative example of civic building in Stripped Classical Style built in the 1960s should be properly interpreted within the site.
- 6.2.2 The Magistracy comprises seven storey with two open forecourts on the south and north sides of the historic building. Originally, it was functioned as magistracy and was divided into three functional zones serving general public and staff, magistrates, and defendants/ prisoners which have independent circulation access. Staircases and lifts were provided separately to serve different zones.
- Adaptive works were carried out to convert the Magistracy into SCAD (Hong 6.2.3 Kong) in the 2010. The external elevations had been retained and preserved. Internal area was repartitioned to suit functional needs, with a few key character defining elements with high level of significance were retained and conserved. For instance, the central circulation area, i.e. the central staircase and halls from G/F to 2/F had been retained. The configuration of the five out of six numbers of detention cells and the adjoining control corridor located on G/F was retained. While one detention cell was preserved in-situ for public interpretation, and the remaining four detention cells were adaptive reused with minor alterations as administration offices and machine rooms. Court Room No. 1 located on 2/F was preserved in-situ with all the original timber furniture, setting and fittings, while the remaining three large court rooms on 2/F were adaptive reused as classrooms or studio facilities installed with lower false ceiling height. Parts of the original staircases representing the independent circulation for each functional zone were retained for interpretation. Some staircases were modified

- to fulfil statutory requirements or to suit operation need, and one of the original lift shafts was rebuilt to suit circulation purpose.
- 6.2.4 Conservation principles, such as removal of interventions previously made and restoration of the character-defining elements to suit the new adaptive reuse as far as practicable, should be considered which would further bring out the original heritage value of the historic building.
- 6.2.5 Further adaptive reuse works to be proposed should preserve in-situ not less than the existing extent of the preserved significant historic features. As the facade design in Stripped Classical Style is a representative example of civic architecture of the period, it should be generally kept intact. Internal elements which contribute characters of a jurisdiction building such as the retained Court Room No.1, the retained detention cells with the adjoining control corridor, and the retained representative independent circulation staircases for each zone should be kept intact. To better express the original design of the historic building, the original spatial configuration of the other three large court rooms on 2/F with the original double height design should also be exposed in further adaptive reuse works as far as practicable.
- 6.2.6 Management approach had been adopted in previous statutory submissions to the Buildings Department to strike a balance between complying the prevailing statutory requirement and maintaining the architectural authenticity of the historic building. Adoption of similar approach to preserve in-situ the significant historic features of the historic building is recommended.
- 6.2.7 A number of character defining elements must be preserved in-situ and maintained as necessary. They are listed at **Appendix IX**. Their corresponding required and recommended conservation treatments are listed at **Appendix X** and **XI** respectively.
- 6.2.8 Every effort should be made to carry out all "required treatment" set out at **Appendix X** of the Conservation Guidelines. If compliance with the "required treatment" cannot be achieved, justifications should be given to the AMO for their consideration. **Appendix XI** of the Conservation Guidelines set out the "recommended treatment" to the historic building, which should be carried out as far as practicable.

VII. Town Planning Issues

- 7.1 The Former North Kowloon Magistracy site is mainly zoned "Government, Institution or Community" ("G/IC") and with the south east corner within the "Green Belt" ("GB") on the Shek Kip Mei Outline Zoning Plan (OZP) No. S/K4/29. The full set of the OZP including the plan, Notes and Explanatory Statement is available at the Town Planning Board's (TPB's) website (http://www.info.gov.hk/tpb/). Relevant extract of the OZP and Notes for the "G/IC" zone are shown at **Appendix XII.**
- 7.2 The planning intention of the "G/IC" zone is primarily for the provision of Government, institution or community facilities serving the needs of the local residents and/or a wider district, region or the territory. It is also intended to provide land for uses directly related to or in support of the work of the Government, organizations providing social services to meet community needs, and other institutional establishments.
- 7.3 The Notes for the "G/IC" zone (**Appendix XII**) set out the uses or developments that are always permitted (the "Column 1" uses) and those requiring permission from the TPB (the "Column 2" uses). The application for Column 2 uses should be made to the TPB under section 16 of the Town Planning Ordinance. If the use proposed by an applicant is not in Column 1 or Column 2, an application for amendment of the zoning on the OZP under section 12A of the Town Planning Ordinance will be required to be submitted to the TPB for consideration. Also, there is height restriction of not exceeding 7 storeys on any structure or building unless with the prior consent of the Planning Department.
- 7.4 Prior to the submission of an application, advice could be sought from the Tsuen Wan & West Kowloon District Planning Office of the Planning Department at 27/F, Tsuen Wan Government Offices, 38 Sai Lau Kok Road, Tsuen Wan, New Territories (Tel: 2417 6658 Fax: 2412 5435).
- 7.5 All applications for permission under section 16 of the Town Planning Ordinance will be considered by the TPB within two months of their receipt. The TPB may reject or approve an application, with or without conditions. The applicant will be notified of the TPB's decision after confirmation of the minutes of the meeting at which the decision is made (normally two weeks after the meeting).

VIII. Land and Tree Preservation Issues

8.1 Land Issues

A Site Boundary Plan is shown at Appendix II.

According to the Permanent Land Allocation (GLA-NK 757) to Development Bureau by the Lands Department, parking /loading and unloading of motor vehicles to meet operational requirements shall be provided to the satisfaction of the Commissioner for Transport. The selected applicant shall review the parking spaces required for the proposed design and submit drawings for the approval of sthe appropriate authorities/government departments.

Ingress or egress to or from the site for passage of motor vehicles shall be limited to the vehicular run in/out facing Tai Po Road at the north side and south side of the site unless approved in writing by the District Lands Officer.

Concrete production and burning of debris or other materials are prohibited on the site.

Any proposed new structure or building to be erected on the site, or addition to the existing structures and buildings shall be agreed with the District Lands Officer and the Antiquities and Monuments Office before commencement in accordance with Clause 1 and 37 of the Engineering Conditions.

8.2 Tree Issues

Based on the tree survey schedule prepared in May 2020, there are currently 81 trees located in the vicinity of the site in which 58 trees are located within the site boundary. Old and Valuable Tree (OVT) in the OVT Register maintained by the Leisure and Cultural Service Department (LCSD) is not present within the site. Trees surveyed in the vicinity of the site are tagged with Tree Number T1 – T81. A tree schedule, depicting the conditions and value of trees, is shown at **Appendix XIV**.

In general, no tree growing on the site shall be interfered without the prior written consent of the District Lands Officer and the AMO or the appropriate authorities who may, in granting consent, impose such conditions as to transplanting, compensatory landscaping or replanting as appropriate.

The selected applicant shall be responsible for the horticultural maintenance of vegetation and maintenance of trees within the site.

IX. Slope Maintenance

Accordance to the Systematic Identification of Maintenance Responsibility of Slopes in the Territory (SIMAR) Unit, there are four slope features within and adjoining the site. Information on the slope features as on 4 June 2020 and the details are summarised below and shown in **Appendix XV.** The conditions of the features require further assessment by the selected applicant.

Slope Feature 1:

Slope	Sub-	Location	Responsible	Maintenance
Number	division		Party	Agent
11NW-B/C66	-	Within and	Development	Architectural
		Adjoining GLA-	Bureau	Services
		NK757		Department

Slope Feature 2:

Slope	Sub-	Location	Responsible	Maintenance
Number	division		Party	Agent
11NW-	-	Within GLA-	Development	Architectural
B/C577		NK757 &	Bureau	Services
		Government Land		Department
		near South Corner		

Slope Feature 3:

Slope	Sub-	Location	Responsible	Maintenance
Number	division		Party	Agent
11NW-	1	Partly within GLA-	Development	Lands
B/CR67		NK 757, GLA-NK	Bureau	Department
		739 and unallocated		
		Government land		
		adjoining NKIL		
		4456 & EXT		
		THERETO		
11NW-	2	Partly within GLA-	Lands	Lands
B/CR67		NK 757, GLA-NK	Department	Department
		739 and unallocated		
		Government land		
		adjoining NKIL		
		4456 & EXT		
		THERETO		

11NW-	3	Partly within GLA-	NKIL 4456 &	Not
B/CR67		NK 757, GLA-NK	EXT	Applicable
		739 and unallocated	THERETO	
		Government land		
		adjoining NKIL		
		4456 & EXT		
		THERETO		
11NW-	4	Partly within GLA-	Leisure and	Architectural
B/CR67		NK 757, GLA-NK	Cultural	Services
		739 and unallocated	Services	Department
		Government land	Department	
		adjoining NKIL		
		4456 & EXT		
		THERETO		

Slope Feature 4:

Slope	Sub-	Location	Responsible	Maintenance
Number	division		Party	Agent
11NW-B/R168	-	Within GLA-NK	Development	Architectural
		757, SCAD (Hong	Bureau	Services
		Kong)		Department

The selected applicant should allow the Government or its representatives to gain access to the slope features concerned to carry out required slope maintenance works. Should the selected applicant's proposal for adaptive re-use of the site of this Revitalisation Project affects the existing registered/non-registered slope features, geotechnical assessment and/or corresponding slope upgrading works as required by the Building Authority and other government departments should be carried out by the selected applicant to suit his proposal. The selected applicant shall be responsible at their own cost for any necessary upgrading, repair and maintenance of the registered/non-registered slope features affected by the revitalisation works.

The selected applicant should consult the relevant government departments, such as the Building Department, Geotechnical Engineering Office of Civil Engineering and Development Department to ensure all the slopes and retaining walls are stable with respect to the revitalisation proposal.

Any slope upgrading works should not alter the existing external appearance of the buildings within the site of this Revitalisation Project or cause adverse impact on the stability of any slopes and structures within or in the vicinity of the site of this Revitalisation Project.

X. <u>Technical Compliance for Possible Uses</u>

10.1 Uses that could Possibly be Considered

Possible adaptive re-use of this building includes:

- (a) Educational Institution;
- (b) Eating Place;
- (c) Place of Recreation; and
- (d) Research, Design and Development Centre.

The technical feasibility of each case will need to be further examined. Applicants are welcome to come up with suggestions on possible uses that they consider to be the most suitable for the site of the Revitalisation Project. Application should make reference to the "Definition of Terms" under the Town Planning Board's web site to ascertain the technical feasibility, including the structural adequacy and conservation requirements, of their proposed uses.

10.2 Technical Considerations

Technical considerations to be given due regard include:

(a) Compliance with the requirements under the Buildings Ordinance. These requirements include but are not limited to:

Requirements	Remarks
1. Means of escape	Upgrading works may include, but not limited to, the provision of staircases with consideration of discharge values and width of staircases. The applicants should make necessary modification for the proposed use in compliance with the Code of Practice for Fire Safety in Buildings 2011.
2. Fire resisting construction	Upgrading works might be required for the new fire compartment or separation of different uses to comply with the Code of Practice for Fire Safety in Buildings 2011.
3. Means of access for fire fighting and rescue	Means of access for fire fighting and rescue, including fireman's lift and EVA, has been provided under the conversion of Batch I of the Revitalisation Scheme in 2010. For the possible uses stated in Section 10.1, the existing provision of means of access are generally complied. The applicants shall review and consider

Requirements	Remarks
	any upgrading work is required for alteration of the layouts to suit the future use.
4. Barrier-free access and facilities	Accessible lift, ramps, accessible toilet etc. were provided under Batch I of the Revitalisation Scheme in 2010. Notwithstanding the barrier free access and facilities has been provided, the applicant should from time to time review the facilities in order to comply with the Design Manual: Barrier Free Access 2008.
5. Protection against falling from height	Upgraded balustrades and protective barrier were provided under Batch I of the Revitalisation Scheme in 2010. The applicants shall review and follow the condition of modification granted from the Buildings Department in 2010. Upgrading works or further application of approval might be required from Buildings Department to suit the proposed usage.
6. Structural adequacy	Detail structural investigation (i.e. comprehensive structural appraisal) shall be carried out to ensure the stability of all the building elements. Strengthening works may be required depending on the findings of structural investigation and the proposed uses.
7. Fire services installation requirements	Fire services installations were provided under Batch I of the Revitalisation Scheme in 2010. The fire services installations should comply with the current edition of "Code of Practice for Minimum Fire Service Installations and Equipment" and "Code of Practice for Inspection, Testing and Maintenance of Installations and Equipment" under the Fire Services Department.
8. Natural lighting and ventilation	Artificial lighting and mechanical ventilation was provided for toilets and office to the Magistracy under Batch I of the Revitalisation Scheme in 2010. For subsequent alteration and addition works (i.e. addition of kitchen), such works should comply with Building (Planning) Regulations. The Building Authority will

Requirements	Remarks
	give consideration to an application for modification from the provision of the Buildings Ordinance for site constraints by conservation of the building.
9. Provision of sanitary fitments	Male, female and accessible toilet were provided in the Magistracy. Notwithstanding the sanitary fitments has been provided, the applicants shall review the provision of sanitary fitment for the proposed use in order to comply with Building (Standards of Sanitary Fitments, Plumbing, Drainage Works and Latrines) Regulations.
10. Drainage Installation	There are existing foul and storm water drainage system connection to the government sewer and storm water system. The existing capacity of foul water drainage system may need to be reviewed to suit the proposed use. The Eating Place such as canteen is required to install grease trap before discharging to the communal sewers. The requirements of grease trap should comply with the instructions from the Food and Environmental Hygiene Department and Environmental Protection Department.

- (b) Compliance with licensing requirements (for uses requiring issue of licence for their operation);
- (c) Compliance with planning requirements (Approval by the TPB is required for any proposed uses not falling under Column 1 in the Notes to the OZP); and
- (d) Compliance with Conservation Guidelines (see **Section VI** of this resource kit.

The technical aspects listed above might not be exhaustive. Applicants should pay attention that they may need to address other technical considerations in preparing their proposals. They may make reference to guidelines stated in PNAP APP-69 and Practice Guidebook for Adaptive Reuse of and Alteration and Addition Works to Heritage Buildings 2012 (2019 Edition) at the website of Buildings Department (www.bd.gov.hk).

10.3 Further Information on Possible Uses

For illustration purpose, preliminary study has been carried out for uses listed in paragraph 10.1 above. Some information that can be useful to the applicants are listed below:

(a) Heritage Conservation

Application shall follow the Conservation Guidelines listed in **Section VI** of the Resource Kit when resolving technical issues.

(b) Planning

Examples of uses in paragraph 10.1 are under Column 1 of the Notes to the OZP under Government, Institution or Community that are always permitted. Applicants shall aware any update to the outline zoning plan and notes from the TPB.

(c) Emergency Vehicular Access (EVA)

An existing EVA complying the requirements stipulated in Section 6, Part D of Code of Practice for Fire Safety in Buildings 2011 demonstrated under the conversation of the Batch I of the Revitalisation Scheme. Review is required to comply with the current requirements under the proposed use.

(d) Licensing

- (i) If the site of this Revitalisation Project is to be used as an educational institution, the selected applicant is required to check whether the proposed mode of operation falls within the definition of a 'school' under the Education Ordinance (Cap. 279). If affirmative, the selected applicant shall make an application for registration of a school to the Education Bureau (EDB). Relevant information on registration procedures is available at the website of EDB (http://www.edb.gov.hk).
- (ii) If food and beverage services are to be provided, the selected applicant shall make an application to FEHD if he intends to carry out any food business which involves, generally, the sale of meals or unbolted nonalcoholic drinks other than Chinese herb tea for consumption on site of this Revitalisation Project. Relevant information on application procedures and forms can be downloaded from the FEHD website

(http://www.fehd.gov.hk/english/licensing/index.html).

(iii) If the site of the proposed use is to be used as an exhibition hall or

place of recreation/ entertainment, the selected applicant should obtain a license from the Food and Environmental Hygiene Department (FEHD) if he intends to carry out:

- (a) Any exhibition of any one or more of the followings, namely
- (b) pictures, photographs, books, manuscripts or other documents or
- (c) other things;
- (d) A sporting exhibition;
- (e) A cinematograph or laser projection display.

For details on the application of places of public entertainment license for places other than cinemas and theatres and related matters, the applicant can visit the website of FEHD.

(http://www.fehd.gov.hk/english/licensing/index.html).

(e) Structural Loading Requirement

The minimum uniformly distributed imposed loads as stipulated in the Building (Construction) Regulations (B(C)R) by the Buildings Department for the possible uses area are as follows:

Uses that could possibly be considered	Minimum Imposed Loads (kPa)	B(C)R Class No.	Usage stated in B(C) R
Education Institution	3.0	3	Classrooms, lecture rooms, tutorial rooms, computer rooms and reading rooms without book storage
Eating Place	4.0	3	Restaurants, lounges, bars and fast food shops
Place of Recreation	3.0	3	Leisure, recreational and amusement areas that cannot be used for assembly purposes
Research, Design and Development Centre	3.0	2	Laboratories, light workrooms with neither central power-driven machines nor stage.

10.4 Recurrent Expenditure

To facilitate the applicants in forecasting their operation expenses, we have estimated the respective expenditure on some common recurrent items, including electricity fee, water and sewage charge, rates and rent for the building at **Appendix XVI** for reference. Please note that the estimated expenditure has been made on the basis of some possible uses with assumptions, and are for reference only. Applicants are advised to make necessary adjustments with regard to their own proposals and specific operational requirements.

XI. Special Requirements of the Project

Applicants are required to take the special requirements into account in formulating their proposals and explain in their applications how the requirements have been incorporated in their proposals.

11.1 Grand Double Staircase and Central Staircase

Modifications to Building (Construction) Regulations were granted by Buildings Department in 2010 for the protective barrier of Grand Double Staircase and Central Staircase. The modification was given in recognition of the undertaking by SCAD (Hong Kong).

The Grand Double Staircase, the Central Staircase and adjoining Entrance Hall and Lobby/Student Resting Areas (Central Halls) should be used in a manner as indicted on the approved plans by Buildings Department and the said undertaking letter. For the proposed change of use on the building, the selected applicant is required to enter a new application of the proposal (i.e. feasible and enforceable management plan with justifications and undertaking), obtain all necessary approval from the relevant authorities without alteration to the existing ornamental ironwork balustrades of the Grand Double Staircase. For the Central Staircase, upgrading works to the existing handrails and balustrades should be avoided.

11.2 FS & Sprinkler Pump Room & Tank and Temporary Structure

The FS & Sprinkler Pump Room & Tank and the Temporary Structure located at the South Open Forecourt do not fall within the historic building grading boundary. The FS & Sprinkler Pump Room & Tank was constructed under the Batch I of the Revitalisation Scheme and are the plant rooms serving for the Magistracy. The Temporary Structure was constructed before the Batch I of the Revitalisation Scheme and its area was included into the Site Coverage and/or Plot Ratio Calculation as non-domestic area under the Batch I revitalisation works. The Temporary Structure and the outdoor sitting area were previously used by SCAD (Hong Kong) as office and reception area for potential students and their visitors.


If the selected applicant would like to use the Temporary Structure, he is required to enter a new application of the proposal, ensure the structural stability of the Temporary Structure, and obtain all necessary approval from the relevant authorities, including but not limited to the Buildings Department, Town Planning Board, AMO etc. The proposal should also comply with all relevant Ordinances, including but not limited to the Buildings Ordinance (Cap. 123) and the Town Planning Ordinance (Cap. 131).

Demolition of the Temporary Structure with or without construction of above-ground and/or below ground new structure(s) on the area to provide additional space in support of the provision of services by the social enterprise may be allowed. Such new structure(s), if any, should be constructed primarily for supporting the adaptive reuse of existing historic building with minimum intervention to it. In doing so, the applicants should strive to utilise the existing historic building for their main social enterprise operation and observe the following requirements in designing the new structure(s), if any:

- (a) The Former North Kowloon Magistracy being a Grade 2 Historic Building of unique heritage value, the design of the new structure should deliver the objective of achieving compatibility with, and not being visually intrusive to, the existing building and setting of the building form. The scale of the new structure should be commensurate with the intended purpose of use and in proportion with the existing building without overwhelming the latter;
- (b) The applicants should observe the building height restriction, maximum plot ratio and site coverage as stipulated in the Building Ordinance, the Outline Zoning Plan and the Permanent Land Allocation;
- (c) The applicants should also observe the requirements as stipulated in Item 1.4 of the **Appendix X** of Conservation Guidelines. The ultimate height of structure, if any, should be visually screen off by the natural landscape of trees facing Tai Po Road, and without causing adverse visual impact to the historic building.
- (d) Any proposed new structure or building to be erected on the site, or addition to the existing structures and buildings shall fulfill statutory requirements and shall be agreed with the appropriate authorities, including the District Lands Officer, Planning Department, Buildings Department and AMO before commencement of any on-site works.


Appendix I

Location Plan

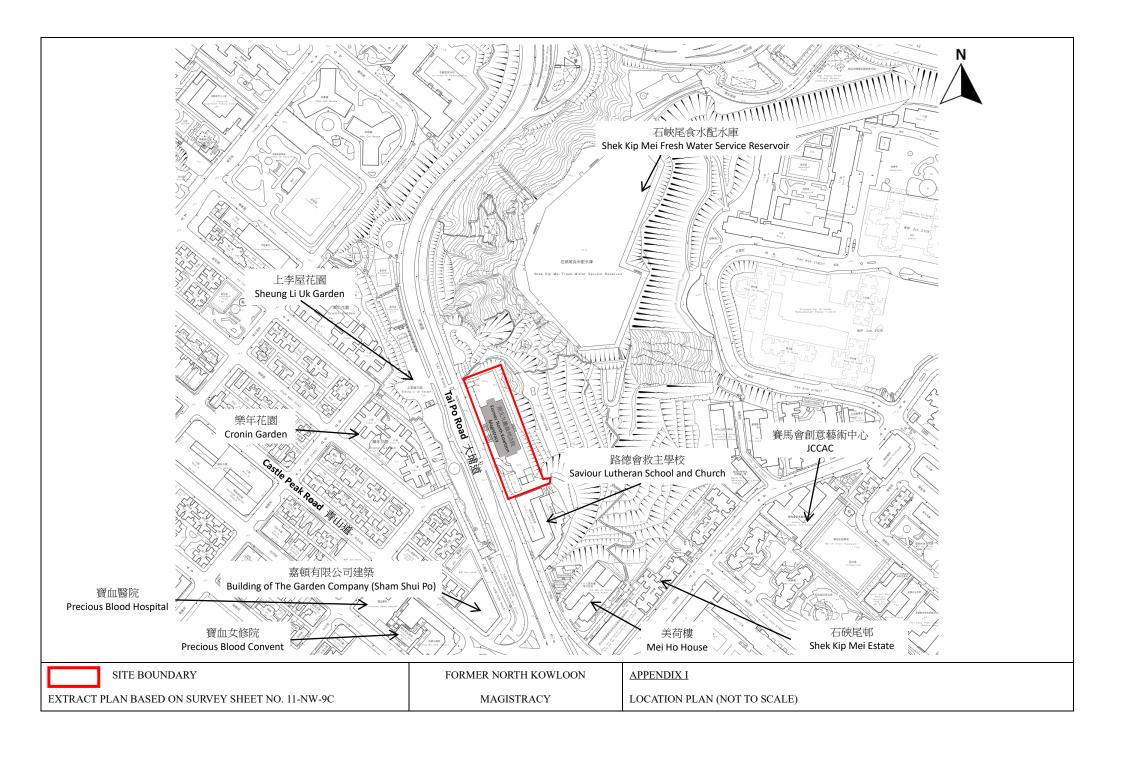

Appendix II

Site Boundary Plan

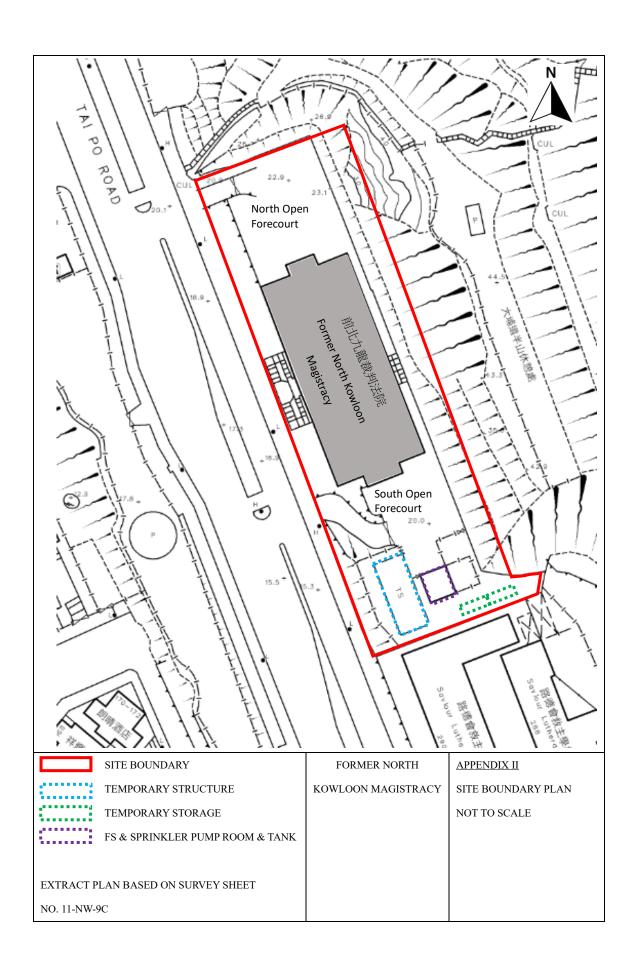


Appendix III

Historic Building Grading Boundary Plan




香港文物地理資訊系統 Geographical Information System

eographical Information System on Hong Kong Heritage

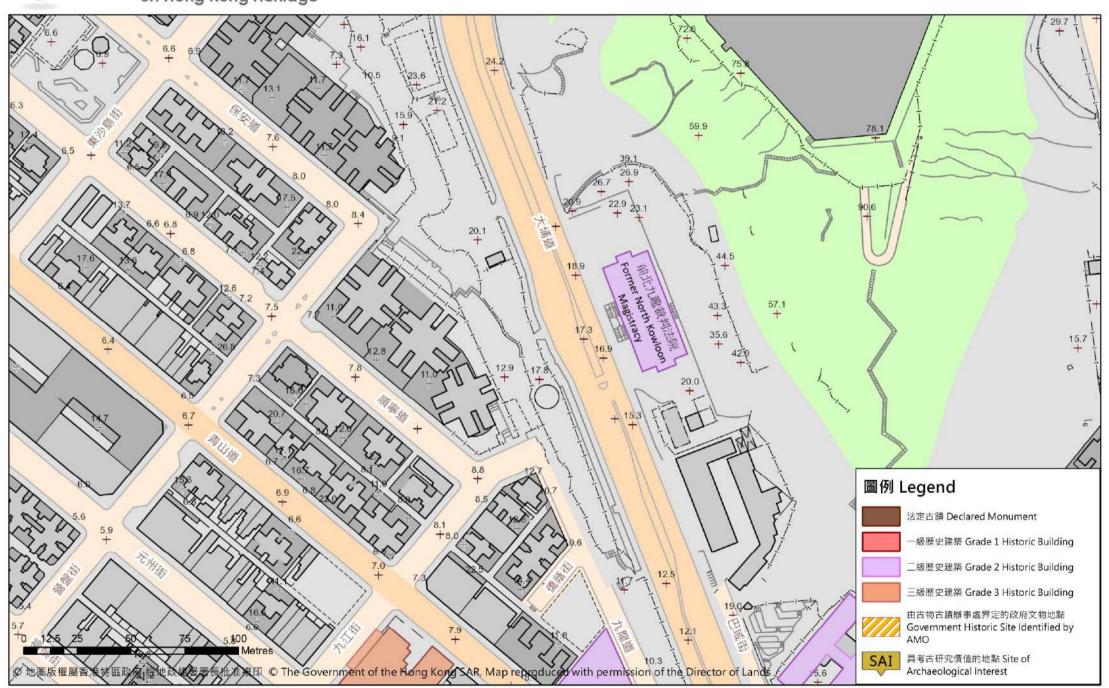

Appendix IV

Datum Levels Plan

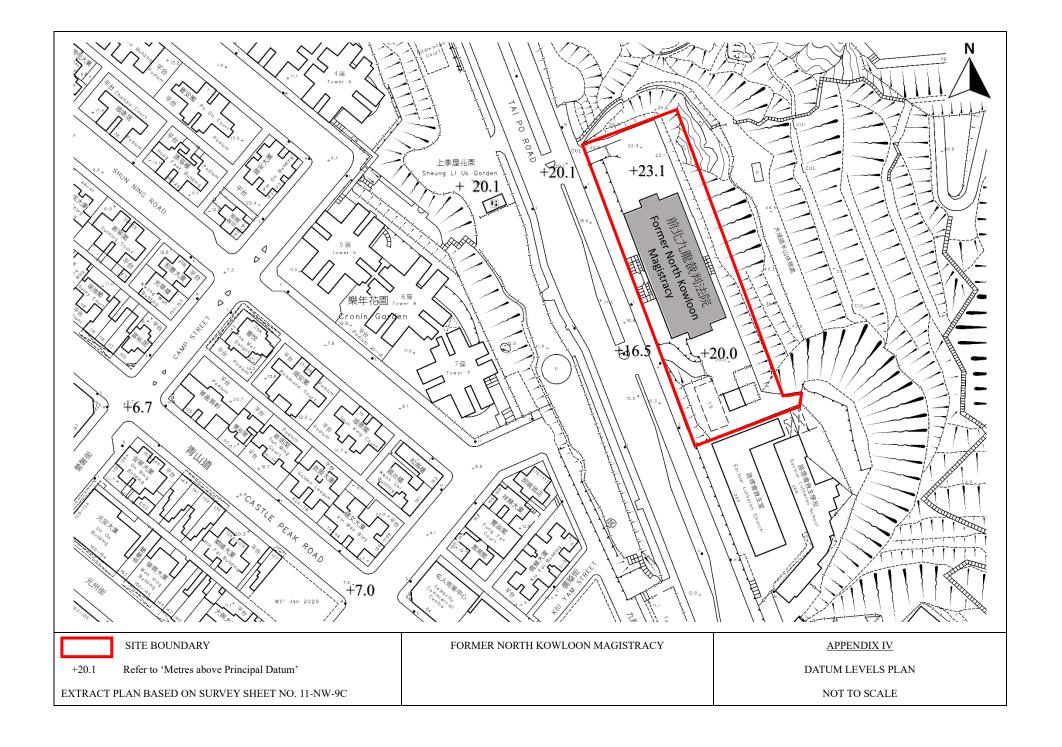

Appendix V

Summary of Site and Building Information

Summary of site information is listed below:

Site	Former North Kowloon Magistracy
Address	292 Tai Po Road, Kowloon
Site Area	Approximately 4,815 sq. m
Major Datum Level	Range from around +16.5mPD to +23.1mPD
Zoning	Government, Institution or Community
	(Majority of the site area)

Summary of building information is listed below:


Number of Blocks (Permanent Structure)	2 (Former North Kowloon Magistracy, FS & Sprinkler Pump Room & Tank)
Year of Completion	- 1960 for Former North Kowloon Magistracy - 2010 for FS & Sprinkler Pump Room & Tank
Gross Floor Area	Approximately 7673 sq. metres
Historic Grading	Grade 2 Historic Building (excluding the FS & Sprinkler Pump Room & Tank)
Original Use	Magistracy
Recent Uses	Educational Institution Savannah College of Art and Design (SCAD) Hong Kong was operated by the SCAD Foundation (Hong Kong) Limited since September 2010 under Batch I of the Revitalising Historic Buildings Through Partnership Scheme and will be suspended in operation in July 2020

Appendix VI(A)


Building Drawings

Appendix VI(A) – Building Drawings <u>Drawing List</u>

	Drawing No.	Drawing Title
1.	NK-01	Block Plan
2.	NK-02	Lower Ground Floor Plan
3.	NK-03	Ground Floor Plan
4.	NK-04	First Floor Plan
5.	NK-05	Second Floor Plan
6.	NK-06	Third Floor Plan
7.	NK-07	Fourth Floor Plan
8.	NK-08	Fifth Floor Plan
9.	NK-09	Roof Plan
10.	NK-10	Section A-A
11.	NK-11	Section B-B
12.	NK-12	West Elevation
13.	NK-13	South Elevation
14.	NK-14	East Elevation
15.	NK-15	North Elevation

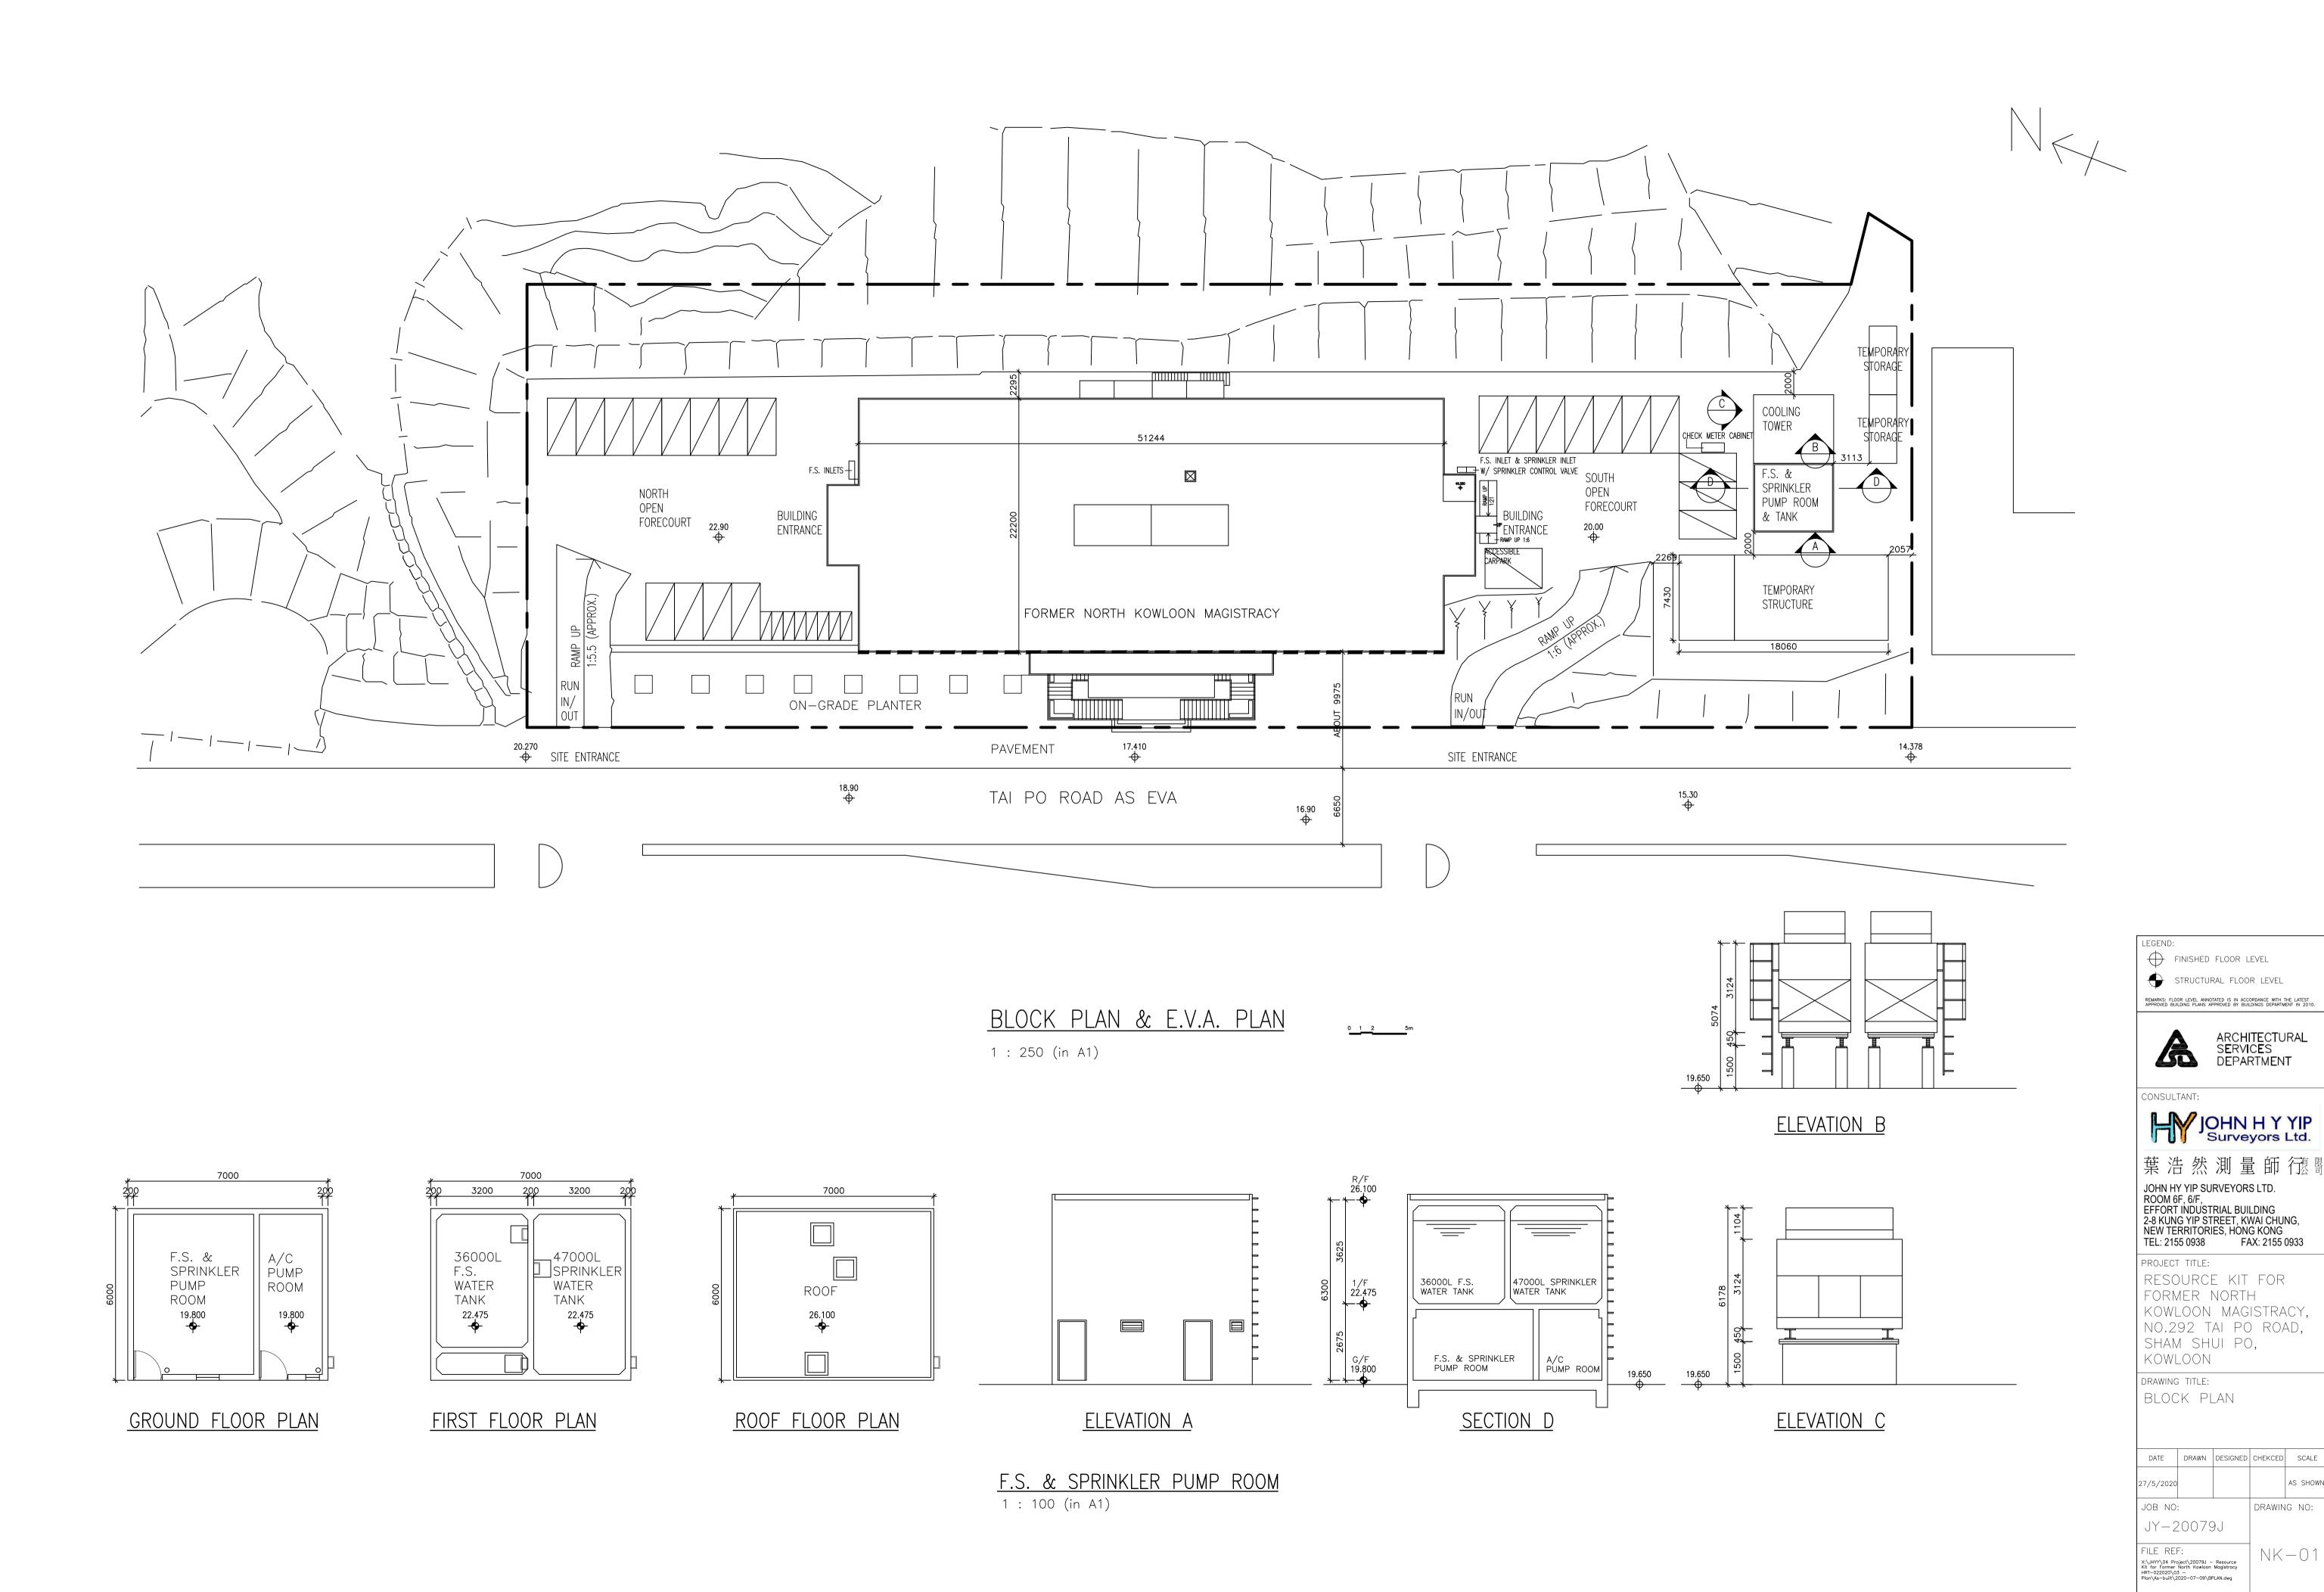

AS SHOWN

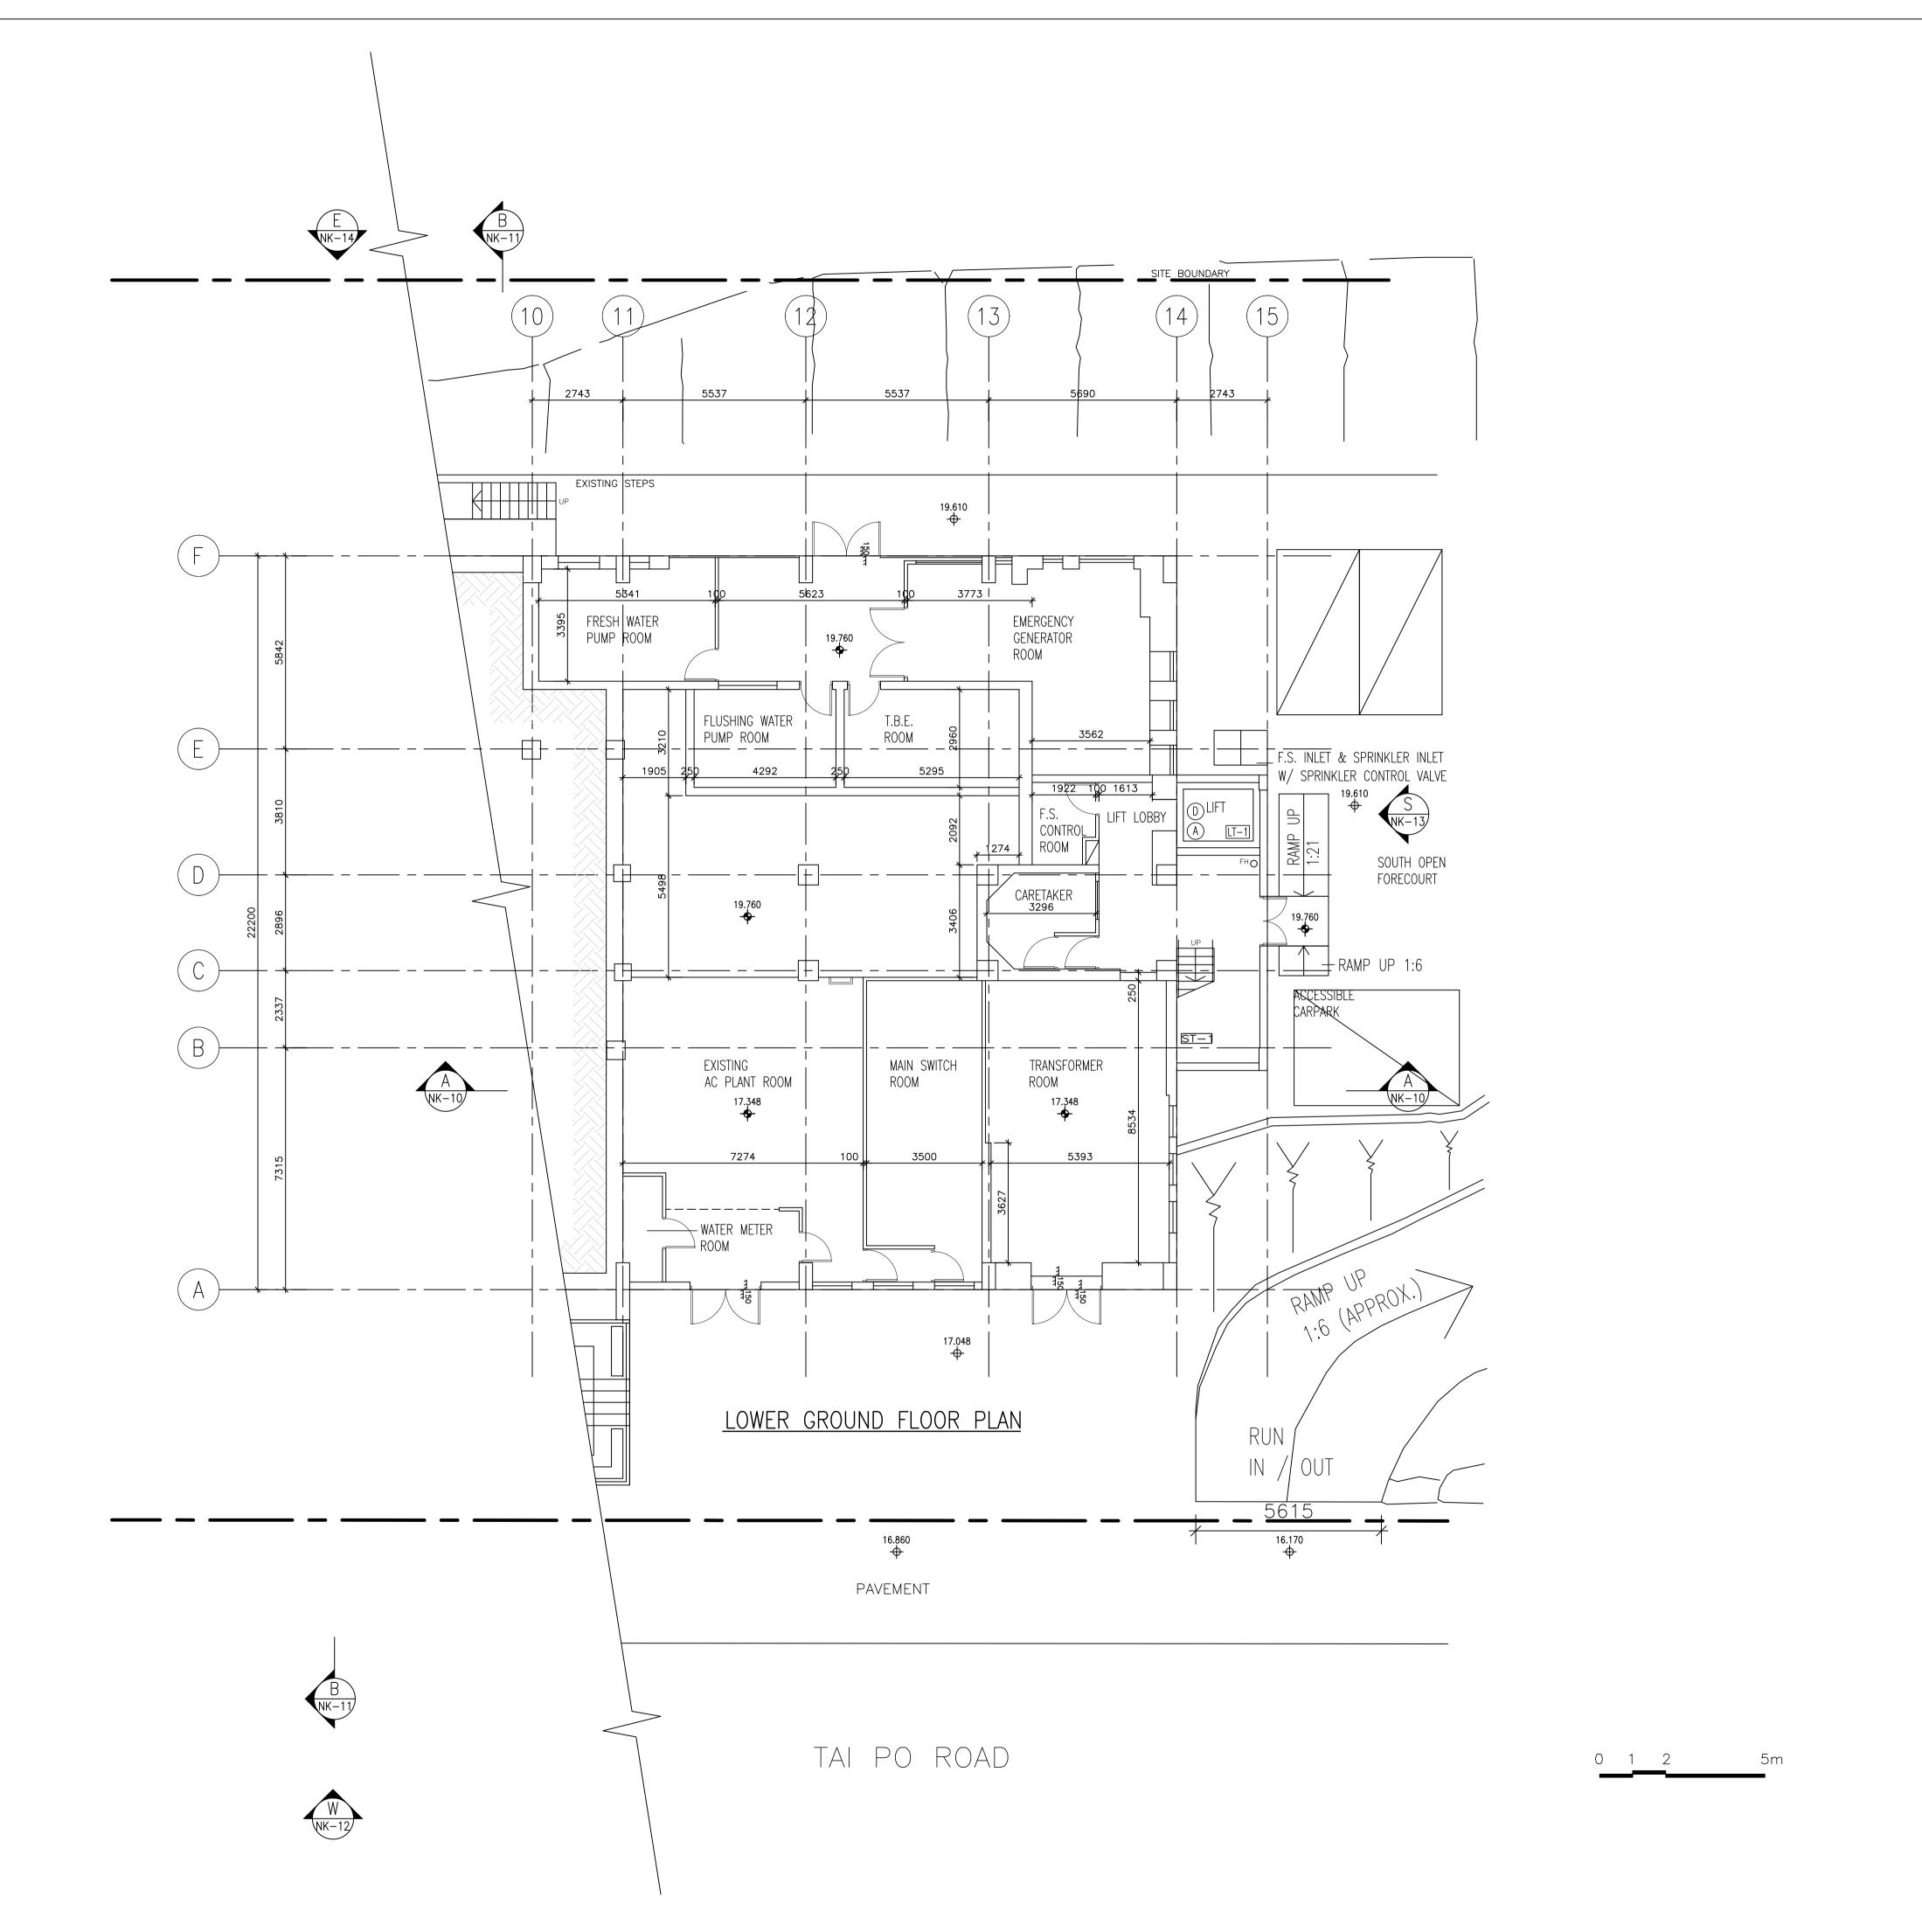

FINISHED FLOOR LEVEL STRUCTURAL FLOOR LEVEL

REMARKS: FLOOR LEVEL ANNOTATED IS IN ACCORDANCE WITH THE LATEST APPROVED BUILDING PLANS APPROVED BY BUILDINGS DEPARTMENT IN 2010. ARCHITECTURAL SERVICES DEPARTMENT



JOHN H Y YIP Surveyors Ltd.

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ROOM 6F, 6/F,
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2-8 KUNG YIP STREET, KWAI CHUNG,
NEW TERRITORIES, HONG KONG
TEL: 2155 0938 FAX: 2155 0933


PROJECT TITLE: RESOURCE KIT FOR FORMER NORTH KOWLOON MAGISTRACY, NO.292 TAI PO ROAD, SHAM SHUI PO, KOWLOON

DRAWING TITLE: LOWER GROUND FLOOR PLAN

DATE DRAWN DESIGNED CHEKCED SCALE 1:100 (in A1) DRAWING NO: JOB NO:

NK-02

JY-20079J FILE REF: X:\JHYY\04 Project\20079J - Resource Kit for Former North Kowloon Magistracy HRT-022020\03 - Plan\As-built\2020-07-09\LGF.dwg

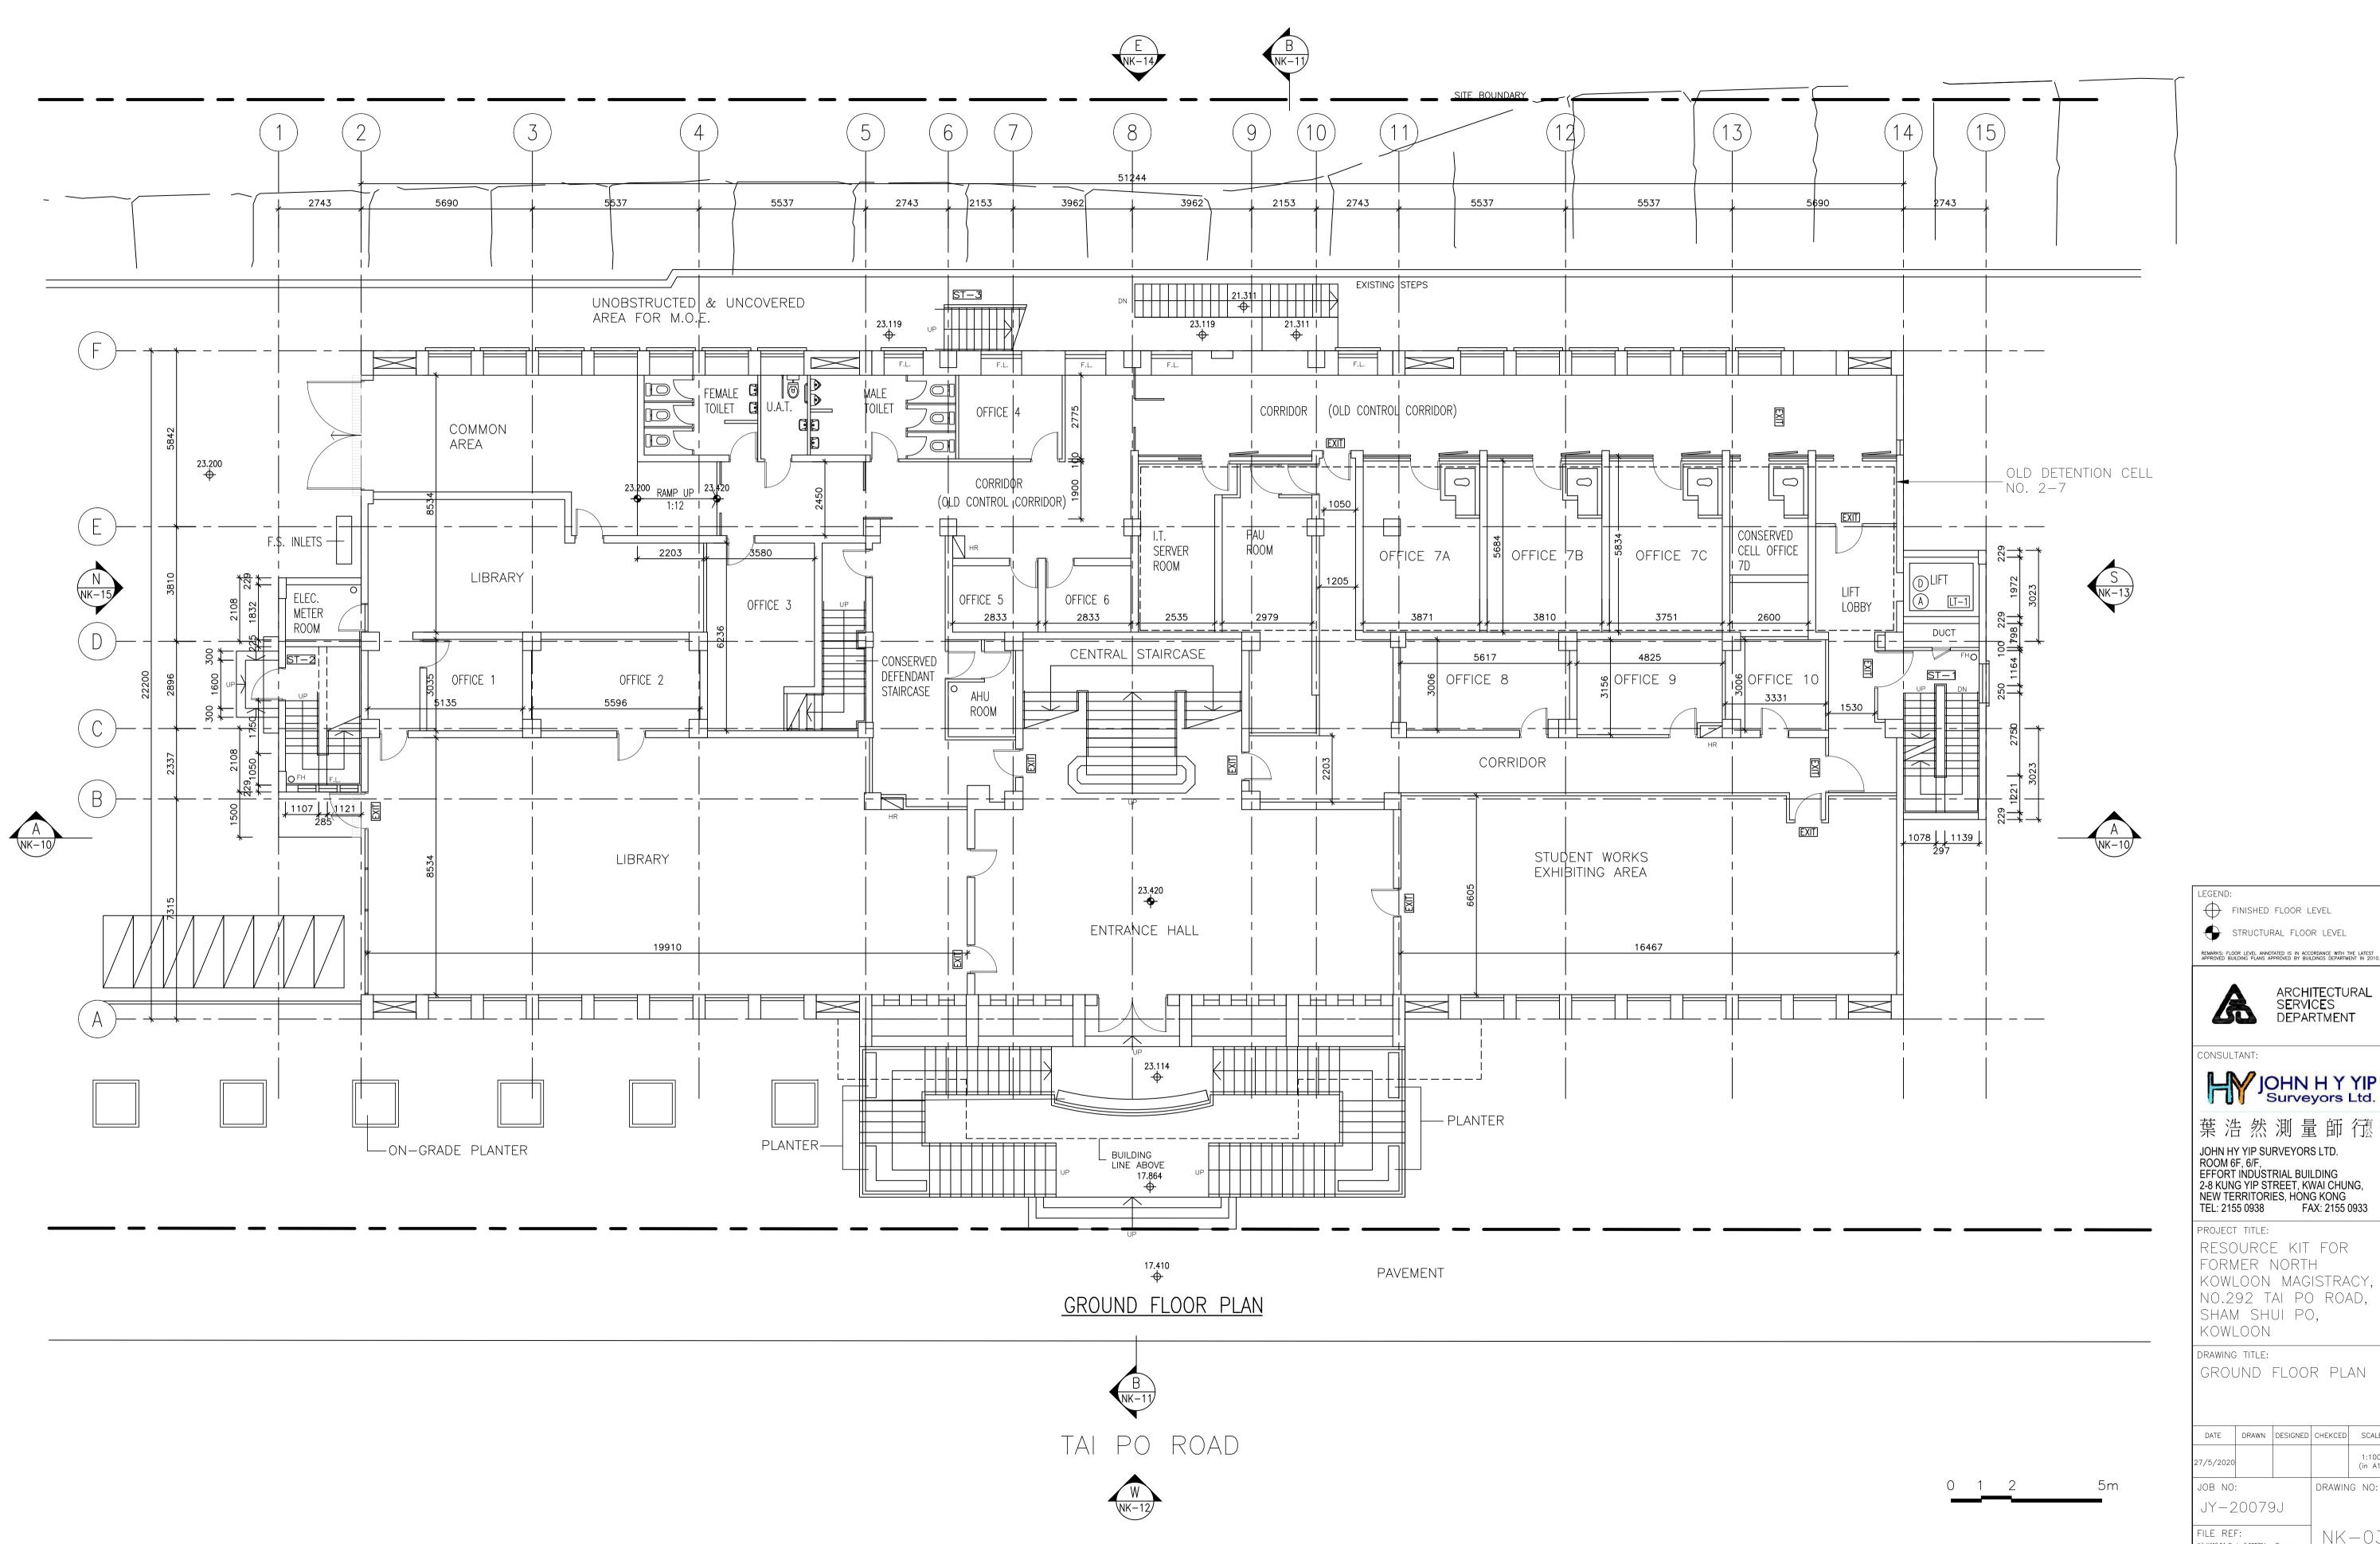

FINISHED FLOOR LEVEL STRUCTURAL FLOOR LEVEL




CONSULTANT: JOHN H Y YIP Surveyors Ltd.

葉浩然測量師德 JOHN HY YIP SURVEYORS LTD.
ROOM 6F, 6/F,
EFFORT INDUSTRIAL BUILDING
2-8 KUNG YIP STREET, KWAI CHUNG,
NEW TERRITORIES, HONG KONG
TEL: 2155 0938 FAX: 2155 0933

PROJECT TITLE: RESOURCE KIT FOR FORMER NORTH KOWLOON MAGISTRACY, NO.292 TAI PO ROAD, SHAM SHUI PO, KOWLOON

DRAWING TITLE: GROUND FLOOR PLAN

DATE DRAWN DESIGNED CHEKCED SCALE 1:100 (in A1) DRAWING NO: JY-20079J FILE REF: NK - 03X:\JHYY\04 Project\20079J — Resource Kit for Former North Kowloon Magistracy HRT-022020\03 — Plan\As-built\2020-07-09\GF.dwg

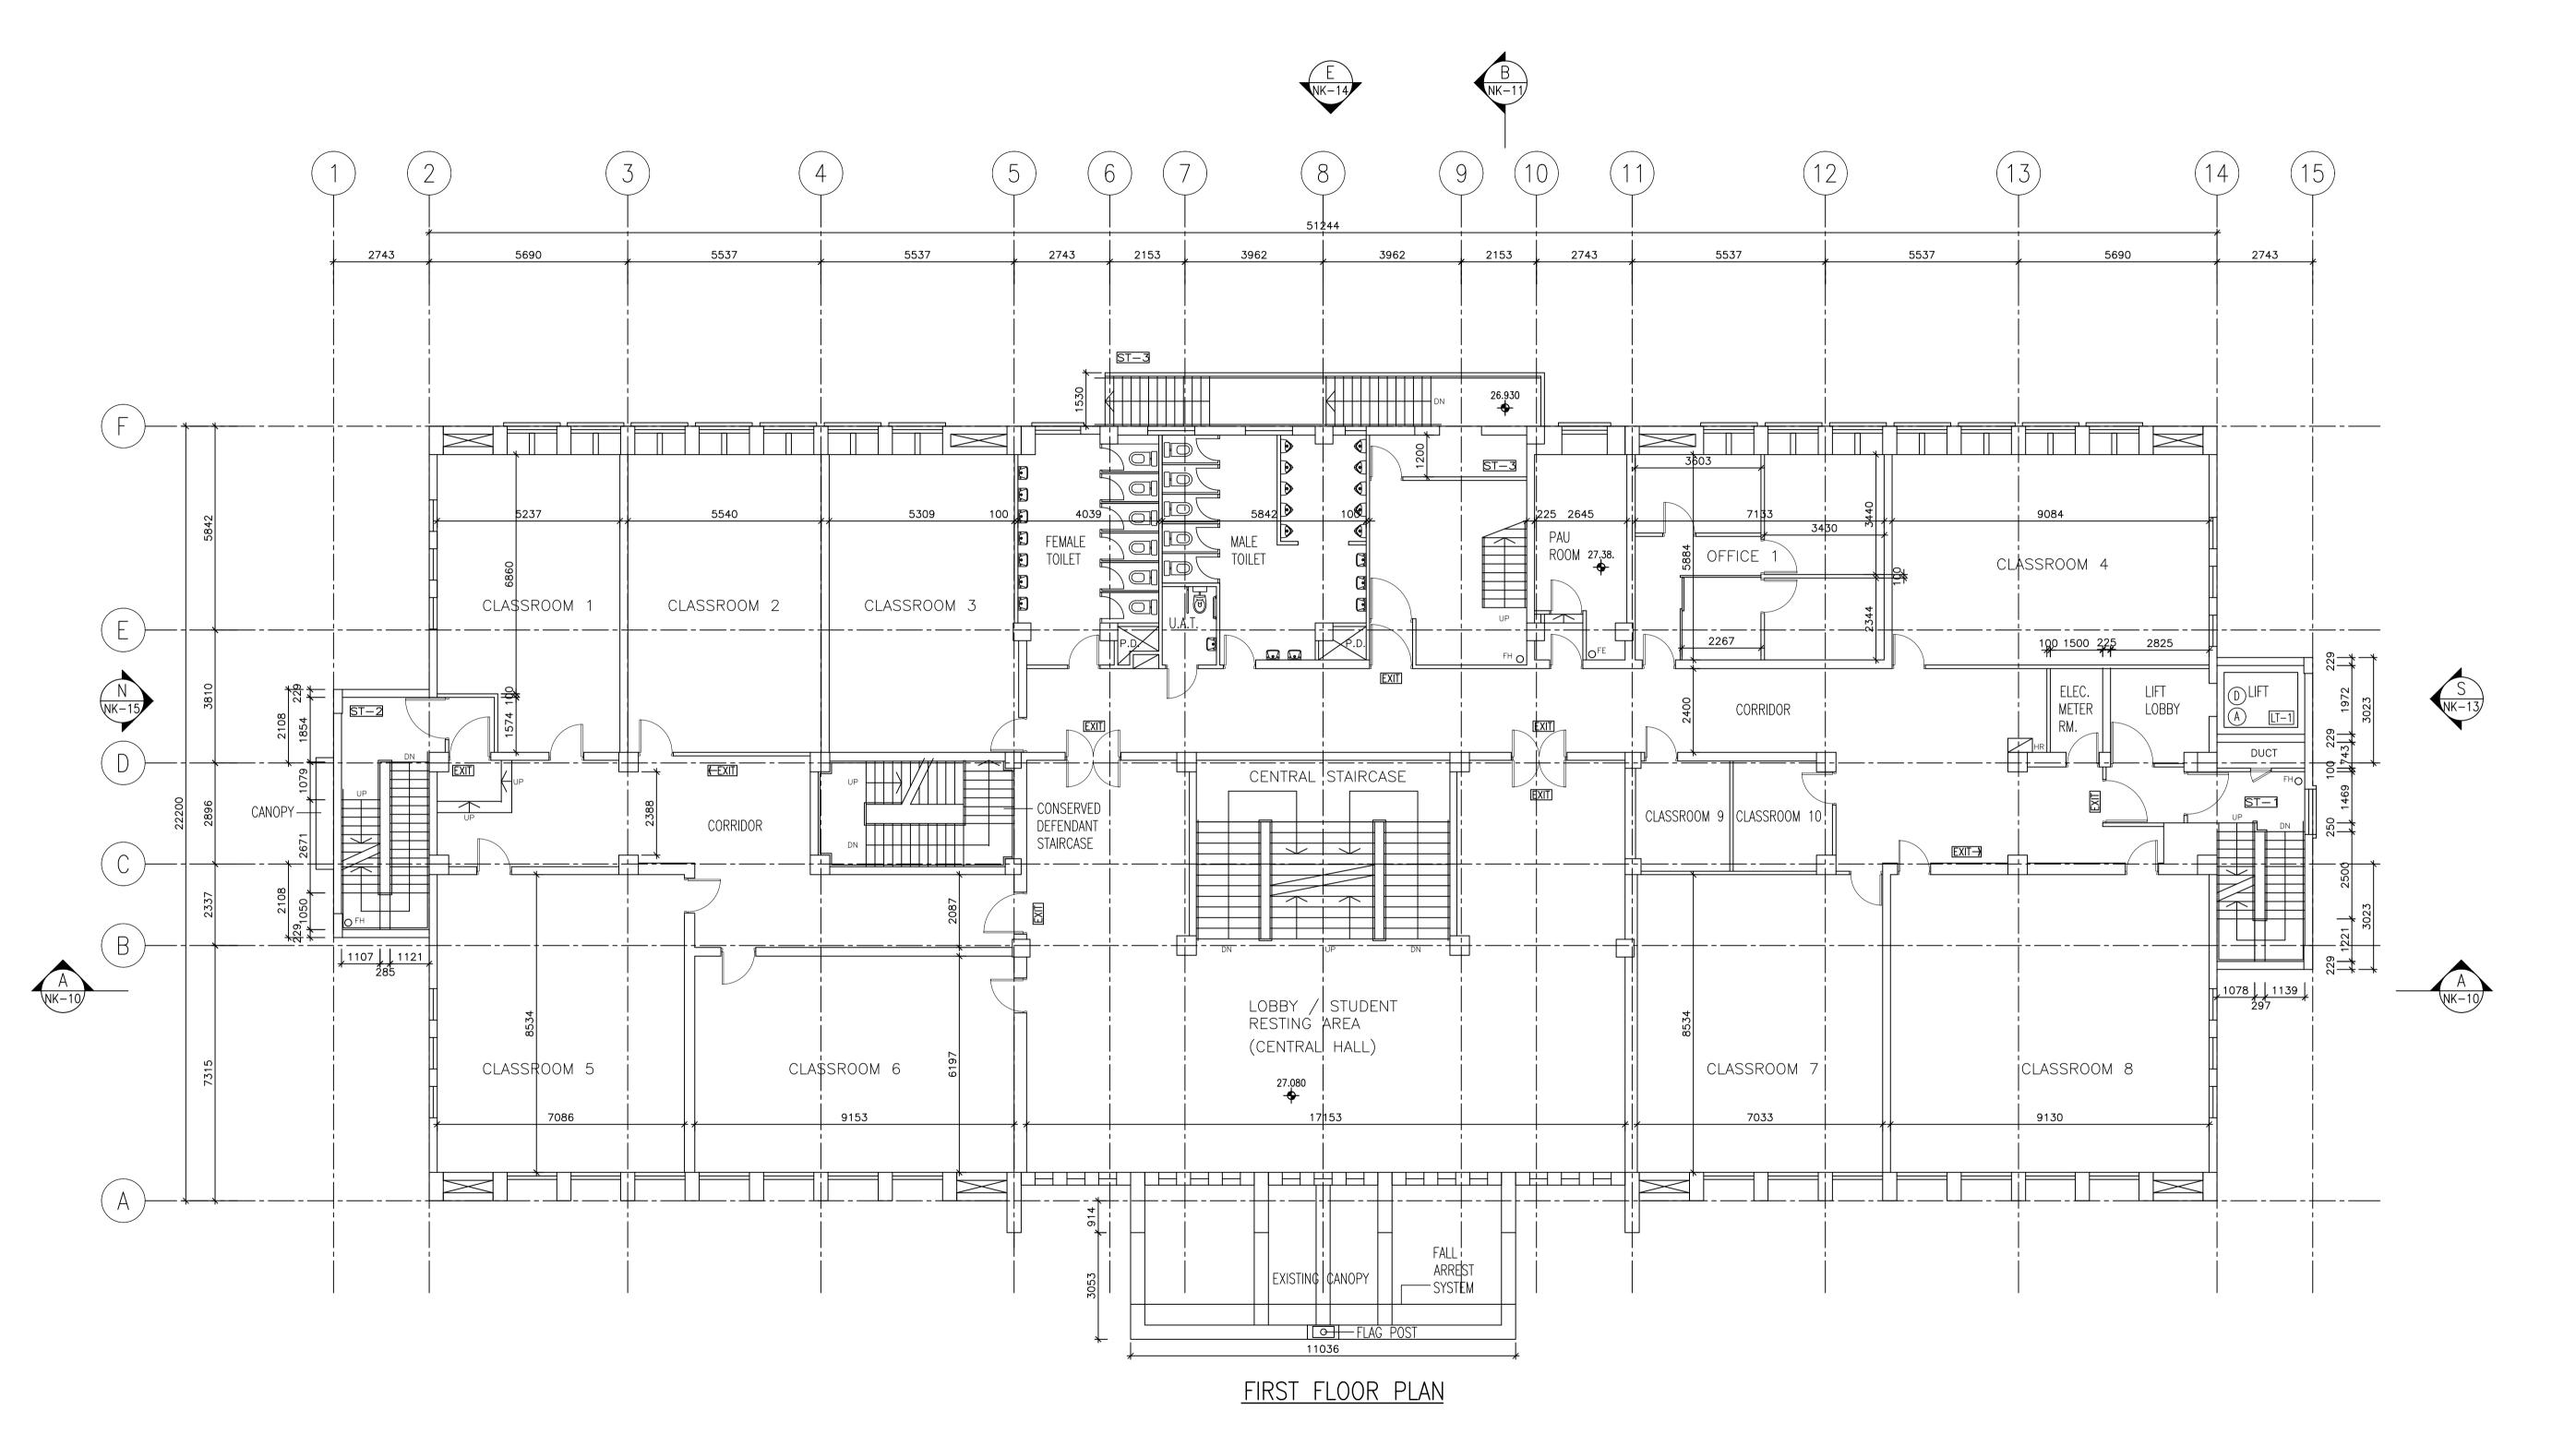

B NK-11





LEGEND:

FINISHED FLOOR LEVEL

STRUCTURAL FLOOR LEVEL

REMARKS: FLOOR LEVEL ANNOTATED IS IN ACCORDANCE WITH THE LATEST APPROVED BUILDING PLANS APPROVED BY BUILDINGS DEPARTMENT IN 2010.



CONSULTANT:

JOHN H Y YIP
Surveyors Ltd.

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NEW TERRITORIES, HONG KONG
TEL: 2155 0938 FAX: 2155 0933

PROJECT TITLE:

RESOURCE KIT FOR

FORMER NORTH

KOWLOON MAGISTRACY,


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SHAM SHUI PO,


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DRAWING TITLE:
FIRST FLOOR PLAN


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JY-2	20079			
FILE REF: X:\JHYY\04 Project\20079J - Resource Kit for Former North Kowloon Magistracy HRT-022020\03 - Plan\As-built\2020-07-09\1F.dwg			NK	-04



SECOND FLOOR PLAN

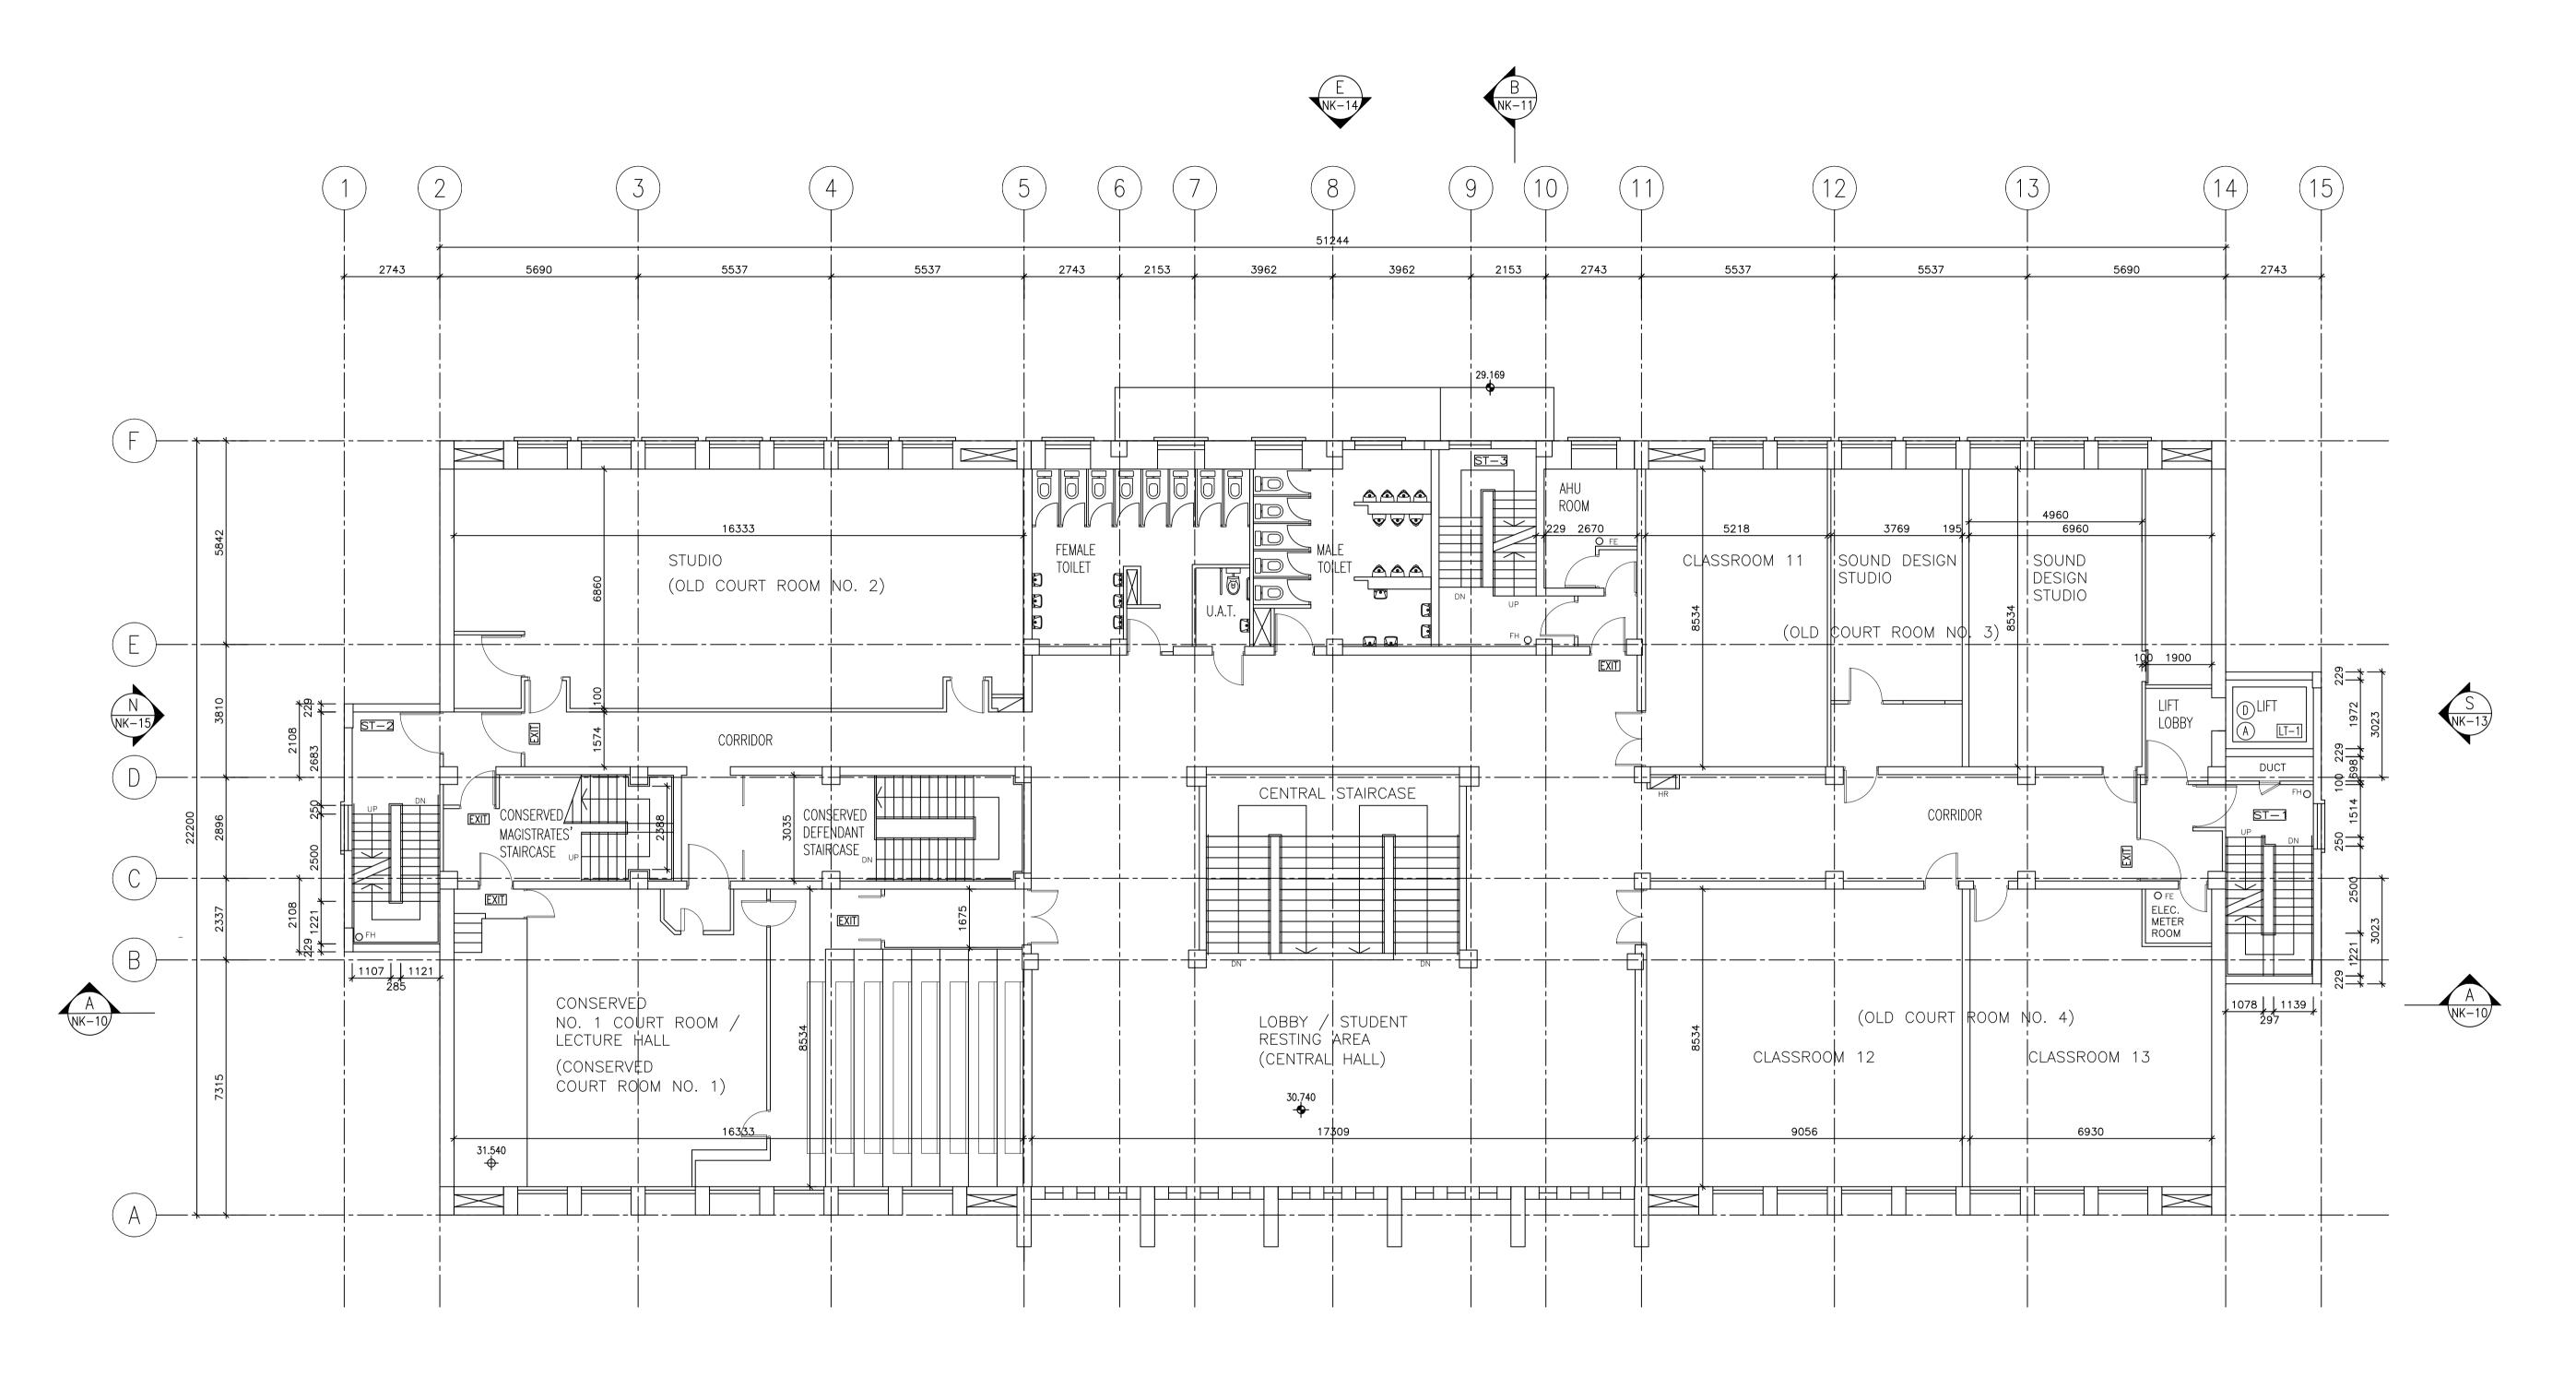

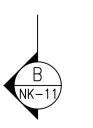

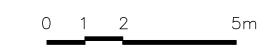

LEGEND:

FINISHED FLOOR LEVEL

STRUCTURAL FLOOR LEVEL

REMARKS: FLOOR LEVEL ANNOTATED IS IN ACCORDANCE WITH THE LATEST APPROVED BUILDING PLANS APPROVED BY BUILDINGS DEPARTMENT IN 2010.



CONSULTANT:

JOHN H Y YIP
Surveyors Ltd.

葉浩然測量師行 JOHN HY YIP SURVEYORS LTD. ROOM 6F, 6/F, EFFORT INDUSTRIAL BUILDING 2-8 KUNG YIP STREET, KWAI CHUNG, NEW TERRITORIES, HONG KONG TEL: 2155 0938 FAX: 2155 0933

PROJECT TITLE:

RESOURCE KIT FOR

FORMER NORTH

KOWLOON MAGISTRACY,

NO.292 TAI PO ROAD,


SHAM SHUI PO,

KOWLOON

DRAWING TITLE:

SECOND FLOOR PLAN

DATE	DRAWN	DESIGNED	CHEKCED	SCALE
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JOB NO:		DRAWING NO:		
JY-2	20079			
FILE REF: X:\JHYY\04 Project\20079J - Resource Kit for Former North Kowloon Magistracy HRT-022020\03 - Plan\As-built\2020-07-09\2F.dwg			NK	-05

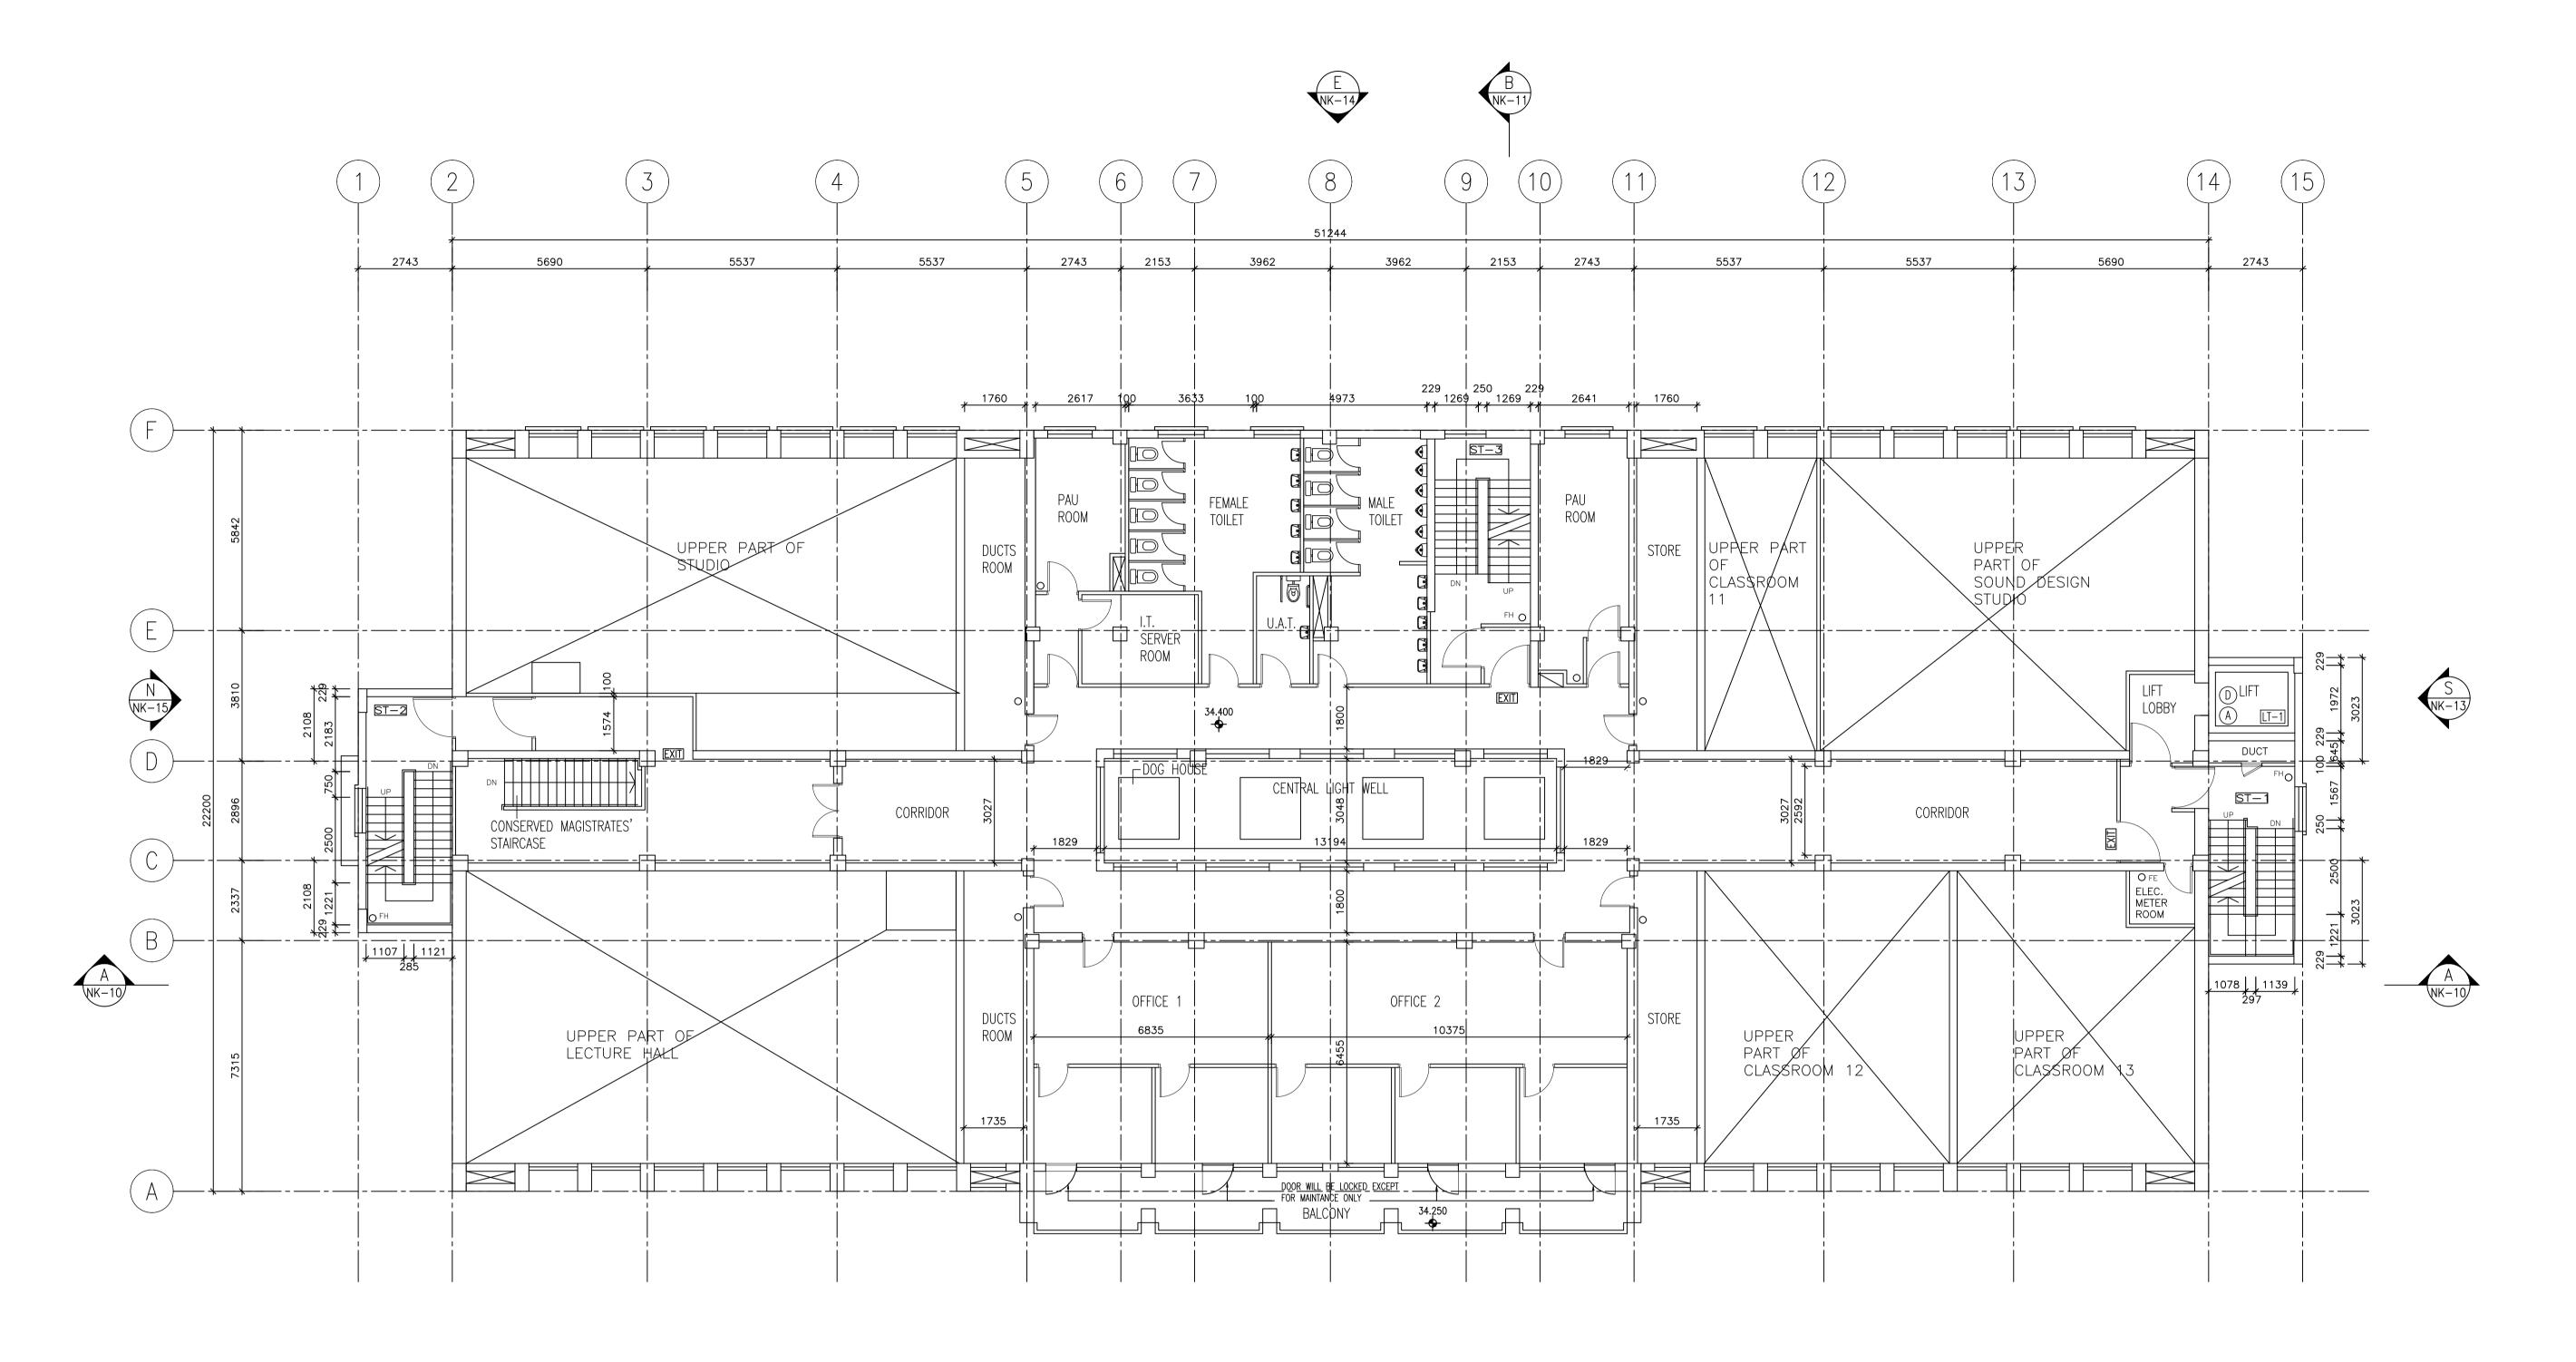

THIRD FLOOR PLAN







LEGEND:

FINISHED FLOOR LEVEL

STRUCTURAL FLOOR LEVEL

REMARKS: FLOOR LEVEL ANNOTATED IS IN ACCORDANCE WITH THE LATEST APPROVED BUILDING PLANS APPROVED BY BUILDINGS DEPARTMENT IN 2010.



CONSULTANT:



果 店 然 測 重 即 何 JOHN HY YIP SURVEYORS LTD. ROOM 6F, 6/F, EFFORT INDUSTRIAL BUILDING 2-8 KUNG YIP STREET, KWAI CHUNG, NEW TERRITORIES, HONG KONG TEL: 2155 0938 FAX: 2155 0933

TEL: 2155 0938 FAX: 2155 0933

PROJECT TITLE:

RESOURCE KIT FOR

FORMER NORTH

KOWLOON MAGISTRACY,


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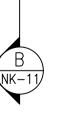
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drawing title: THIRD FLOOR PLAN

DATE	DRAWN	DESIGNED	CHEKCED	SCA
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FILE REF: X:\JHYY\04 Project\20079J - Resource Kit for Former North Kowloon Mogistracy HRT-022020\03 - Plan\As-built\2020-07-09\3F.dwg			NK	-0



FOURTH FLOOR PLAN



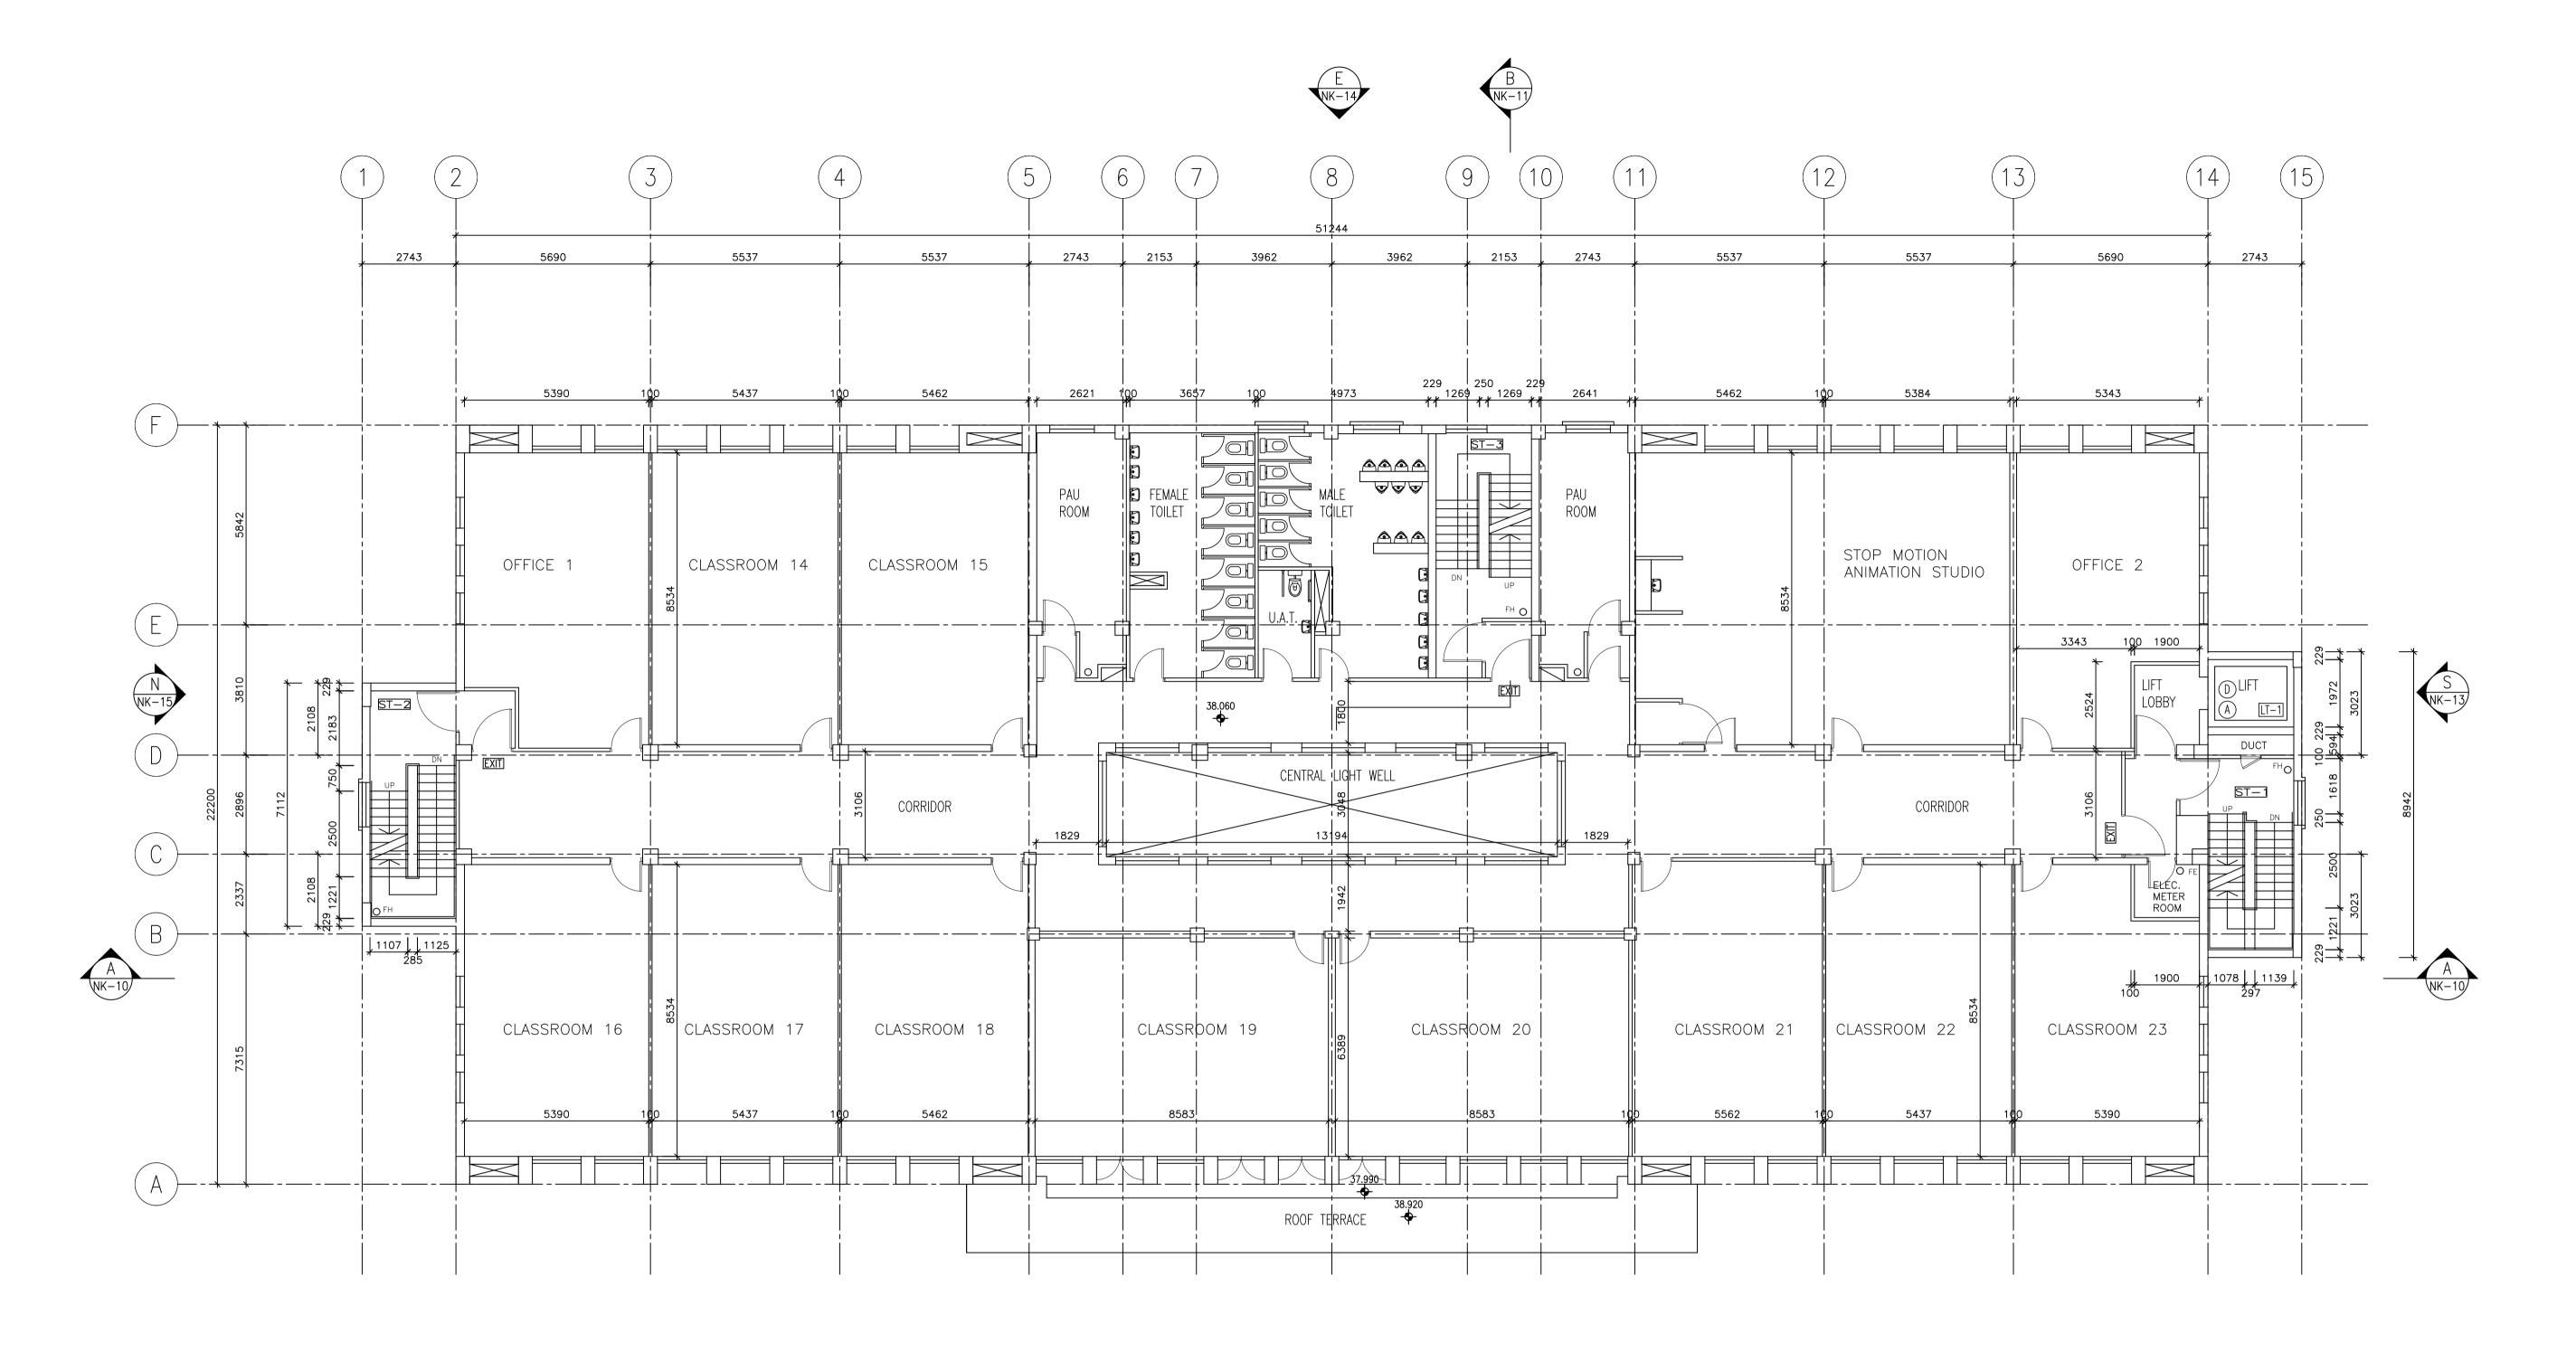

0 1 2 5m

LEGEND:

FINISHED FLOOR LEVEL

STRUCTURAL FLOOR LEVEL

REMARKS: FLOOR LEVEL ANNOTATED IS IN ACCORDANCE WITH THE LATEST APPROVED BY BUILDINGS DEPARTMENT IN 2010.



ARCHITECTURAL SERVICES DEPARTMENT

FAX: 2155 0933

CONSULTANT:

JOHN H Y YIP
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TEL: 2155 0938

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PROJECT TITLE:

RESOURCE KIT FOR

FORMER NORTH

KOWLOON MAGISTRACY,


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SHAM SHUI PO,


KOWLOON

DRAWING TITLE:
FOURTH FLOOR PLAN

DATE	DRAWN	DESIGNED	CHEKCED	SCALE
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JOB NO:		DRAWING NO:		
JY-2	20079			
FILE REF X:\JHYY\04 Pro Kit for Former HRT-022020\03 Plan\As-built\2	oject∖20079J — North Kowloon 3 —	NK	-07	

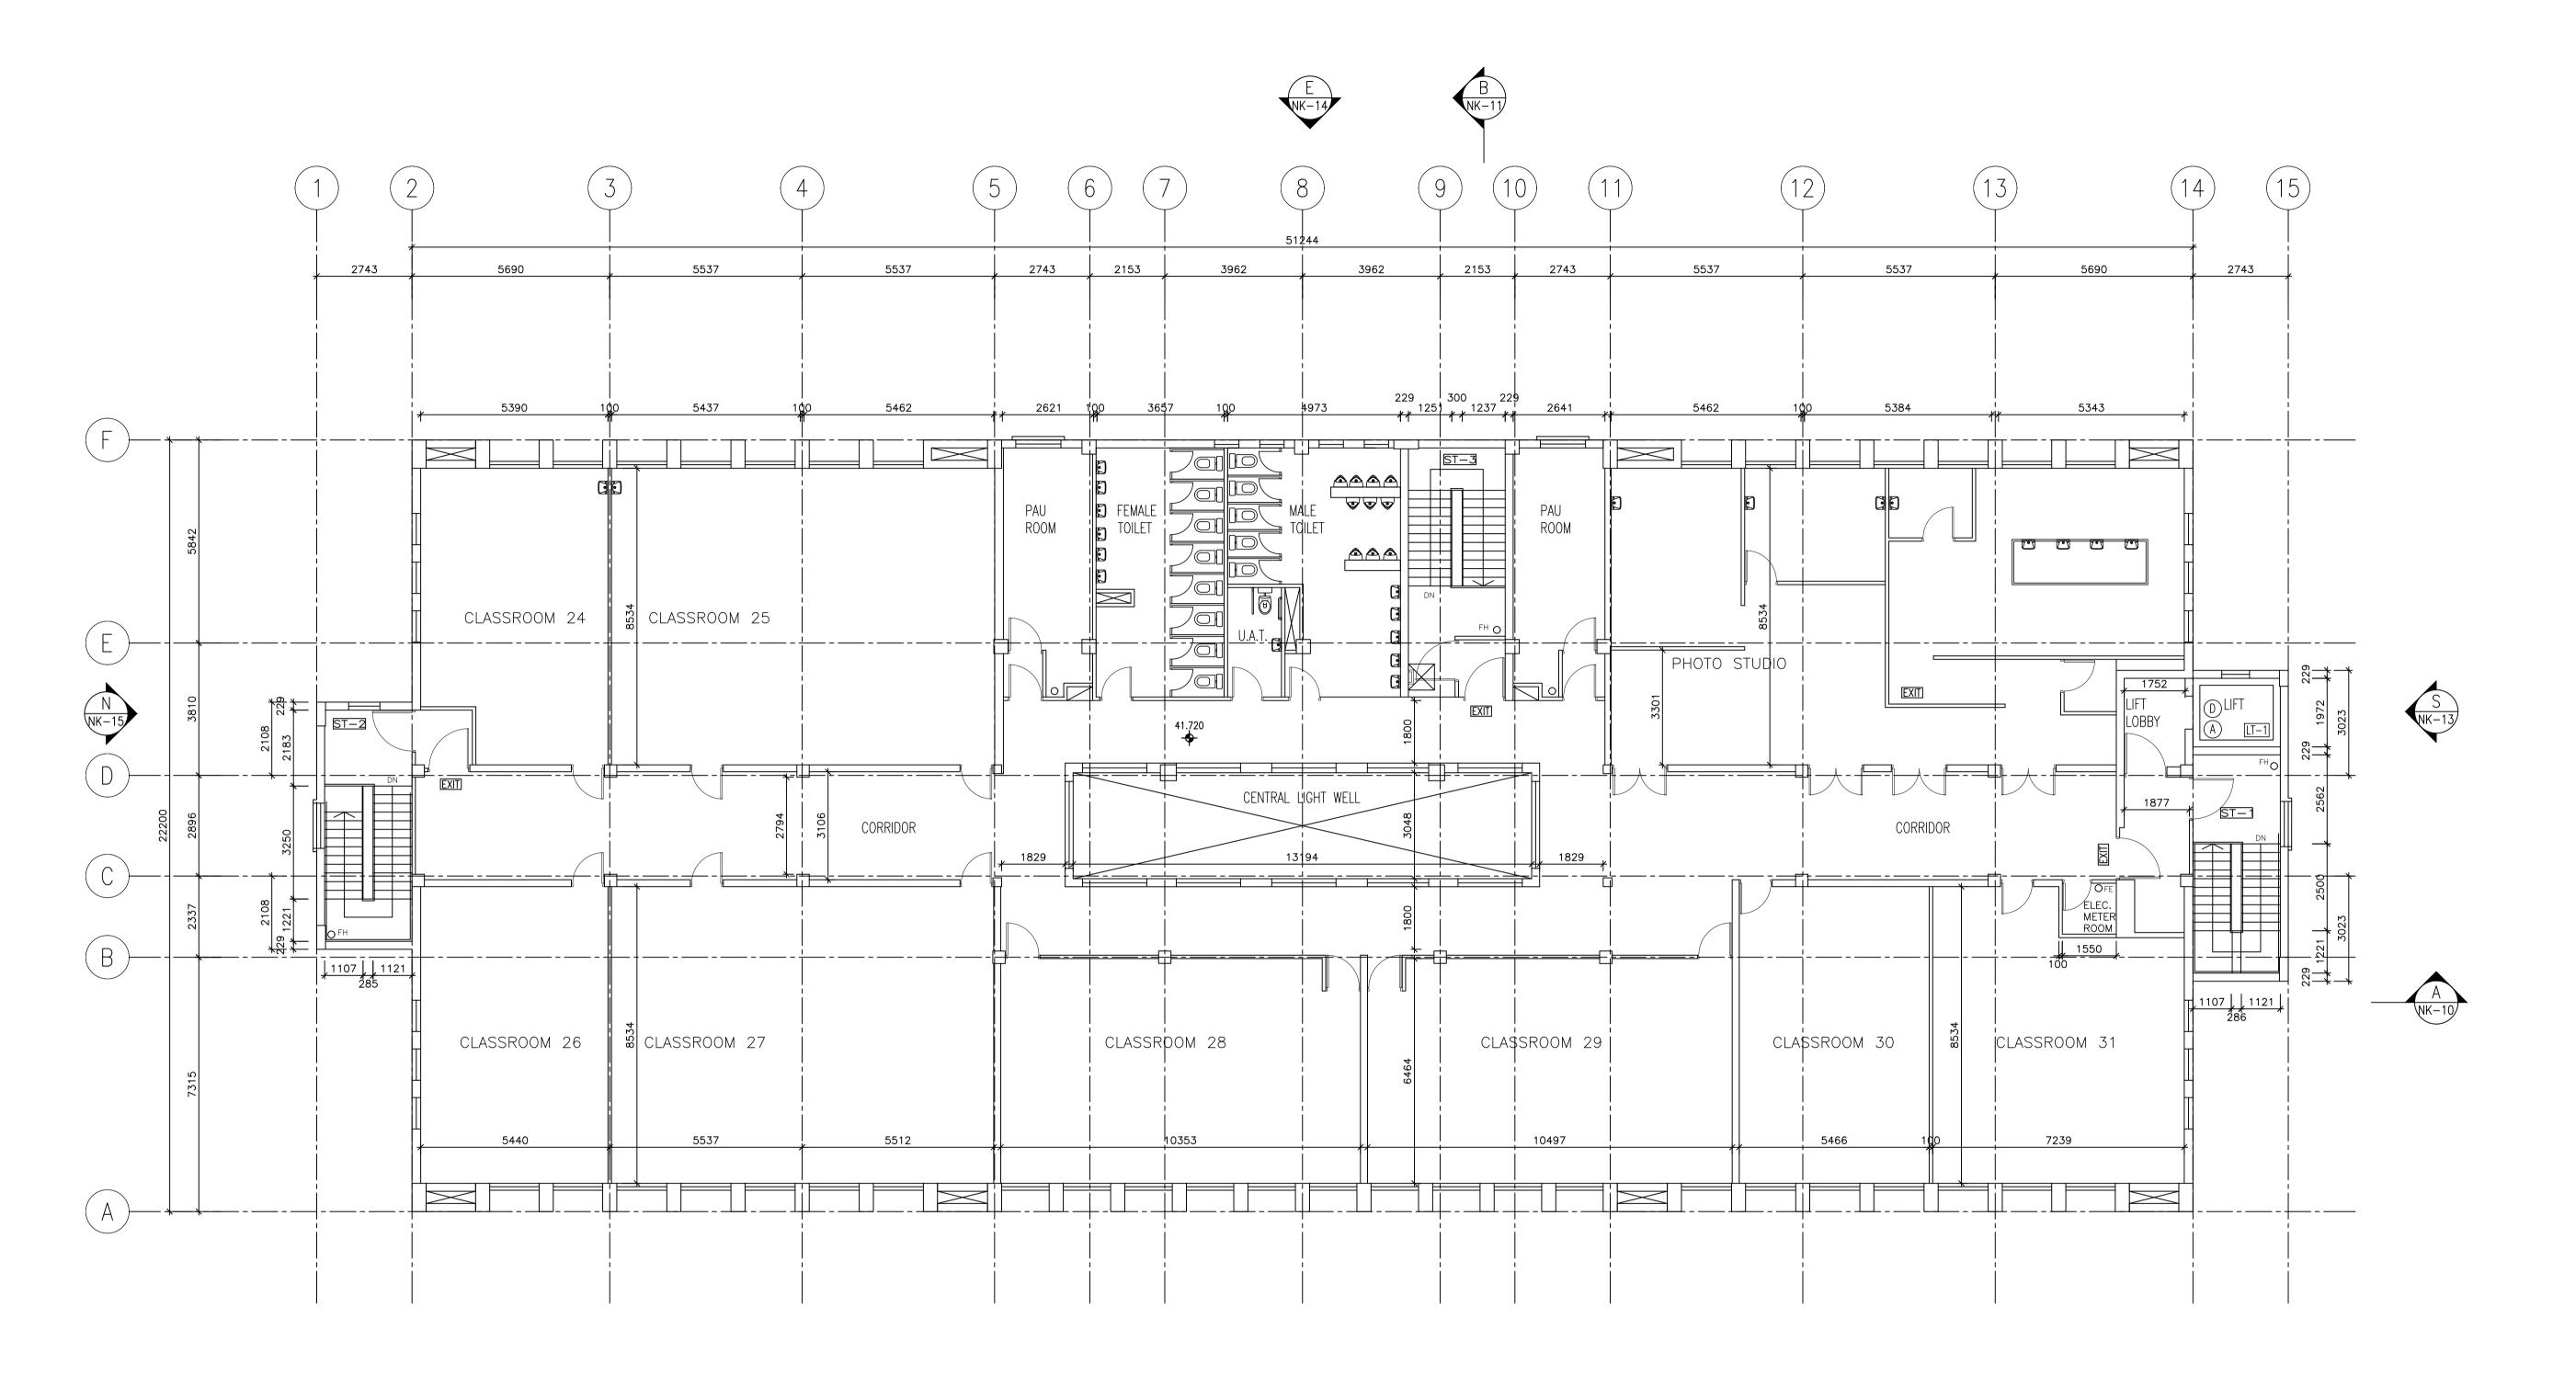

FIFTH FLOOR PLAN

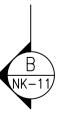



0 1 2 5m

LEGEND:

FINISHED FLOOR LEVEL

STRUCTURAL FLOOR LEVEL



REMARKS: FLOOR LEVEL ANNOTATED IS IN ACCORDANCE WITH THE LATEST APPROVED BUILDING PLANS APPROVED BY BUILDINGS DEPARTMENT IN 2010.

CONSULTANT:

JOHN H Y YIP Surveyors Ltd. 葉 浩 然 測 量 師 德 [

JOHN HY YIP SURVEYORS LTD.
ROOM 6F, 6/F,
EFFORT INDUSTRIAL BUILDING
2-8 KUNG YIP STREET, KWAI CHUNG,
NEW TERRITORIES, HONG KONG
TEL: 2155 0938 FAX: 2155 0933

PROJECT TITLE:

RESOURCE KIT FOR

FORMER NORTH

KOWLOON MAGISTRACY,


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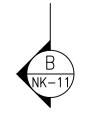
KOWLOON

drawing title: FIFTH FLOOR PLAN

DATE	DRAWN	DESIGNED	CHEKCED	SCALE
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JOB NO:		DRAWIN	IG NO:	
JY-2	20079			
FILE REF X:\JHYY\04 Pro Kit for Former HRT-022020\03 Plan\As-built\2	ject∖20079J − North Kowloon 3 −	NK	-08	



ROOF PLAN

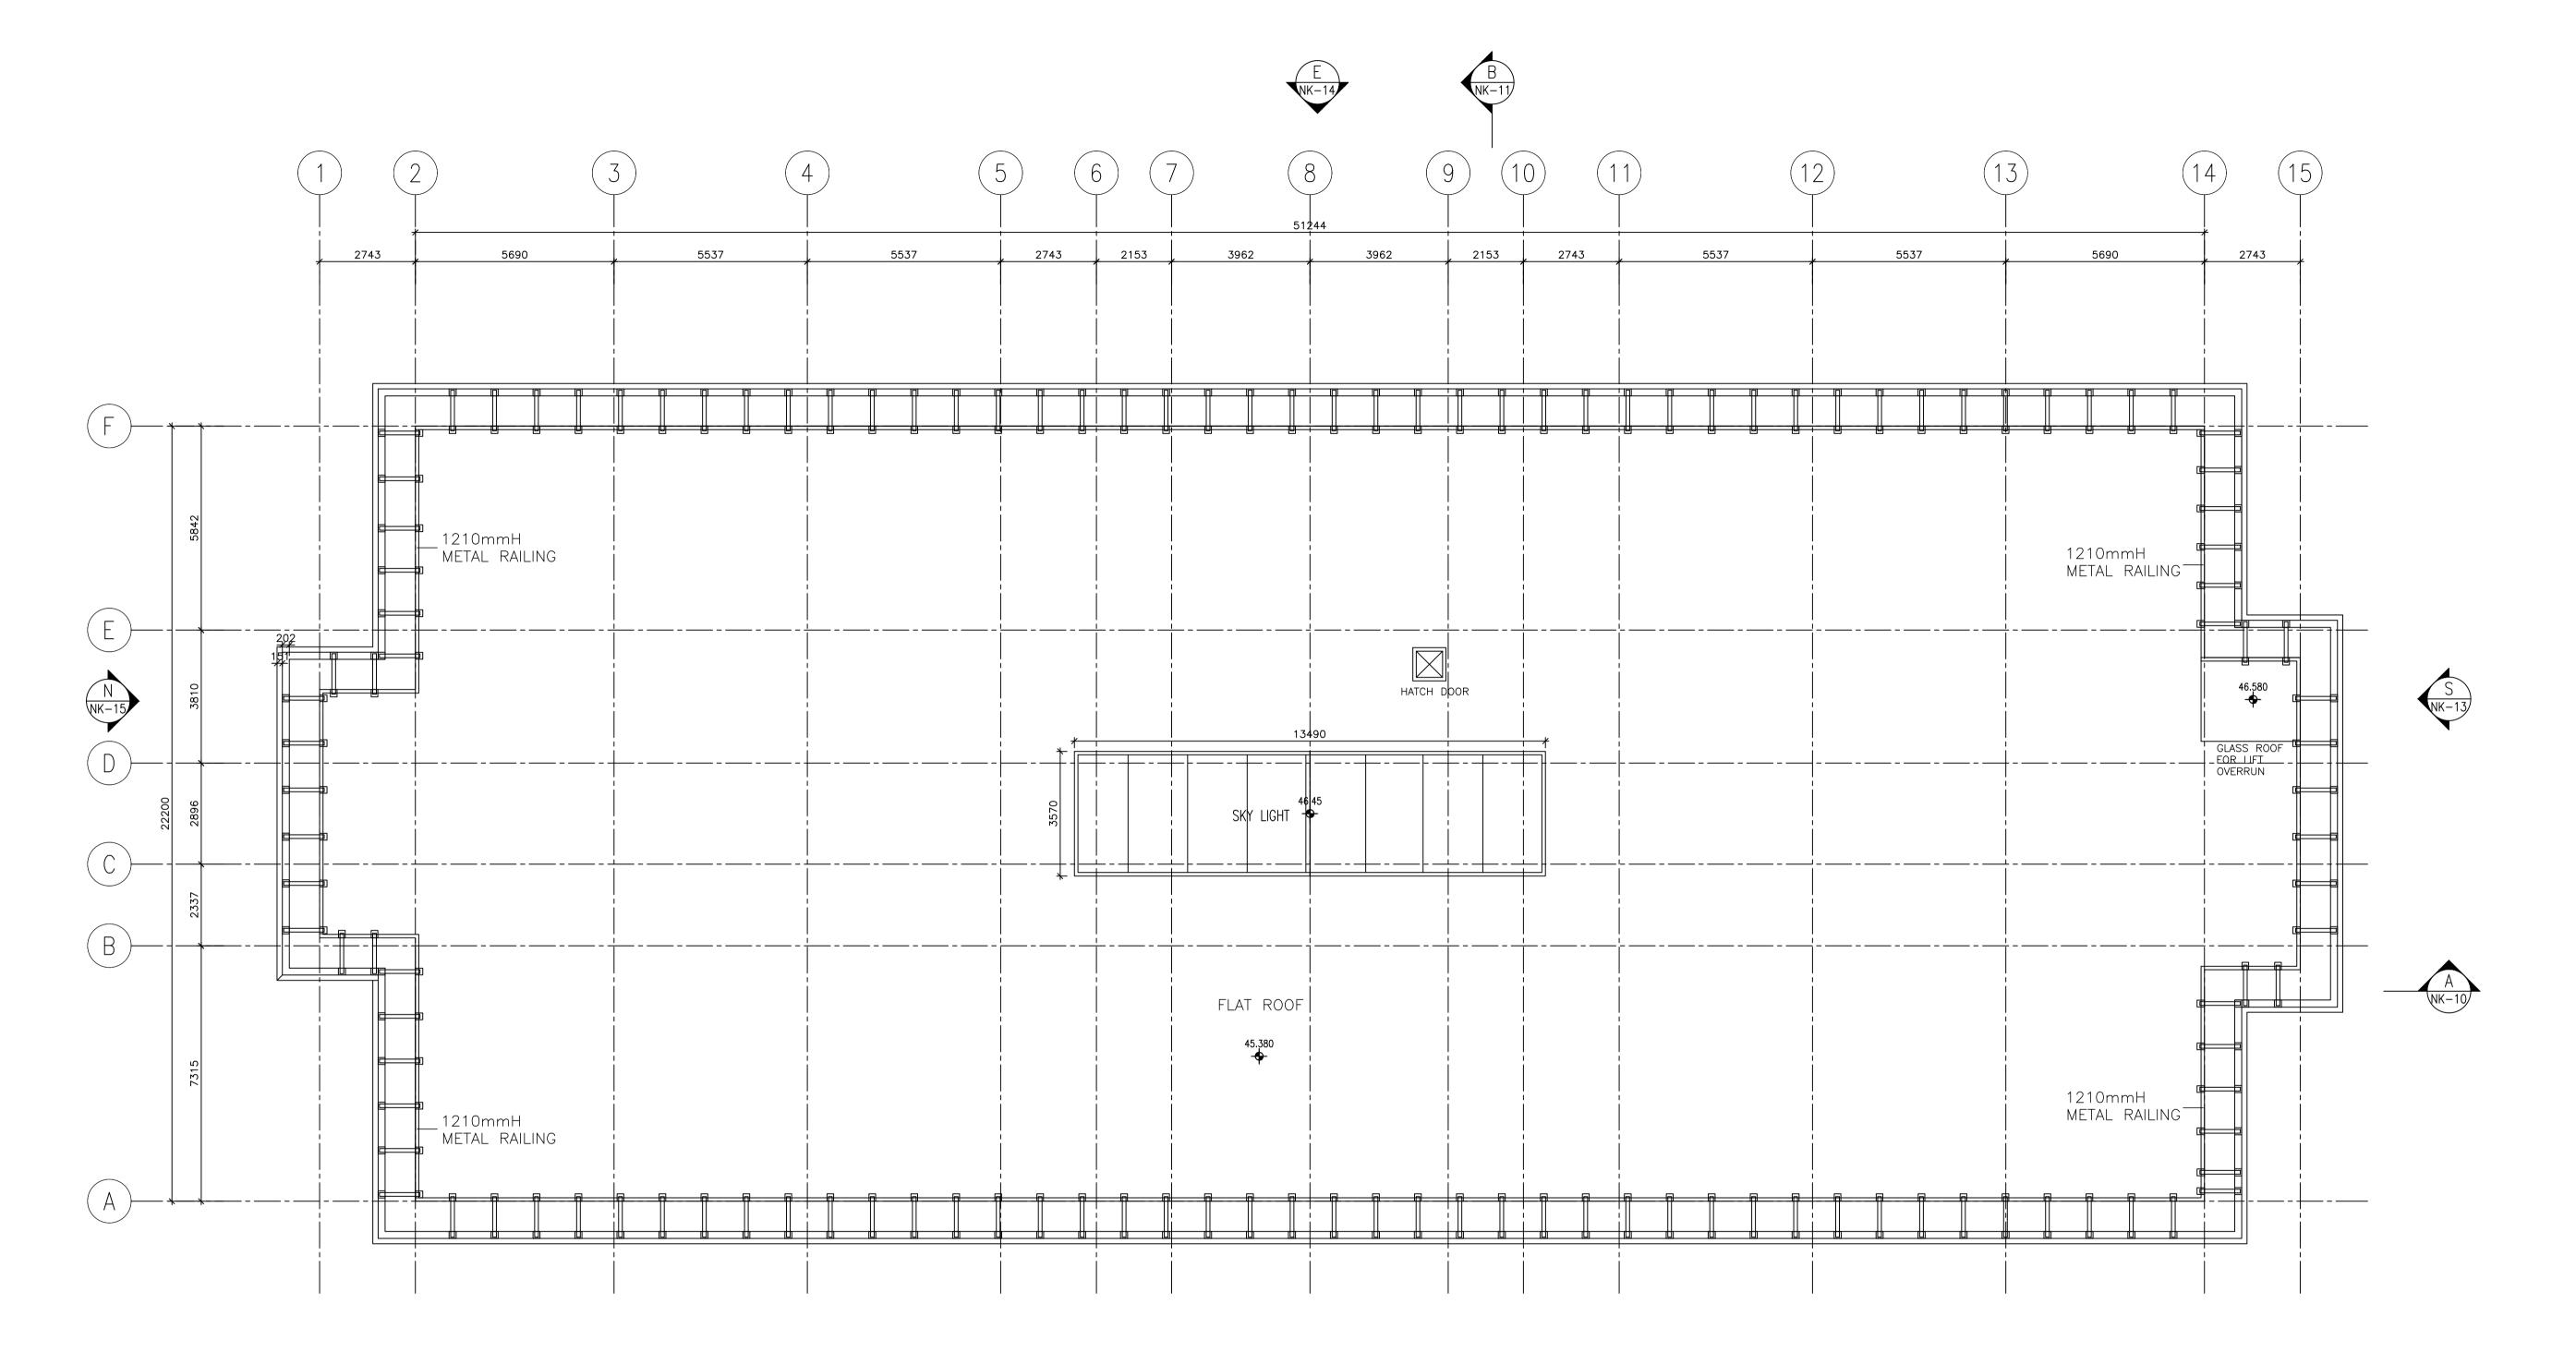



) 1<u>2</u> 5m

LEGEND:

FINISHED FLOOR LEVEL

FINISHED FLOOR LEVEL

STRUCTURAL FLOOR LEVEL

REMARKS: FLOOR LEVEL ANNOTATED IS IN ACCORDANCE WITH THE LATEST APPROVED BUILDING PLANS APPROVED BY BUILDINGS DEPARTMENT IN 2010.



CONSULTANT:

JOHN H Y YIP Surveyors Ltd.

葉浩然測量師德 JOHN HY YIP SURVEYORS LTD. ROOM 6F, 6/F, EFFORT INDUSTRIAL BUILDING 2-8 KUNG YIP STREET, KWAI CHUNG, NEW TERRITORIES, HONG KONG TEL: 2155 0938 FAX: 2155 0933

PROJECT TITLE:

RESOURCE KIT FOR

FORMER NORTH

KOWLOON MAGISTRACY,

NO.292 TAI PO ROAD,


SHAM SHUI PO,

KOWLOON

drawing title:

ROOF PLAN

DATE	DRAWN	DESIGNED	CHEKCED	SCALE
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JY-2	20079			
FILE REF: X:\JHYY\04 Project\20079J - Resource Kit for Former North Kowloon Magistracy HRT-022020\03 - Plan\As-built\2020-07-09\RF.dwg			NK	-09

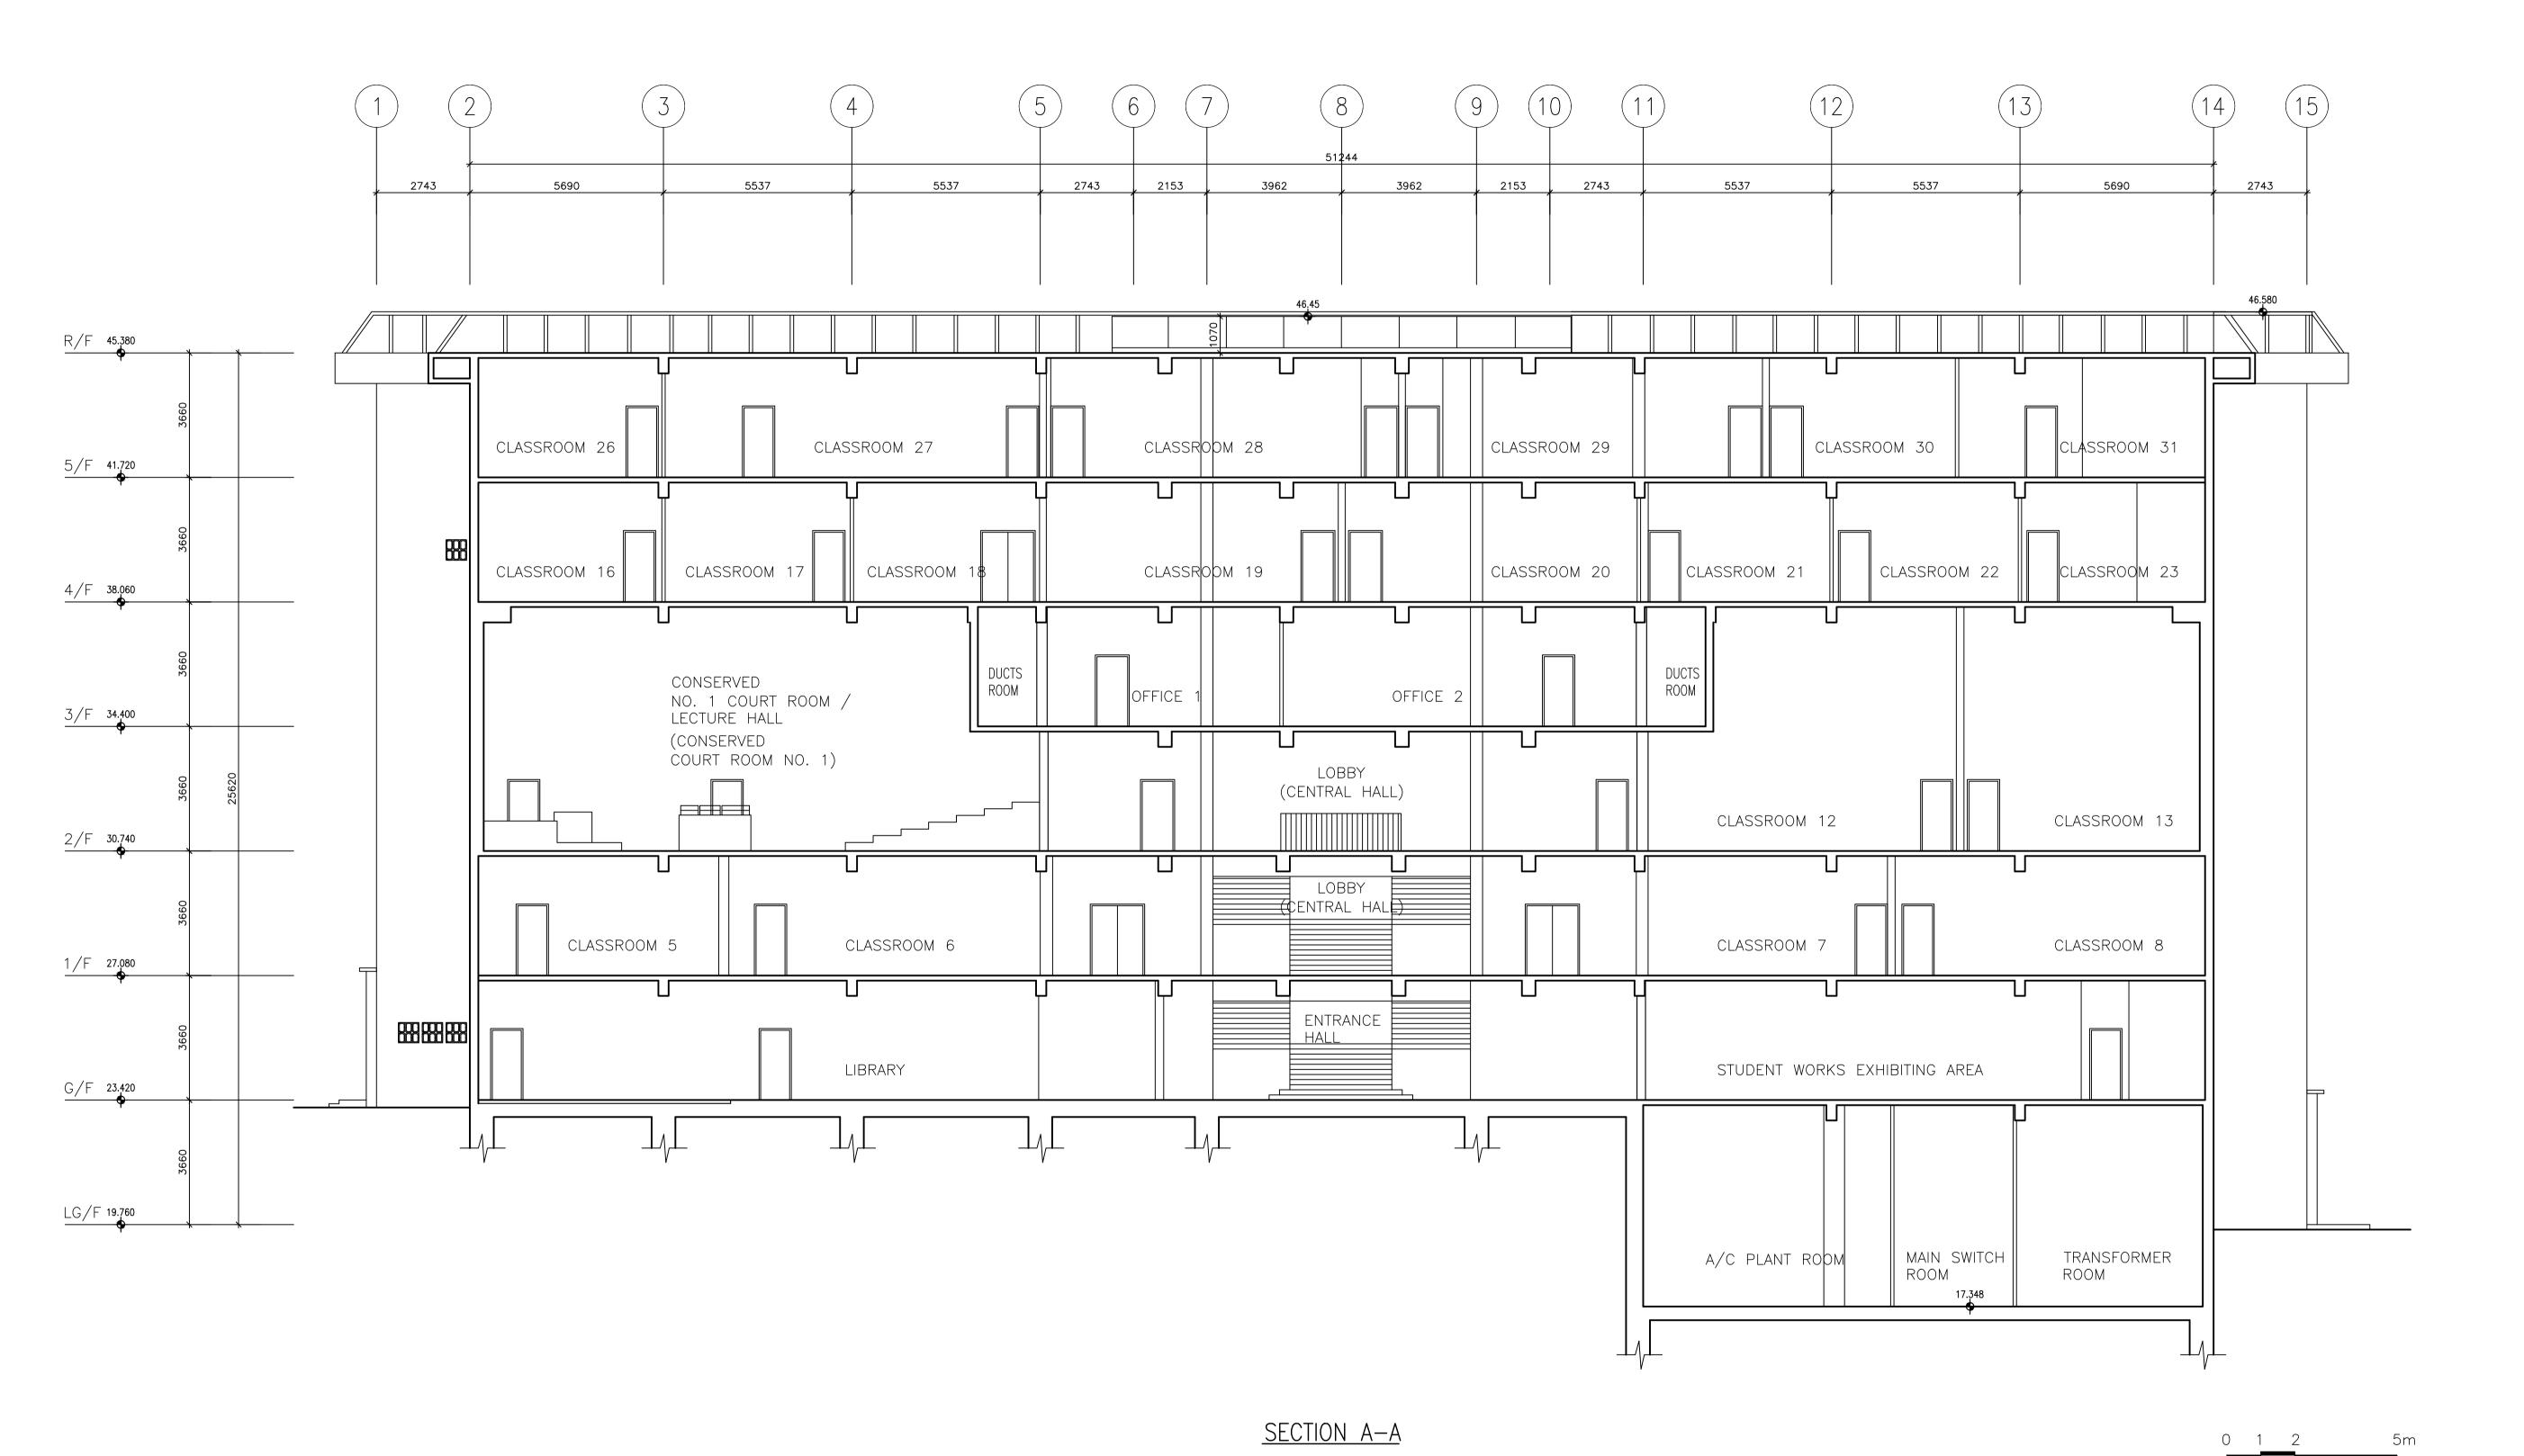

LEGEND:

FINISHED FLOOR LEVEL

STRUCTURAL FLOOR LEVEL

REMARKS: FLOOR LEVEL ANNOTATED IS IN ACCORDANCE WITH THE LATEST APPROVED BUILDING PLANS APPROVED BY BUILDINGS DEPARTMENT IN 2010.

ARCHITECTURAL SERVICES DEPARTMENT

CONSULTANT:

JOHN H Y YIP
Surveyors Ltd.

集浩然測量師行 JOHN HY YIP SURVEYORS LTD. ROOM 6F, 6/F, EFFORT INDUSTRIAL BUILDING 2-8 KUNG YIP STREET, KWAI CHUNG, NEW TERRITORIES, HONG KONG TEL: 2155 0938 FAX: 2155 0933

PROJECT TITLE:

RESOURCE KIT FOR

FORMER NORTH

KOWLOON MAGISTRACY,


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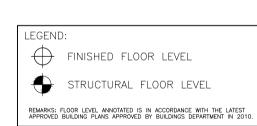
KOWLOON

DRAWING TITLE:
SECTION A-A

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SECTION B-B



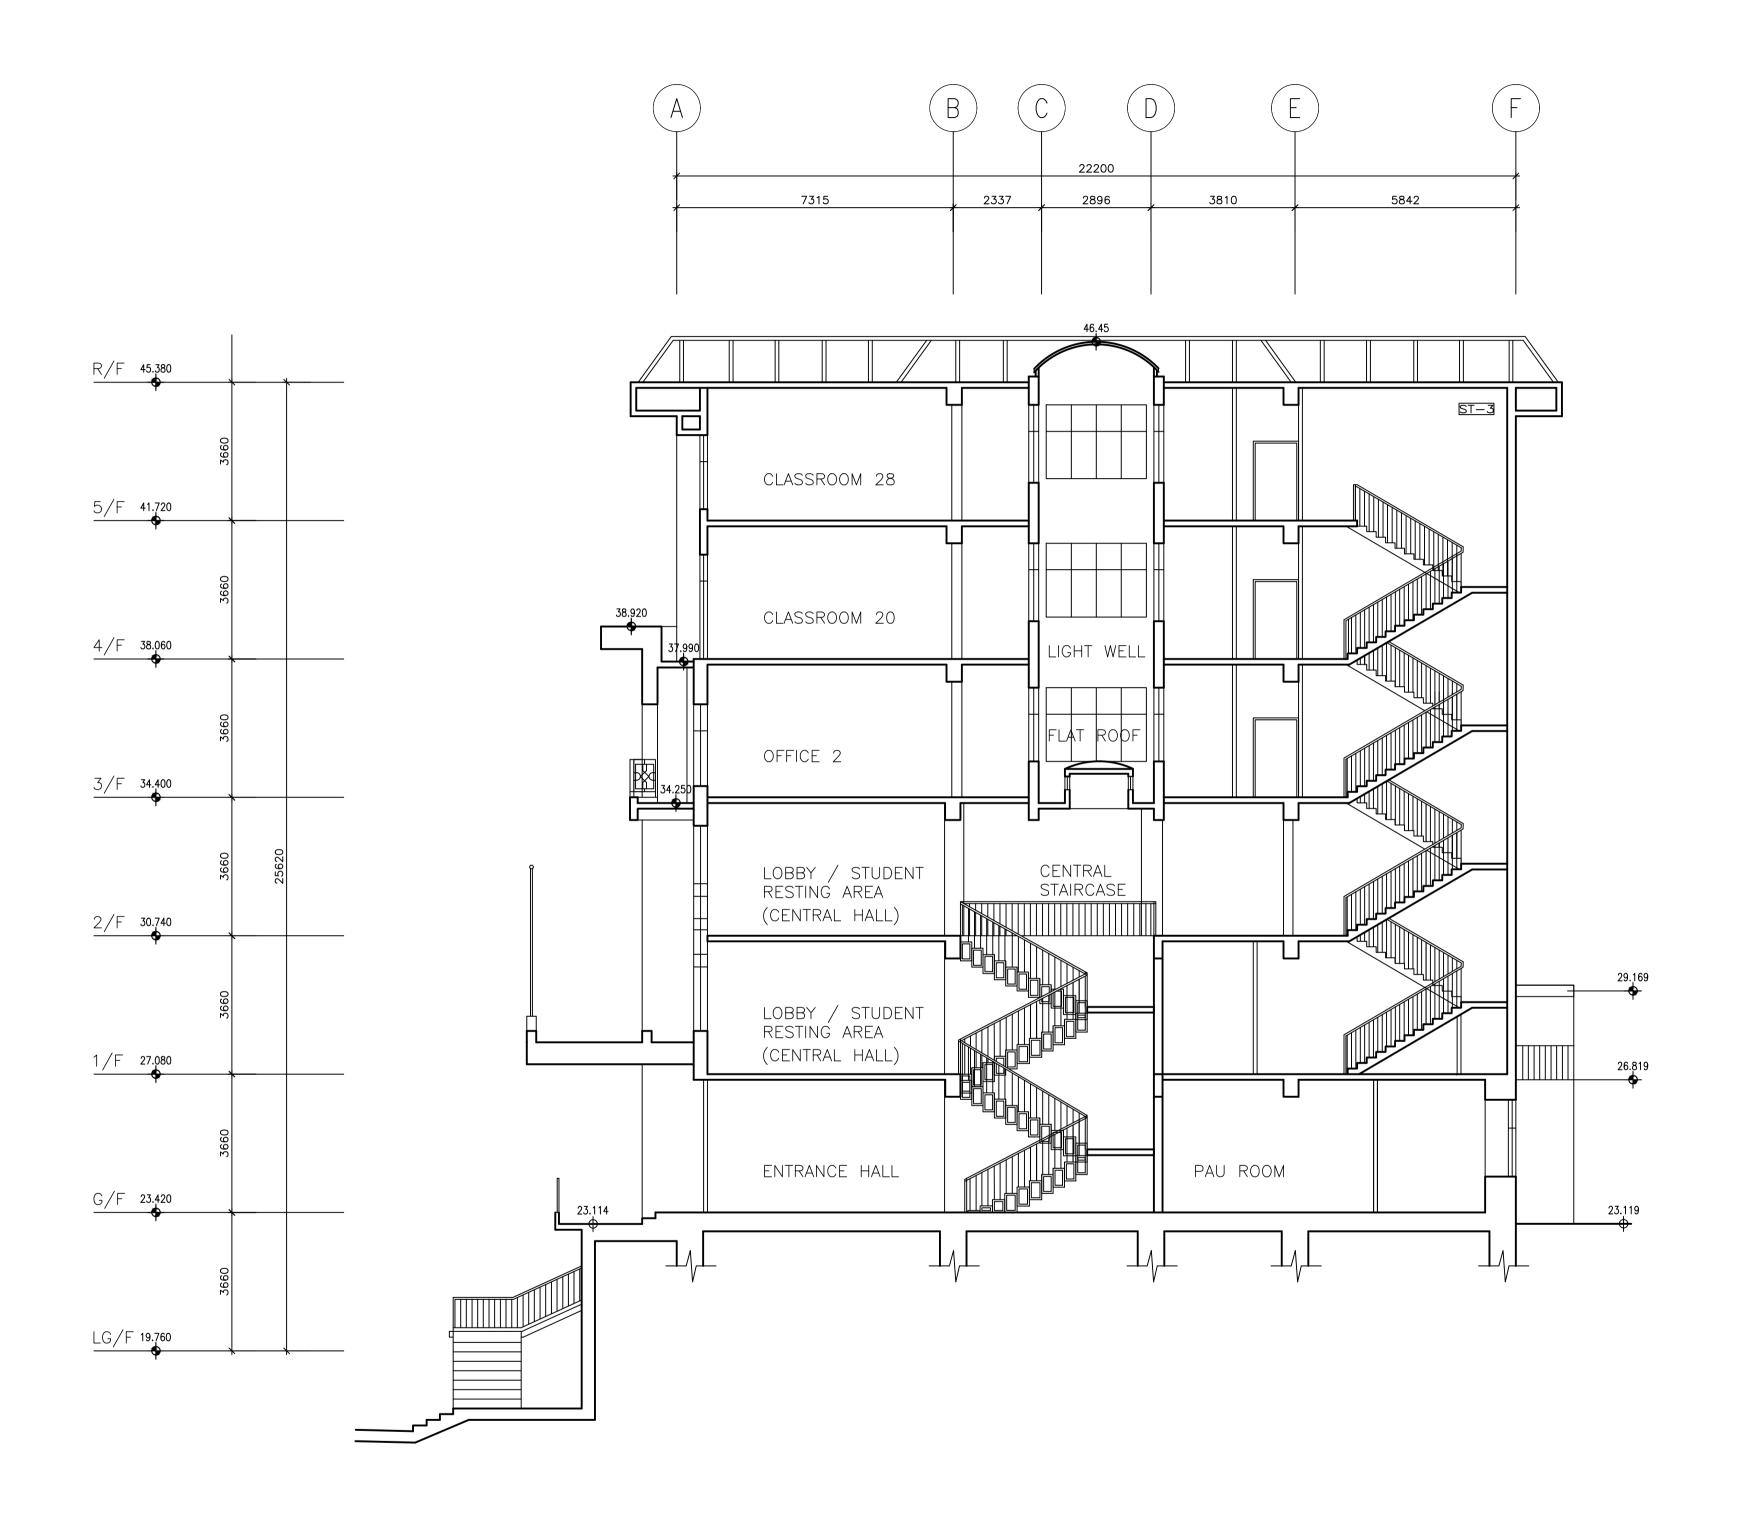

CONSULTANT:

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2-8 KUNG YIP STREET, KWAI CHUNG,
NEW TERRITORIES, HONG KONG
TEL: 2155 0938 FAX: 2155 0933

PROJECT TITLE:

RESOURCE KIT FOR

FORMER NORTH

KOWLOON MAGISTRACY,

NO.292 TAI PO ROAD,


SHAM SHUI PO,

KOWLOON

DRAWING TITLE:

SECTION B-B

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WEST ELEVATION

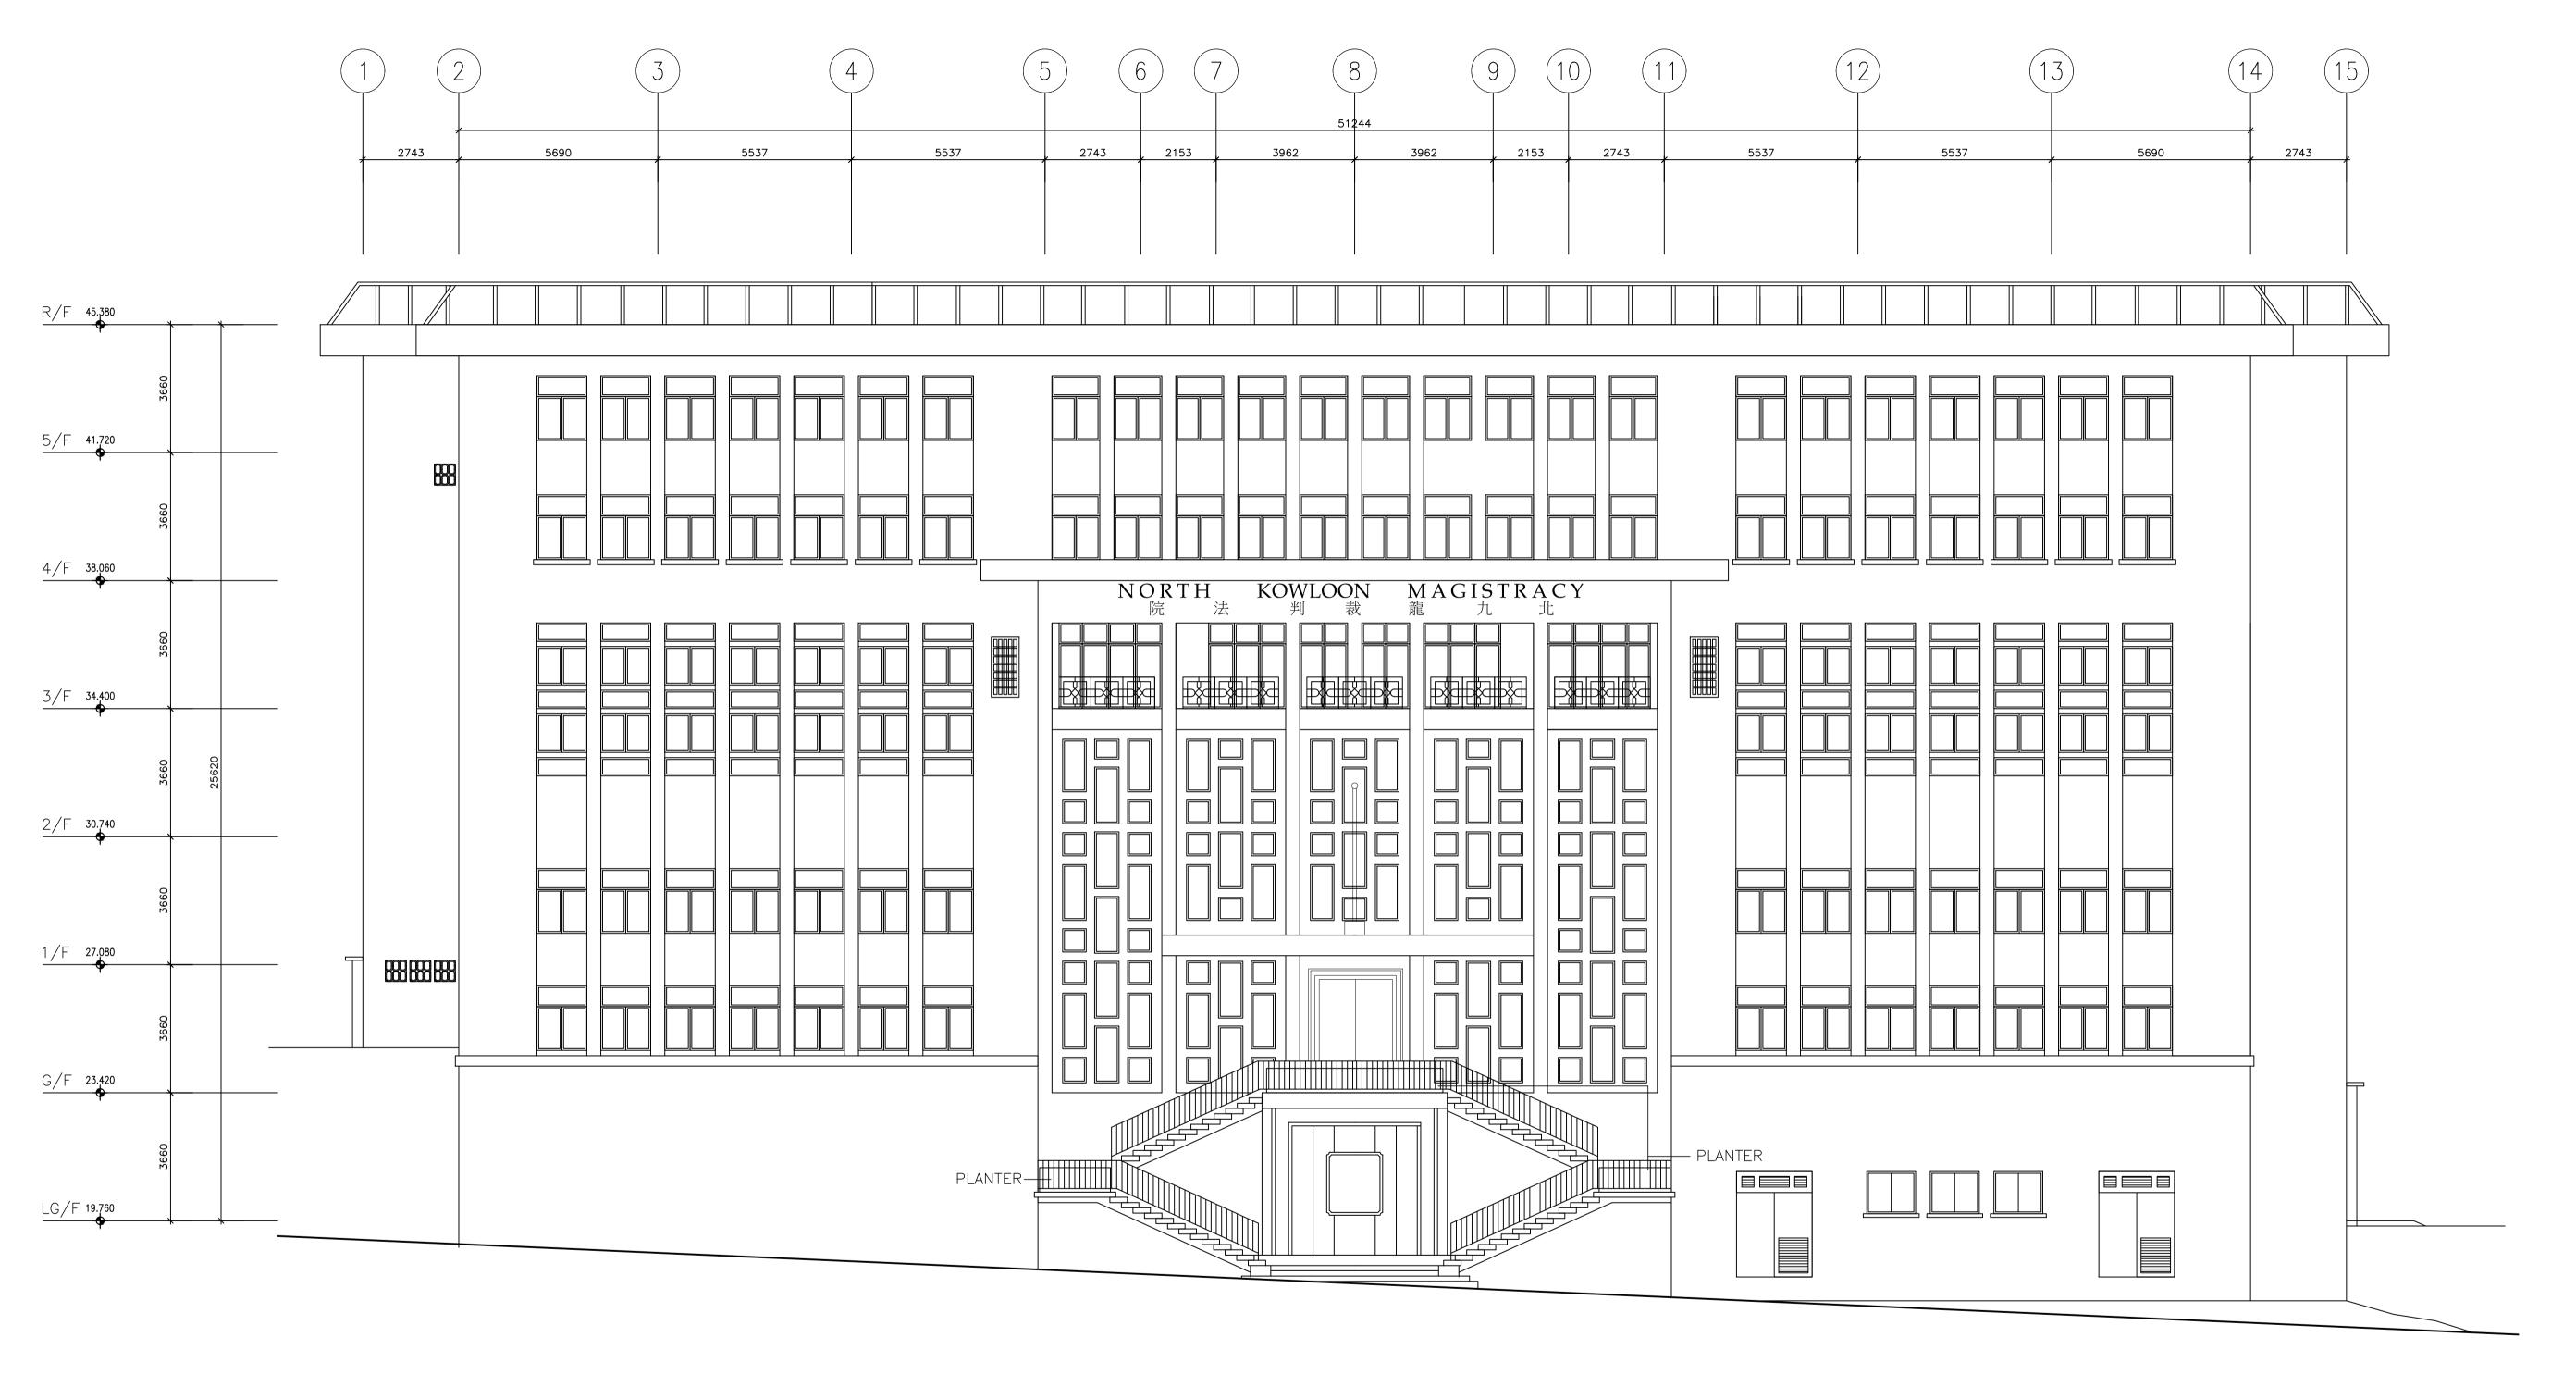

STRUCTURAL FLOOR LEVEL REMARKS: FLOOR LEVEL ANNOTATED IS IN ACCORDANCE WITH THE LATEST APPROVED BUILDING PLANS APPROVED BY BUILDINGS DEPARTMENT IN 2010.



CONSULTANT: JOHN H Y YIP Surveyors Ltd.

葉浩然測量師德屬 JOHN HY YIP SURVEYORS LTD.
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EFFORT INDUSTRIAL BUILDING
2-8 KUNG YIP STREET, KWAI CHUNG,
NEW TERRITORIES, HONG KONG
TEL: 2155 0938 FAX: 2155 0933


PROJECT TITLE: RESOURCE KIT FOR FORMER NORTH KOWLOON MAGISTRACY, NO.292 TAI PO ROAD, SHAM SHUI PO, KOWLOON

DRAWING TITLE: WEST ELEVATION

DATE	DRAWN	DESIGNED	CHEKCED	SCALE
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JOB NO:		DRAWIN	G NO:	
JY-2	20079			
FILE REF	-:			_ 1 つ


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X:\JHYY\04 Project\20079J — Resource Kit for Former North Kowloon Magistracy HRT-022020\03 — Plan\As-built\2020-07-09\W-ELE.dwg

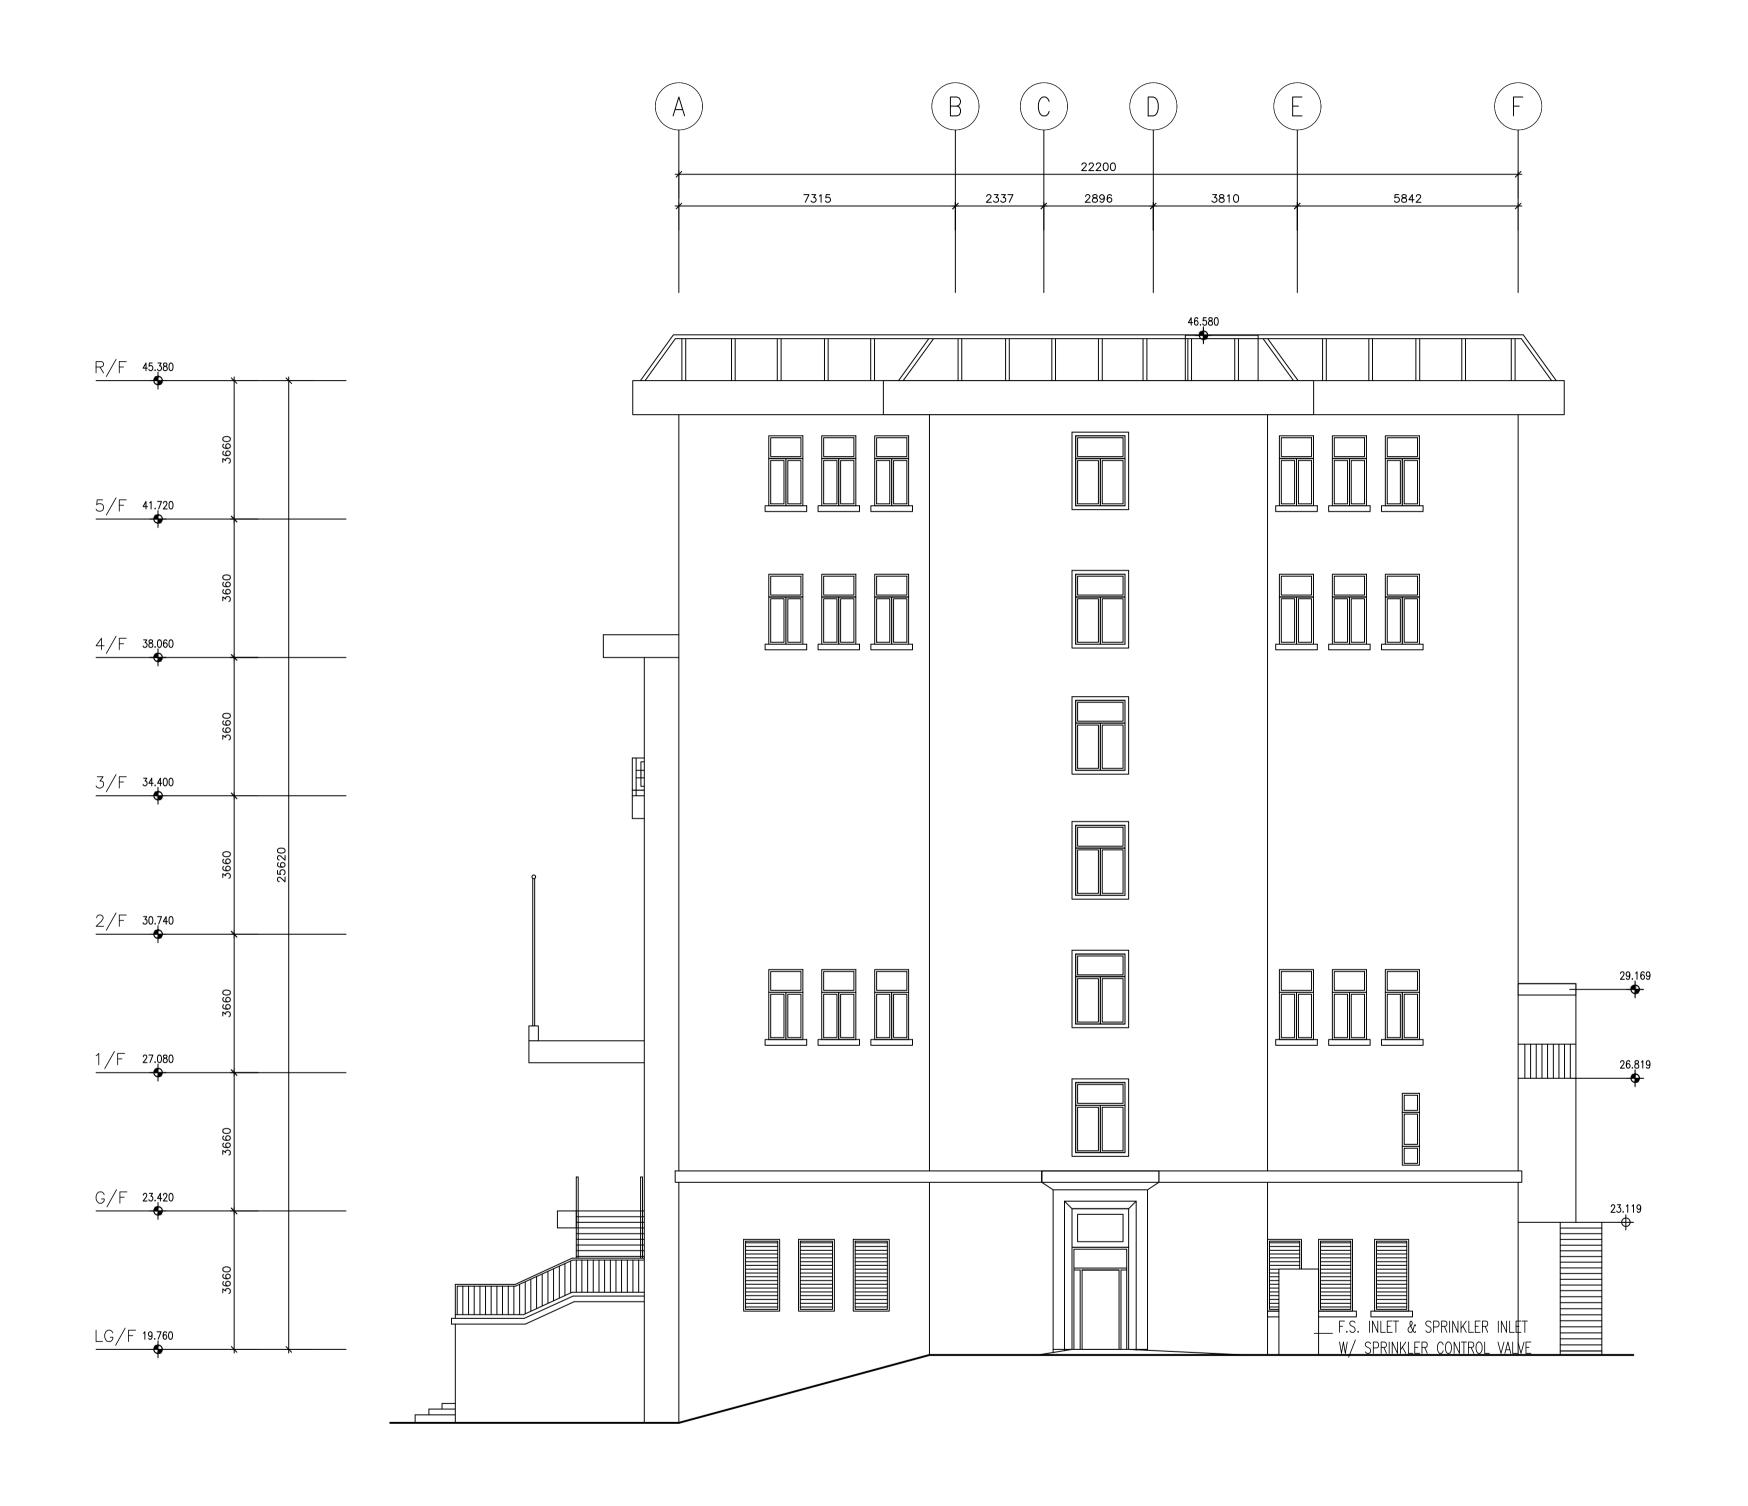

SOUTH ELEVATION

0 1 2 5m

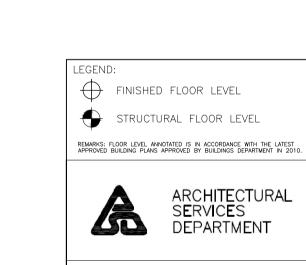

CONSULTANT:

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Surveyors Ltd.

JOHN HY YIP SURVEYORS LTD.
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EFFORT INDUSTRIAL BUILDING
2-8 KUNG YIP STREET, KWAI CHUNG,
NEW TERRITORIES, HONG KONG
TEL: 2155 0938 FAX: 2155 0933

PROJECT TITLE:

RESOURCE KIT FOR

FORMER NORTH

KOWLOON MAGISTRACY,


NO.292 TAI PO ROAD,

SHAM SHUI PO,

KOWLOON

DRAWING TITLE:
SOUTH ELEVATION

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JY-2	20079			
FILE REF X:\JHYY\04 Pro Kit for Former HRT-022020\03 Plan\As-built\2	iject∖20079J - North Kowloon 5 -	NK	-13	

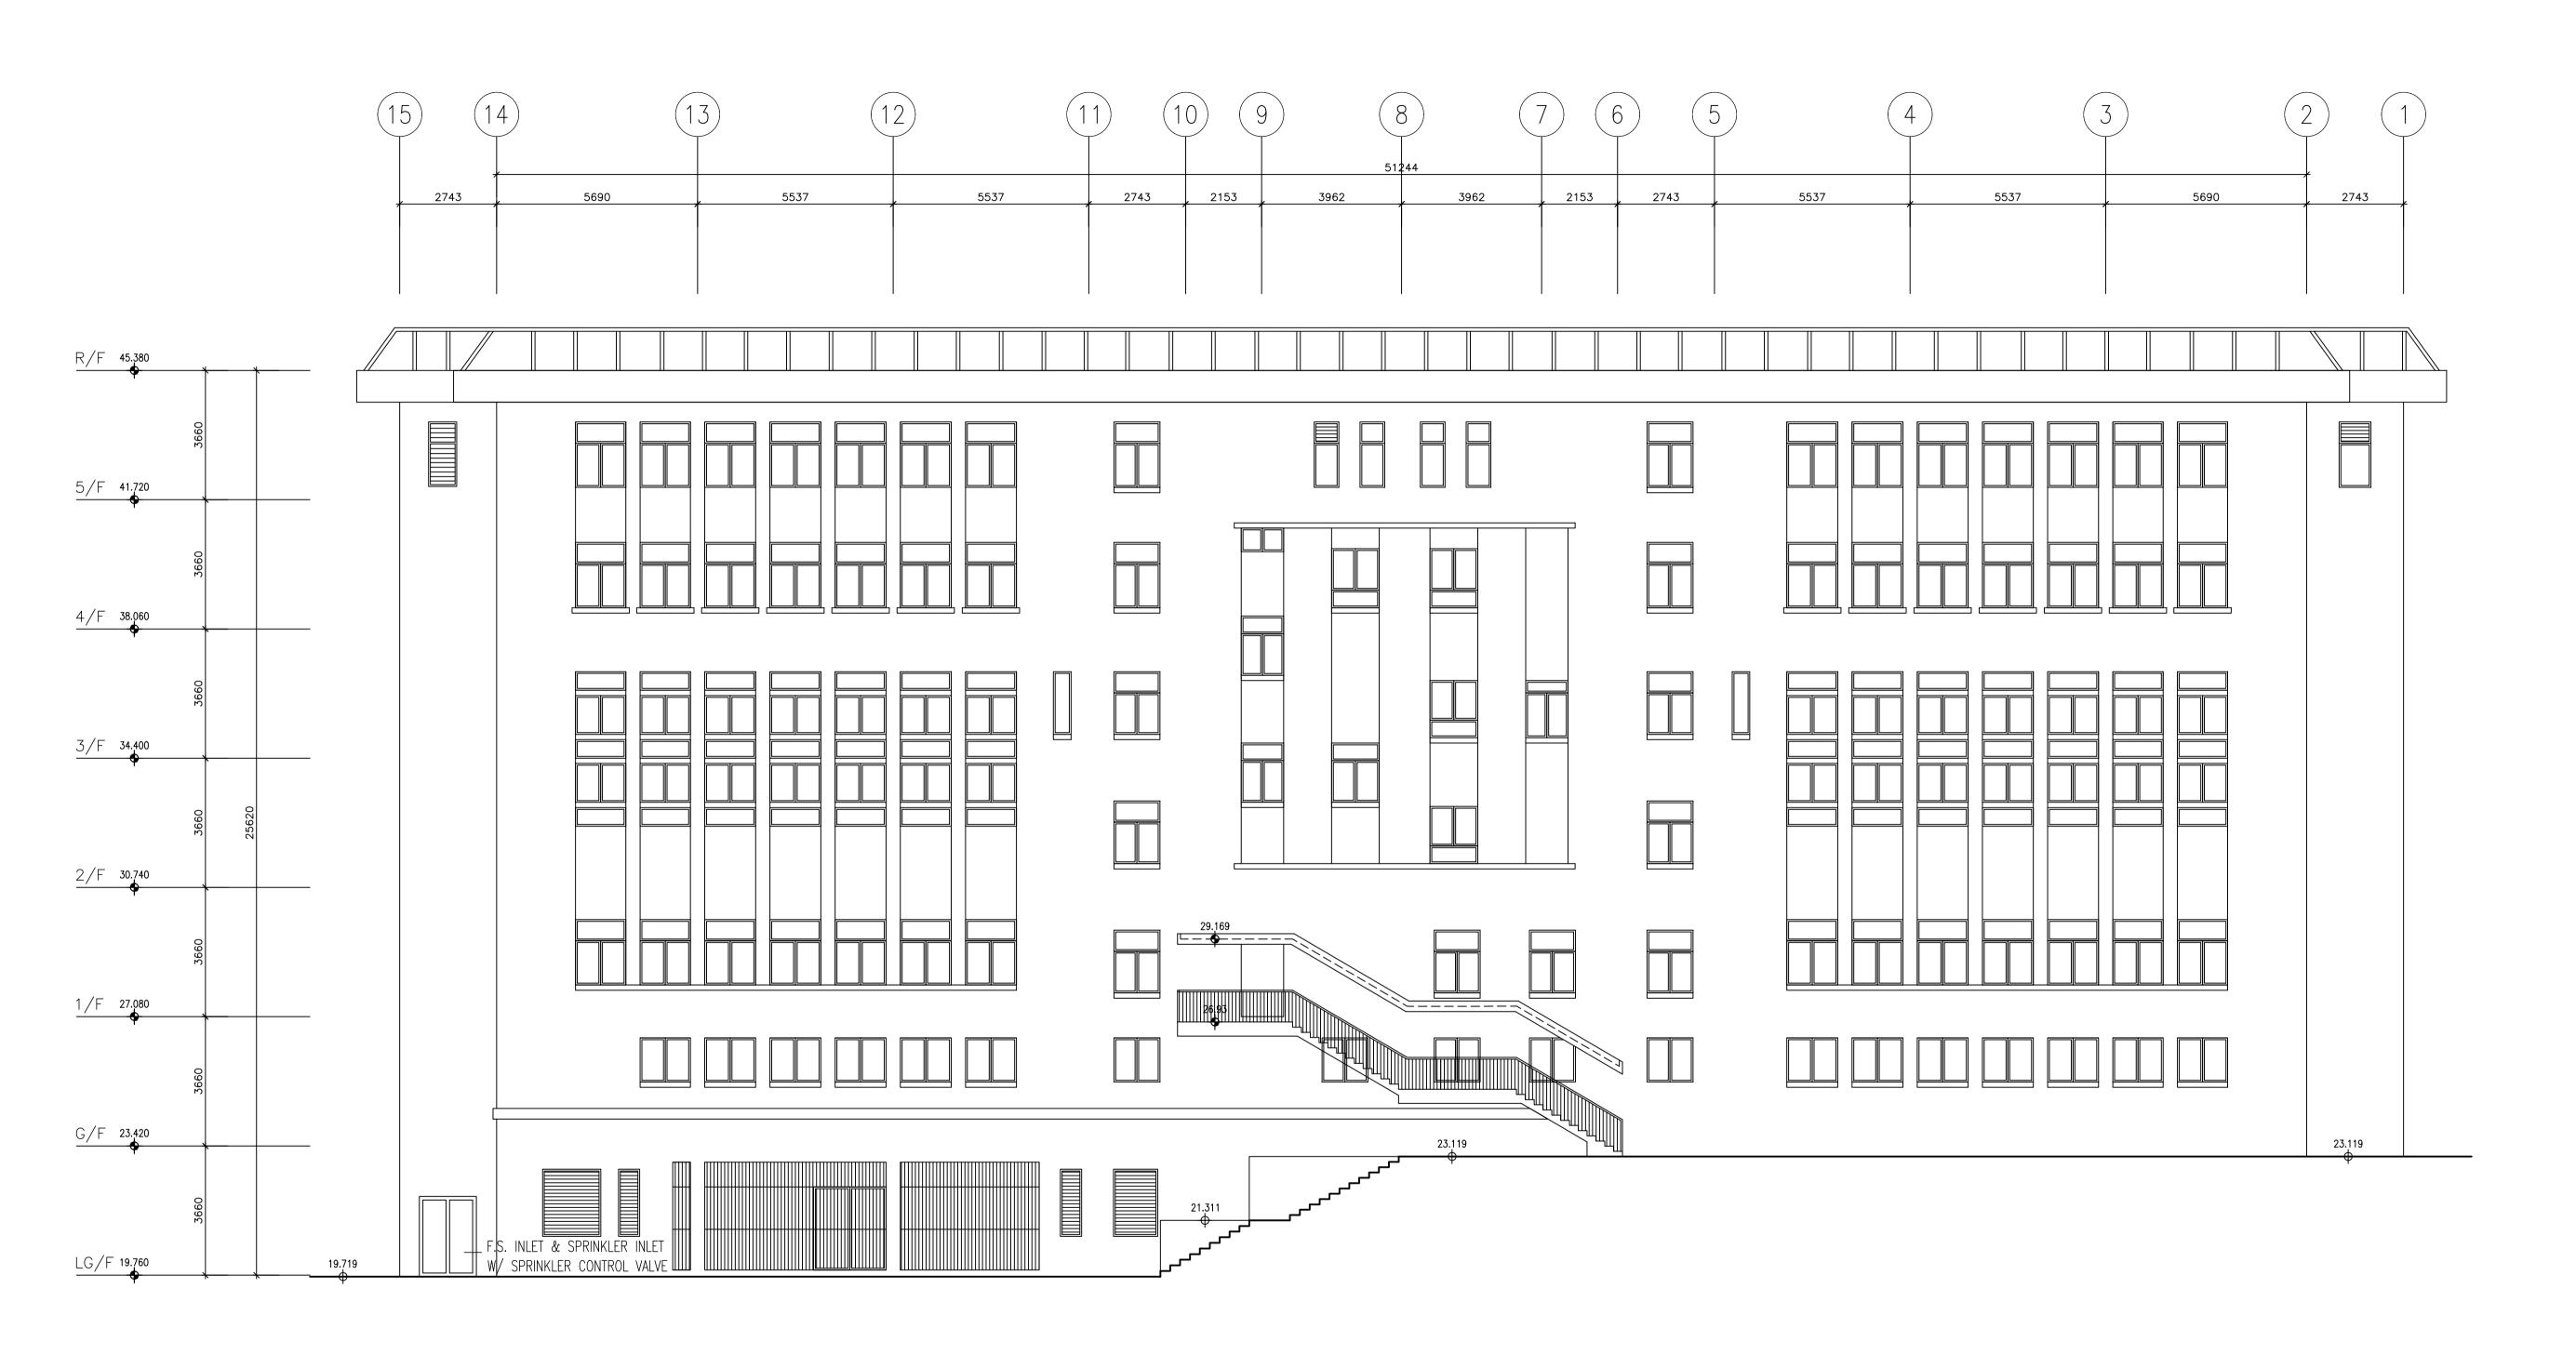

EAST ELEVATION



LEGEND: FINISHED FLOOR LEVEL STRUCTURAL FLOOR LEVEL

REMARKS: FLOOR LEVEL ANNOTATED IS IN ACCORDANCE WITH THE LATEST APPROVED BUILDING PLANS APPROVED BY BUILDINGS DEPARTMENT IN 2010.



CONSULTANT:

ARCHITECTURAL SERVICES DEPARTMENT


JOHN H Y YIP Surveyors Ltd.

葉浩然測量師德譽 JOHN HY YIP SURVEYORS LTD.
ROOM 6F, 6/F,
EFFORT INDUSTRIAL BUILDING
2-8 KUNG YIP STREET, KWAI CHUNG,
NEW TERRITORIES, HONG KONG
TEL: 2155 0938 FAX: 2155 0933


PROJECT TITLE: RESOURCE KIT FOR FORMER NORTH KOWLOON MAGISTRACY, NO.292 TAI PO ROAD, SHAM SHUI PO, KOWLOON

DRAWING TITLE: EAST ELEVATION

DATE	DRAWN	DESIGNED	CHEKCED	SCALE
27/5/2020				1:100 (in A1)
JOB NO:	•	DRAWIN	G NO:	
JY-2	20079)J		
FILE REF X:\JHYY\04 Pro Kit for Former HRT-022020\03 Plan\As-built\2	oject∖20079J - North Kowloon 3 -	NK	-14	

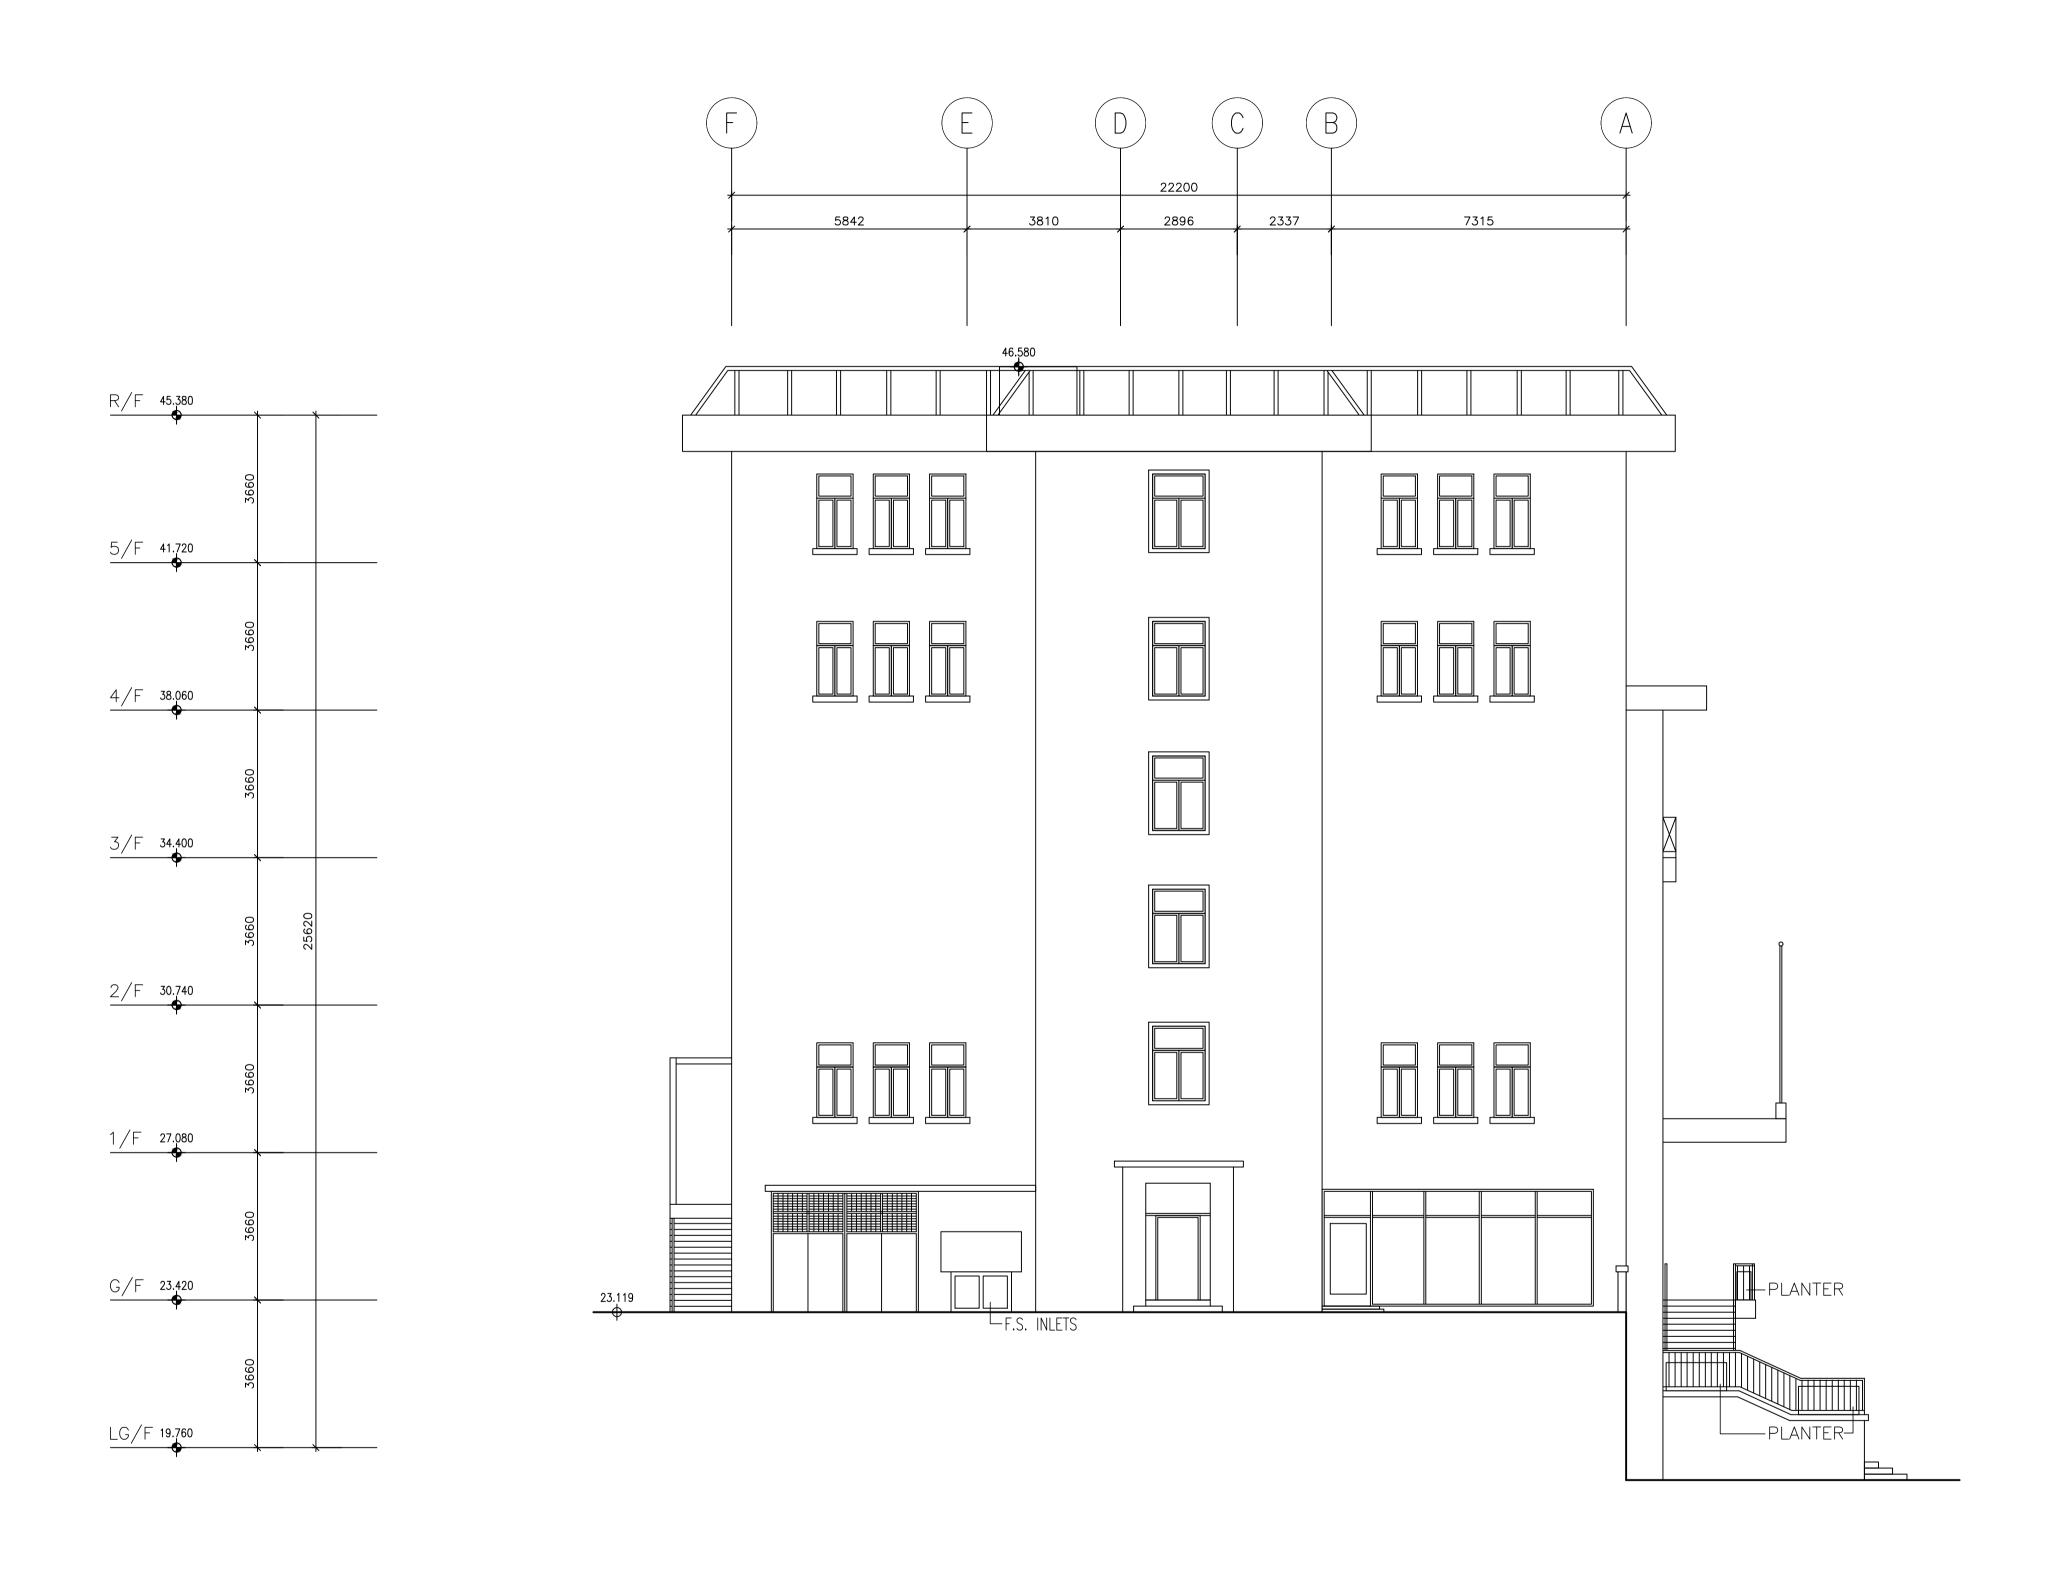

NORTH ELEVATION

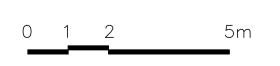

LEGEND:

FINISHED FLOOR LEVEL

STRUCTURAL FLOOR LEVEL

REMARKS: FLOOR LEVEL ANNOTATED IS IN ACCORDANCE WITH THE LATEST APPROVED BUILDING PLANS APPROVED BY BUILDINGS DEPARTMENT IN 2010.



CONSULTANT:



JOHN HY YIP SURVEYORS LTD.
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NEW TERRITORIES, HONG KONG
TEL: 2155 0938 FAX: 2155 0933

PROJECT TITLE:

RESOURCE KIT FOR

FORMER NORTH

KOWLOON MAGISTRACY,

NO.292 TAI PO ROAD,

SHAM SHUI PO,

KOWLOON

DRAWING TITLE:
NORTH ELEVATION

DATE	DRAWN	DESIGNED	CHEKCED	SCALE
27/5/2020				1:100 (in A1
JOB NO:	:		DRAWIN	IG NO:
JY-2	20079)J		
X:\JHYY\04 Pro Kit for Former HRT-022020\03	oject∖20079J - North Kowloon 3 -	Magistracy	NK	— 1 5
	27/5/2020 JOB NO JY — 2 FILE REI X:\JHYY\04 Pro Kit for Former HRT-022020\0.	27/5/2020 JOB NO: JY — 2007 S FILE REF: X:\JHYY\04 Project\20079J — Kit for Former North Kowloon HRT-022020\03 -	JOB NO: JY—20079J FILE REF: X:\JHYY\04 Project\20079J - Resource kit for Former North Kowloon Magistracy	JOB NO: JY—20079J FILE REF: X:\JHY\04 Project\20079J - Resource Kit for Former North Kowloon Magistracy HRT-02200\03 -

Appendix VI(B)


Building Services Reference Drawings


Appendix VI(B) – Building Services Reference Drawings <u>Drawing List</u>


	Drawing No.	Drawing Title			
Drai	nage				
1.	0903/D/G01	Legend, Abbreviation, Drawing List, Material Schedule, general Notes, Site Plan & Schematic Diagram for Soil & Waste System			
2.	0903/D/L01	Drainage Layout for Lower Ground Floor Plan			
3.	0903/D/L02	Drainage Layout for Ground Floor Plan			
4.	0903/D/L03	Drainage Layout for First Floor Plan			
5.	0903/D/L04	Drainage Layout for Second Floor Plan			
6.	0903/D/L05	Drainage Layout for Third Floor Plan			
7.	0903/D/L06	Drainage Layout for Fourth Floor Plan			
8.	0903/D/L07	Drainage Layout for Fifth Floor Plan			
9.	0903/D/L08	Drainage Layout for Roof Plan			
10.	0903/D/M02	Standard Details for Drainage System (II)			
11.	0903/D/M01	Standard Details for Drainage System (I)			
12.	0903/D/L09	Drainage Layout for F.S. & Sprinkler Pump Room			
13.		DSD's Record extracted from GeoInfo Map			
Plun	nbing				
1.	0903/P/S01	Schematic Diagram for Plumbing System			
ACN	MV				
1.	0903/AC/S01	ACMV Air-Side Ducting Schematic Diagram			
2.	0903/AC/S02	ACMV Water-Side Piping Schematic Diagram			
3.	0903/AC/S05	Power Distribution Schematic Diagram for Motor Control Centre			
Fire	Services Installatio	n			
1.	0903/FS/S01	Schematic Diagram for Fire Hydrant & Hose Reel System			
2.	0903/FS/S02	Schematic Diagram for Sprinkler System			
3.	0903/FS/S03	Schematic Diagram for Manual & Automatic Fire Alarm System			
Electricity					
1.	GTL/SCAD/MS	Main Schematic Wiring Diagram of SCAD Hong Kong Campus			


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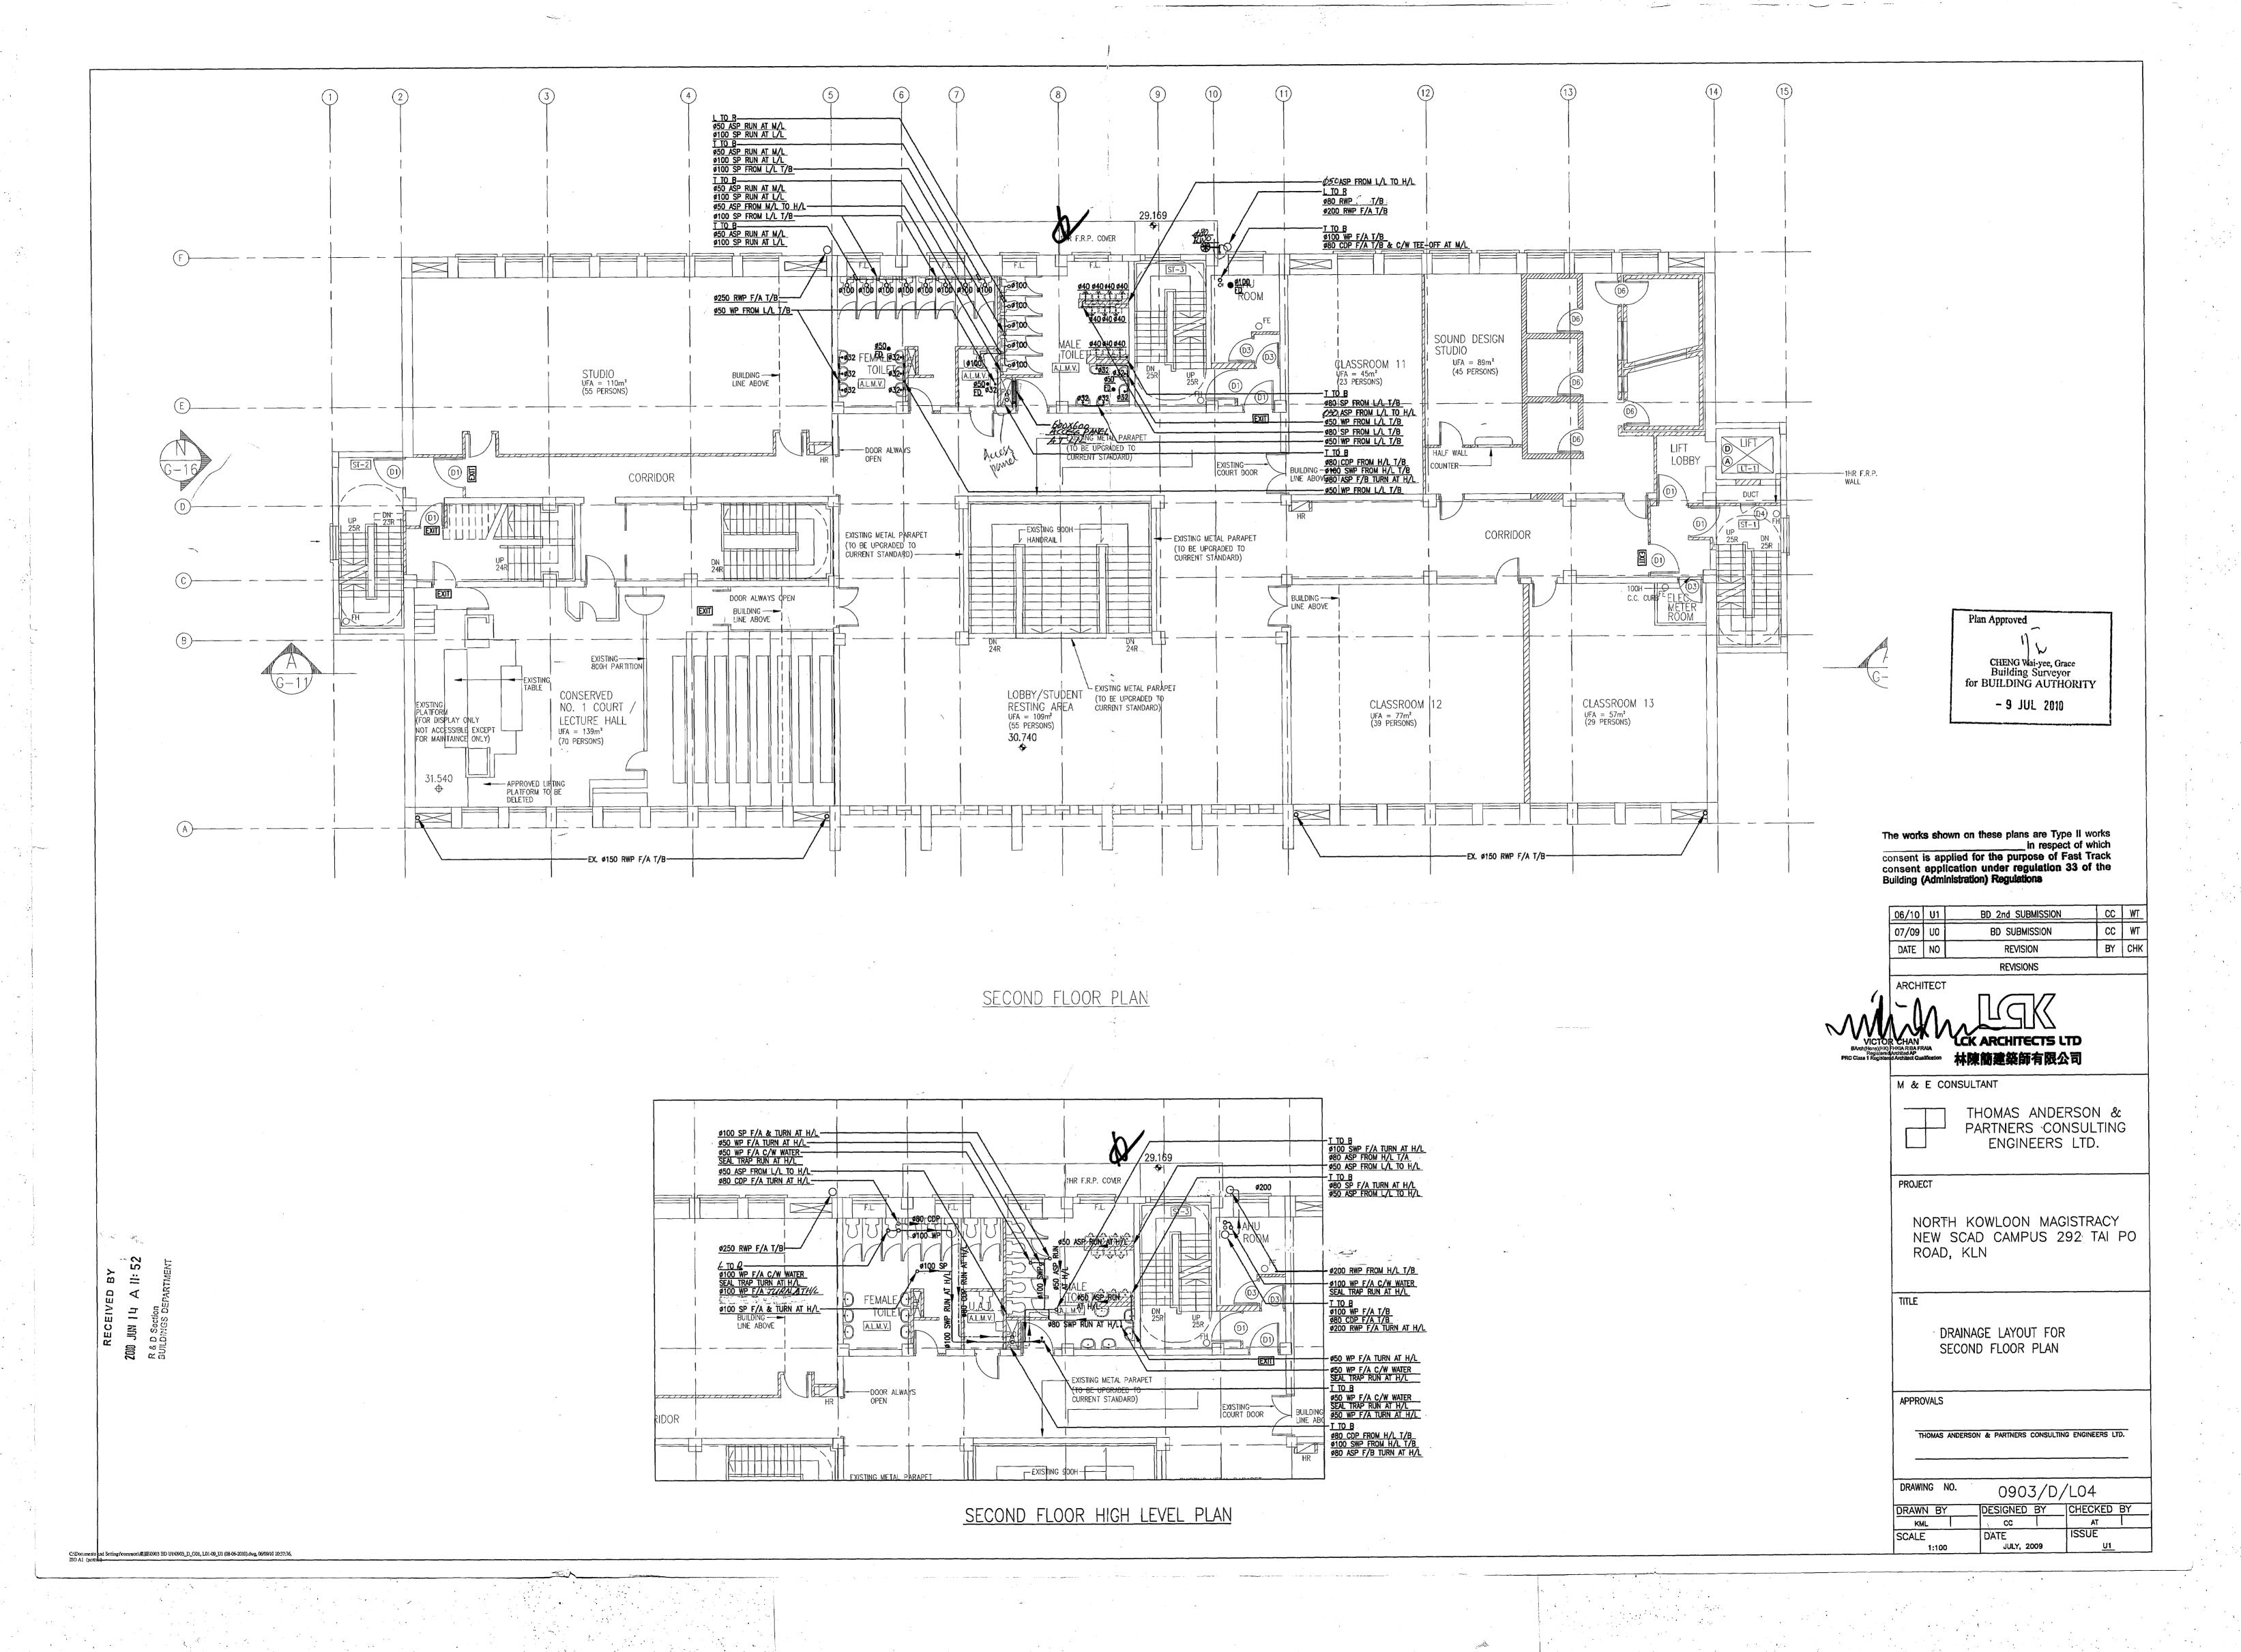
The building services reference drawings were obtained from the previous user and may not reflect the as-built arrangement. The applicant shall check the correctness of the drawings before carrying out their design.




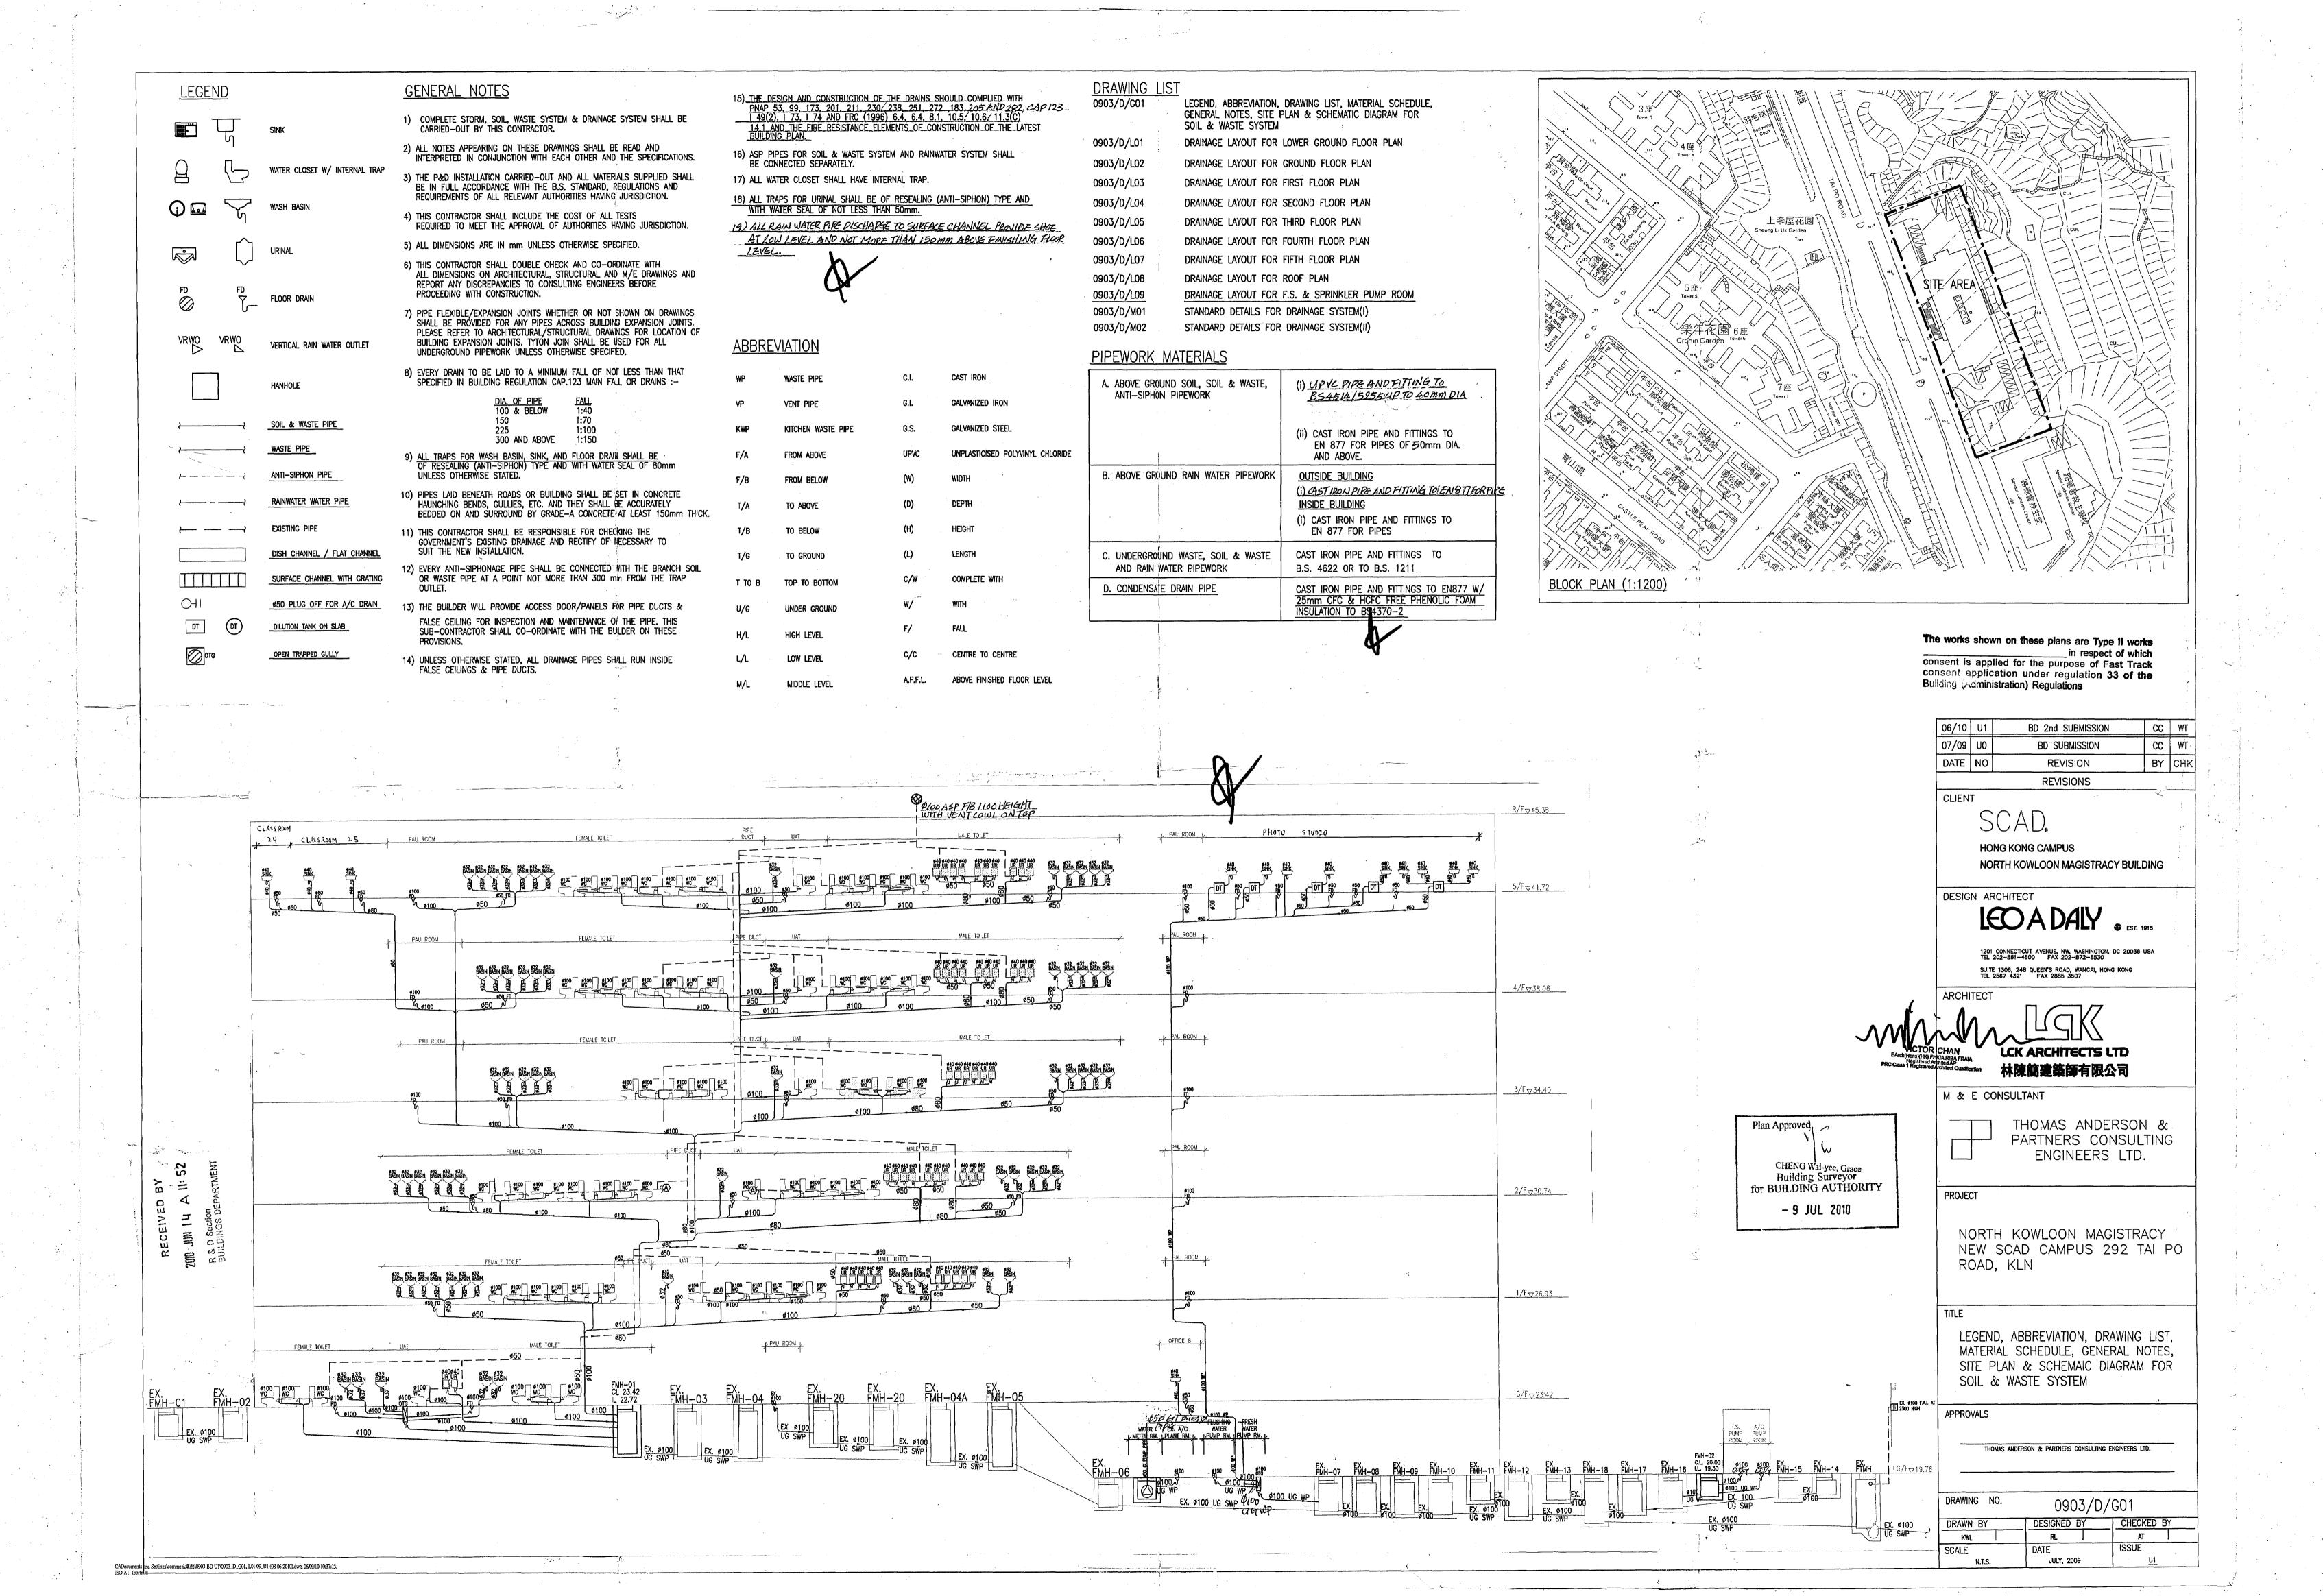


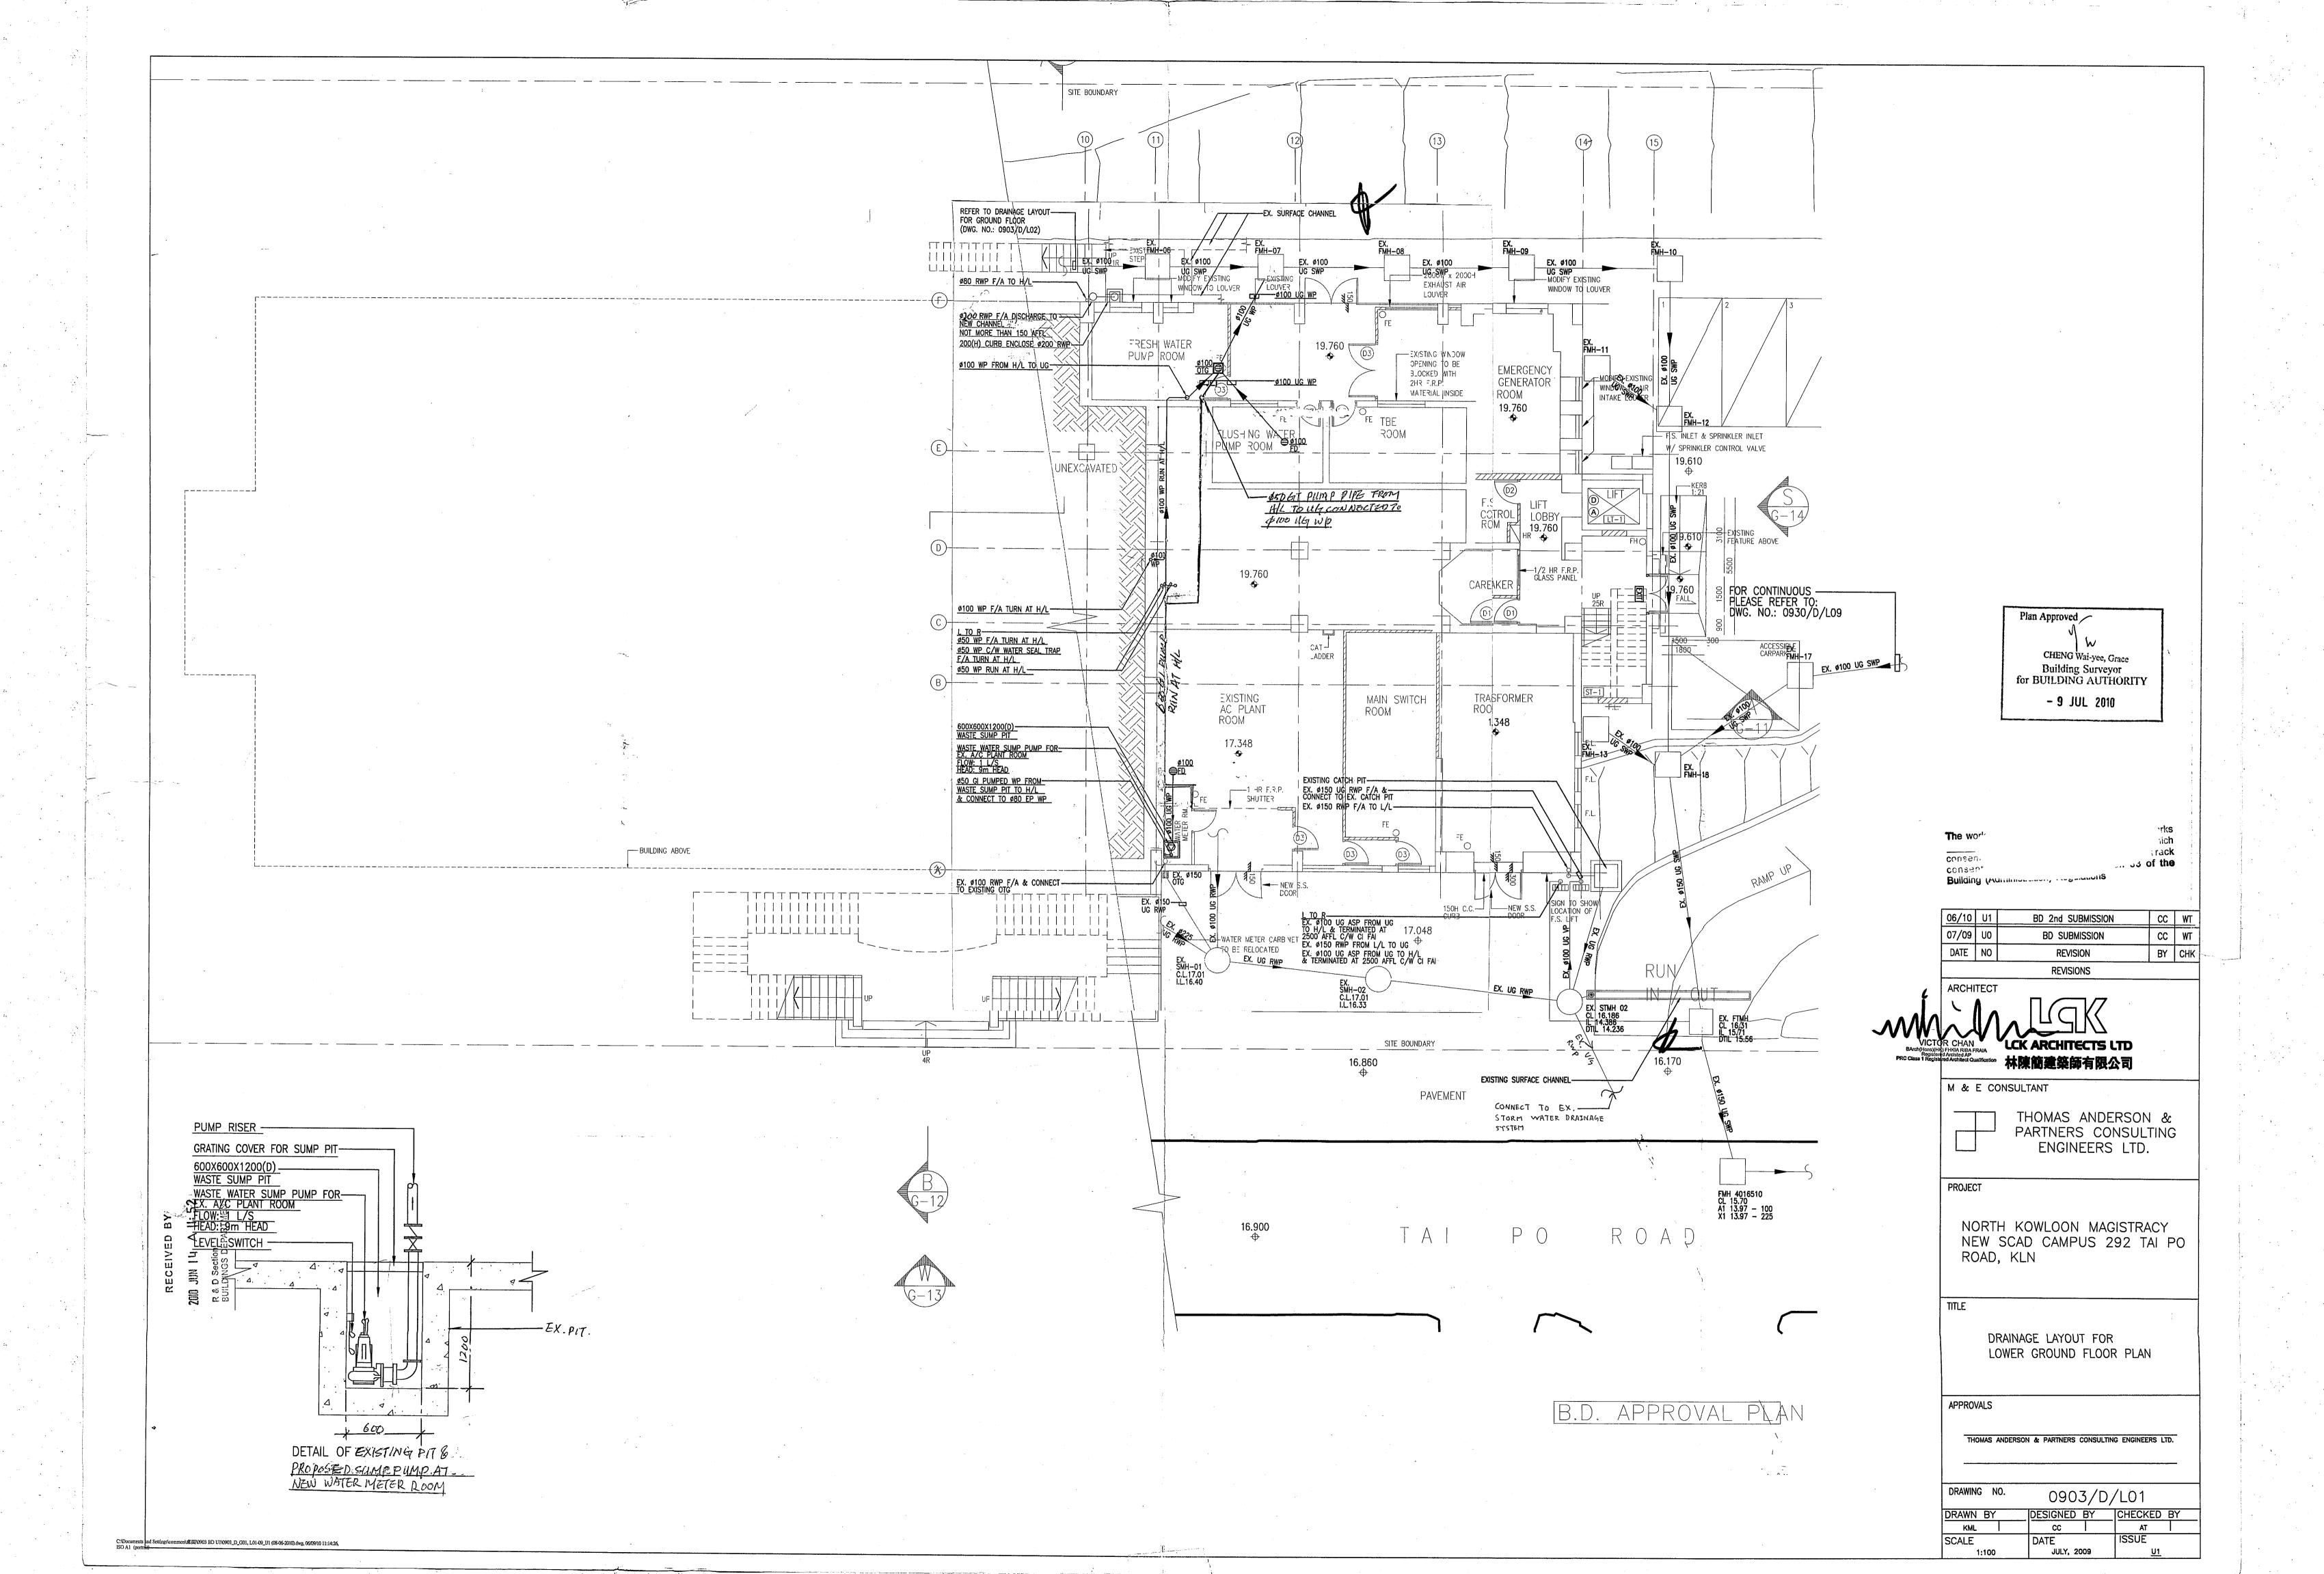


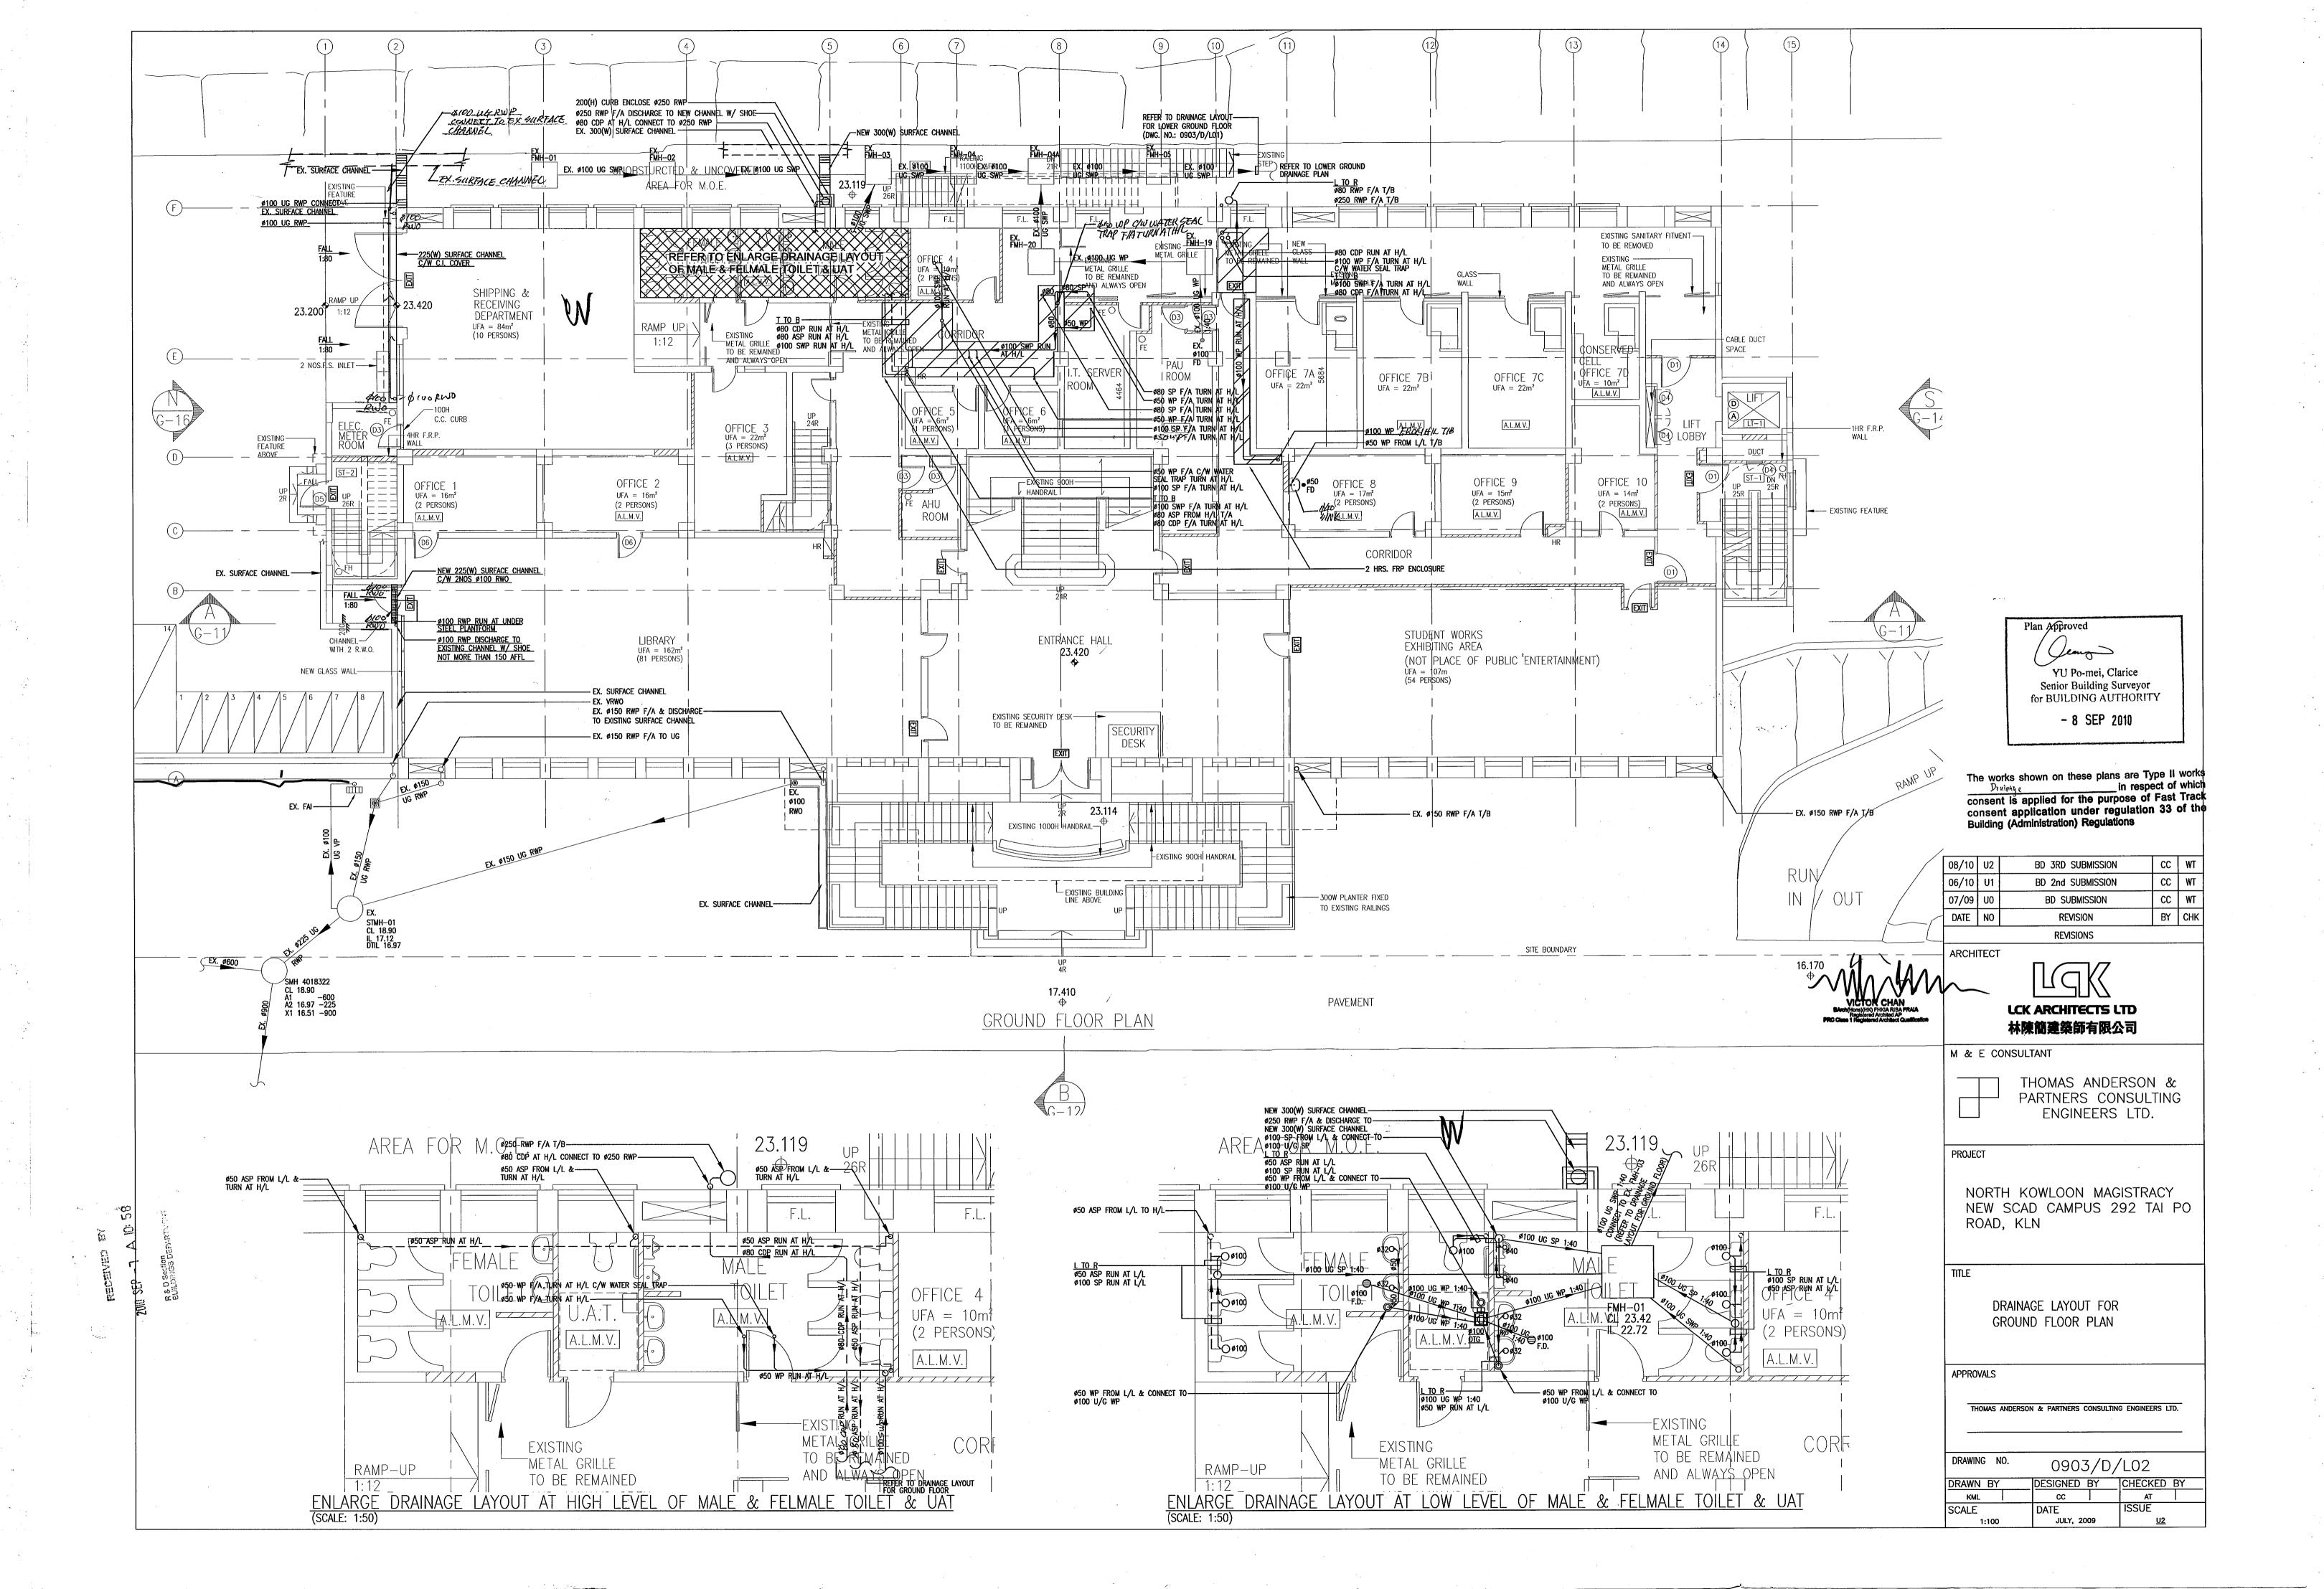


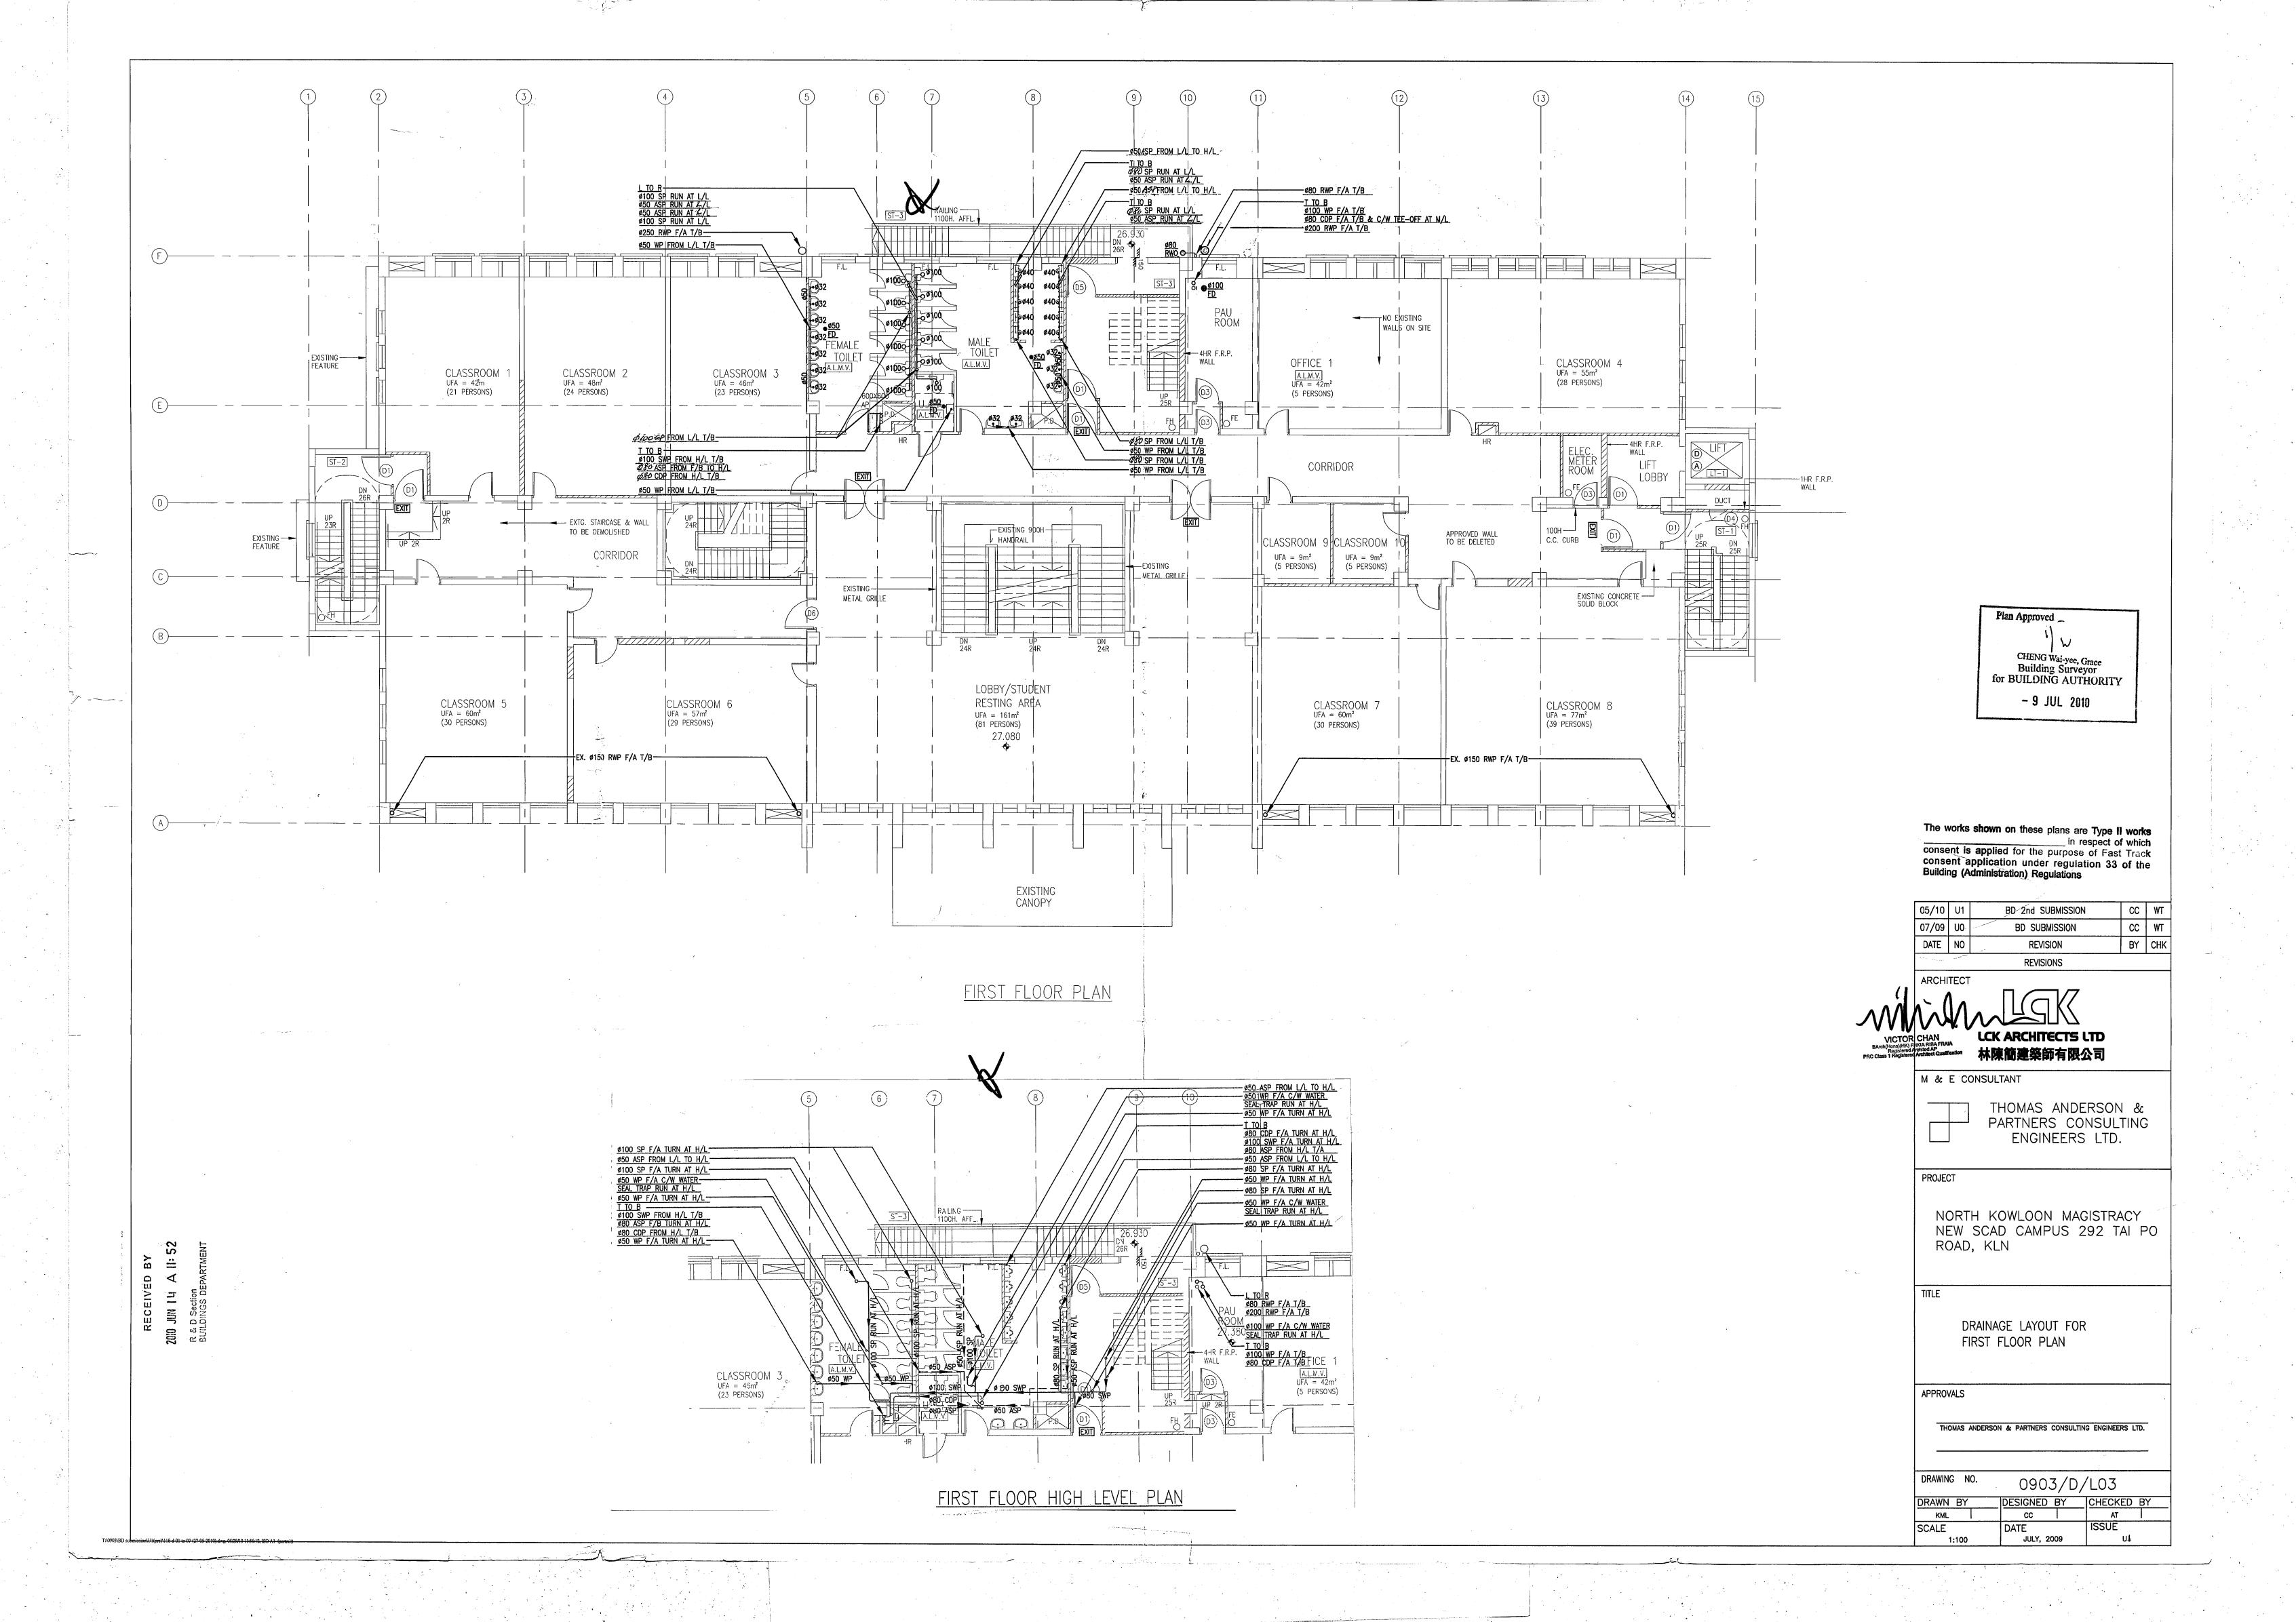


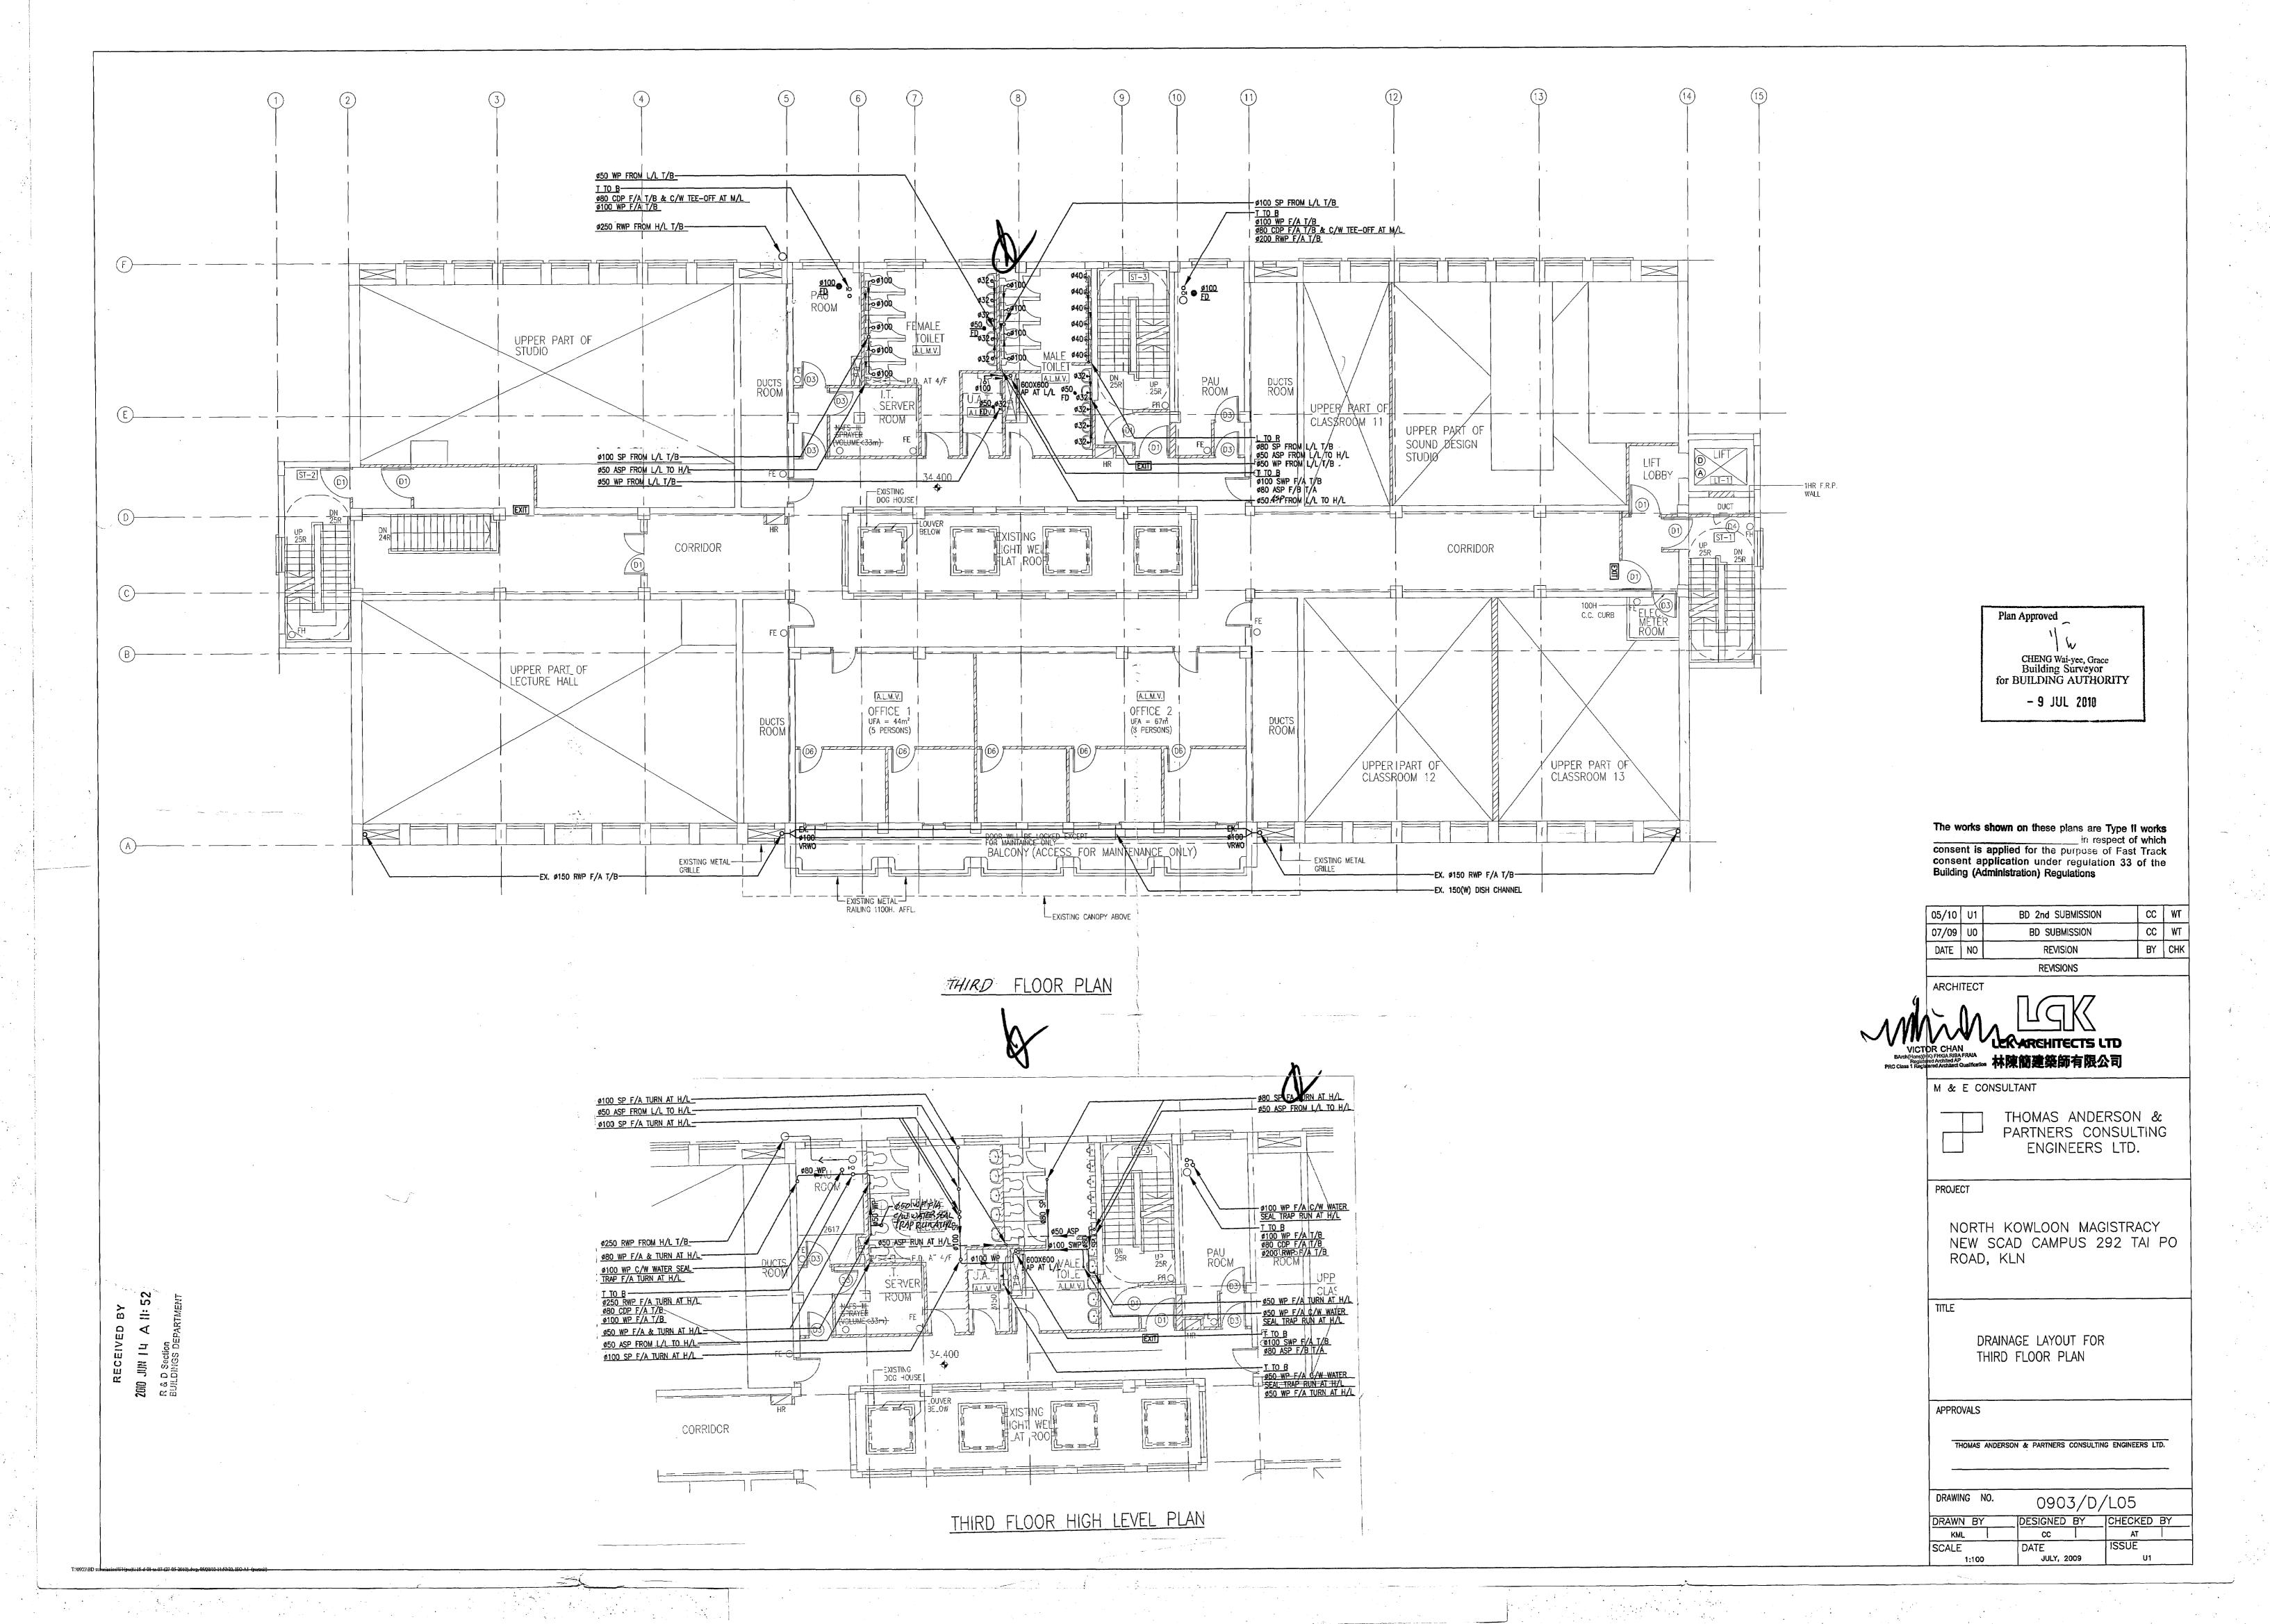

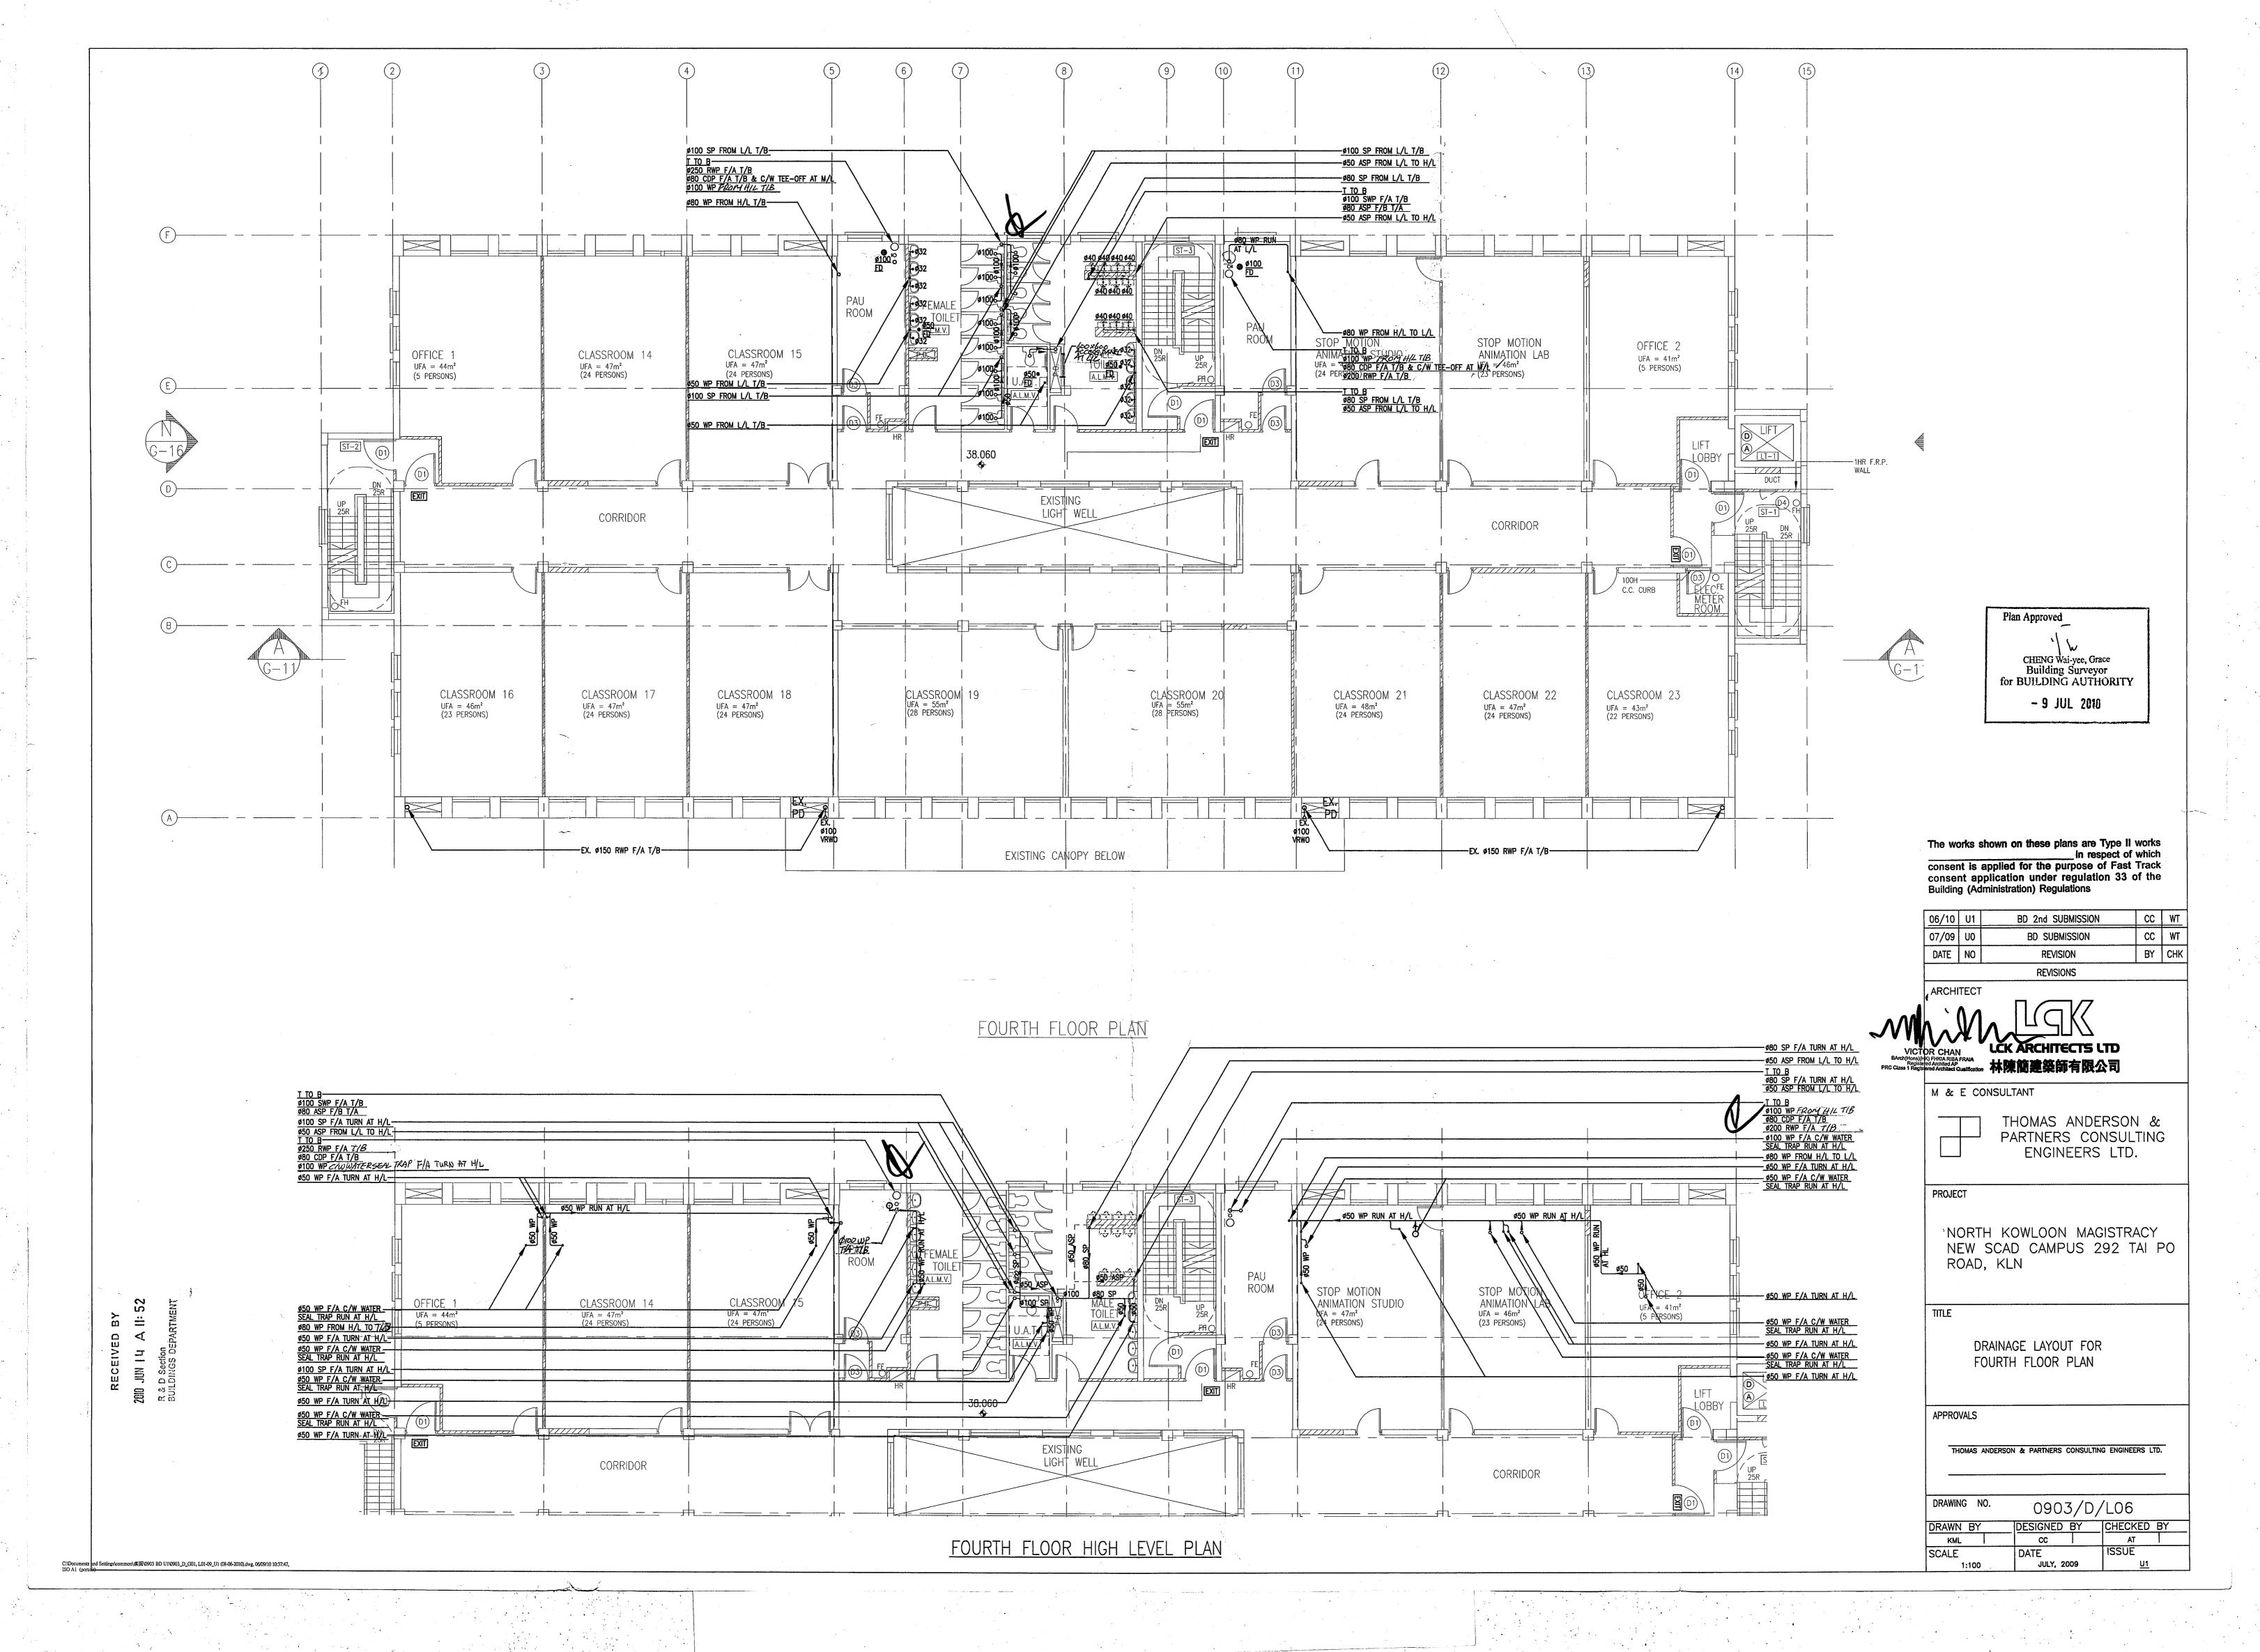


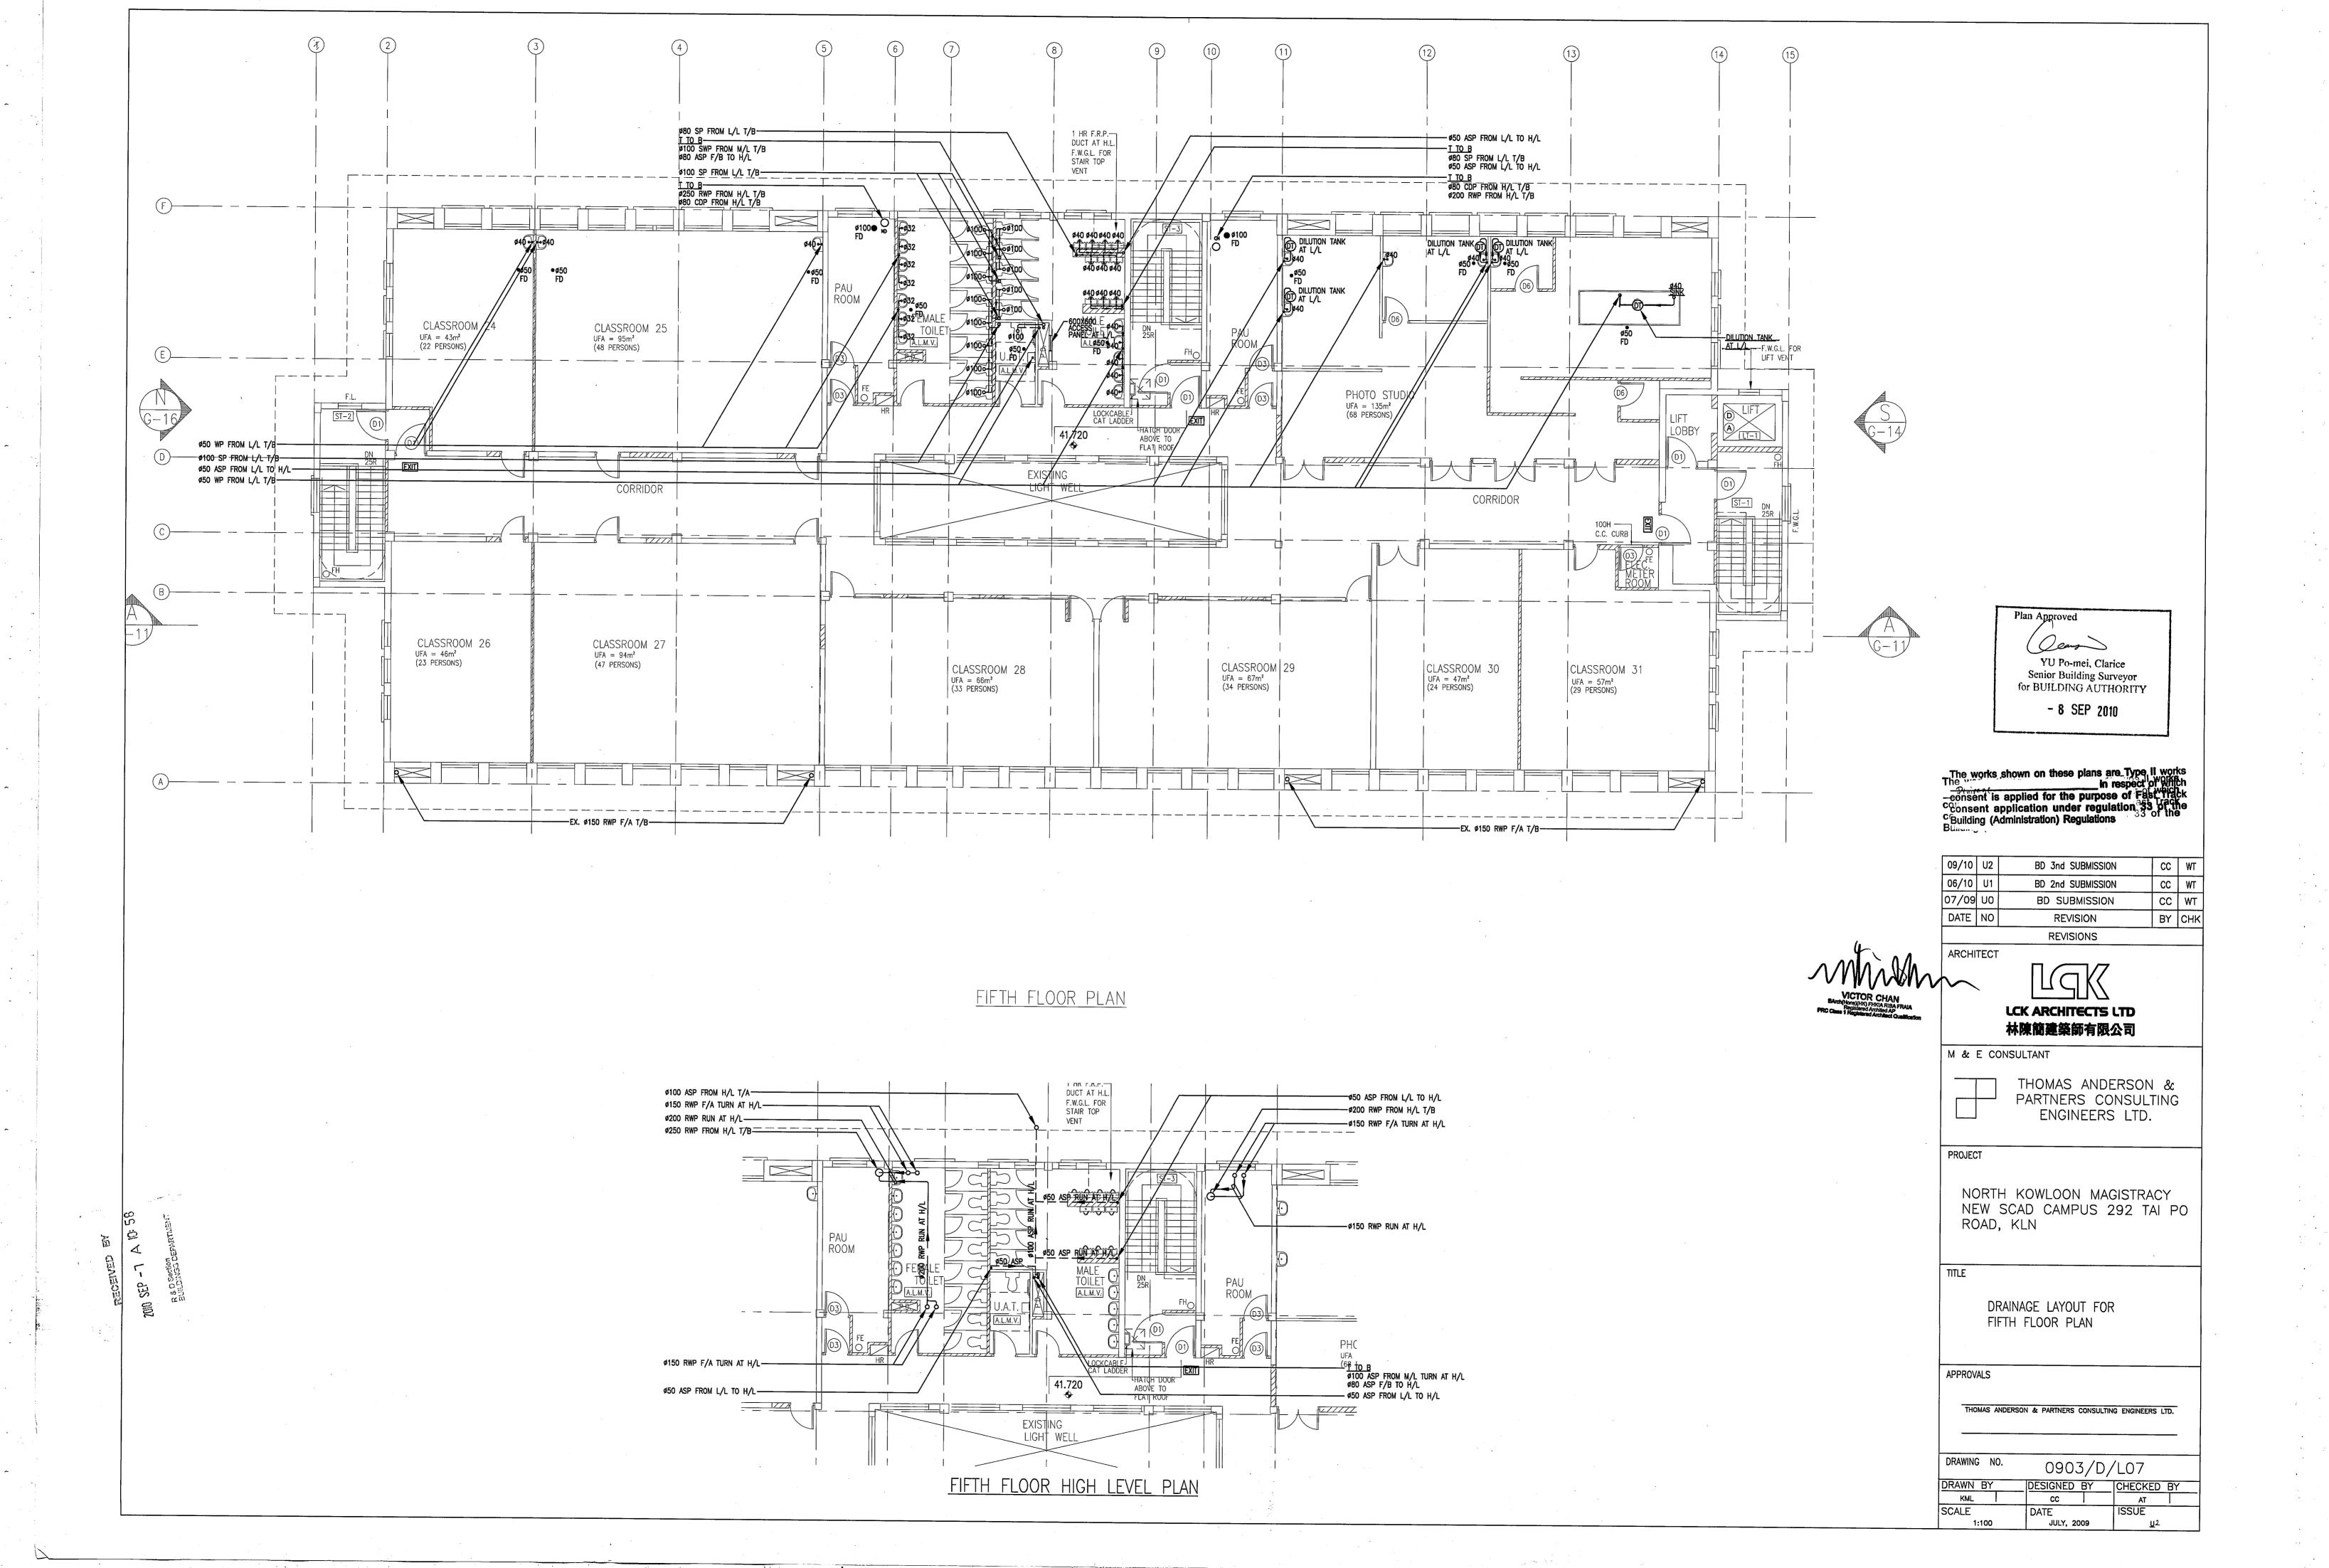


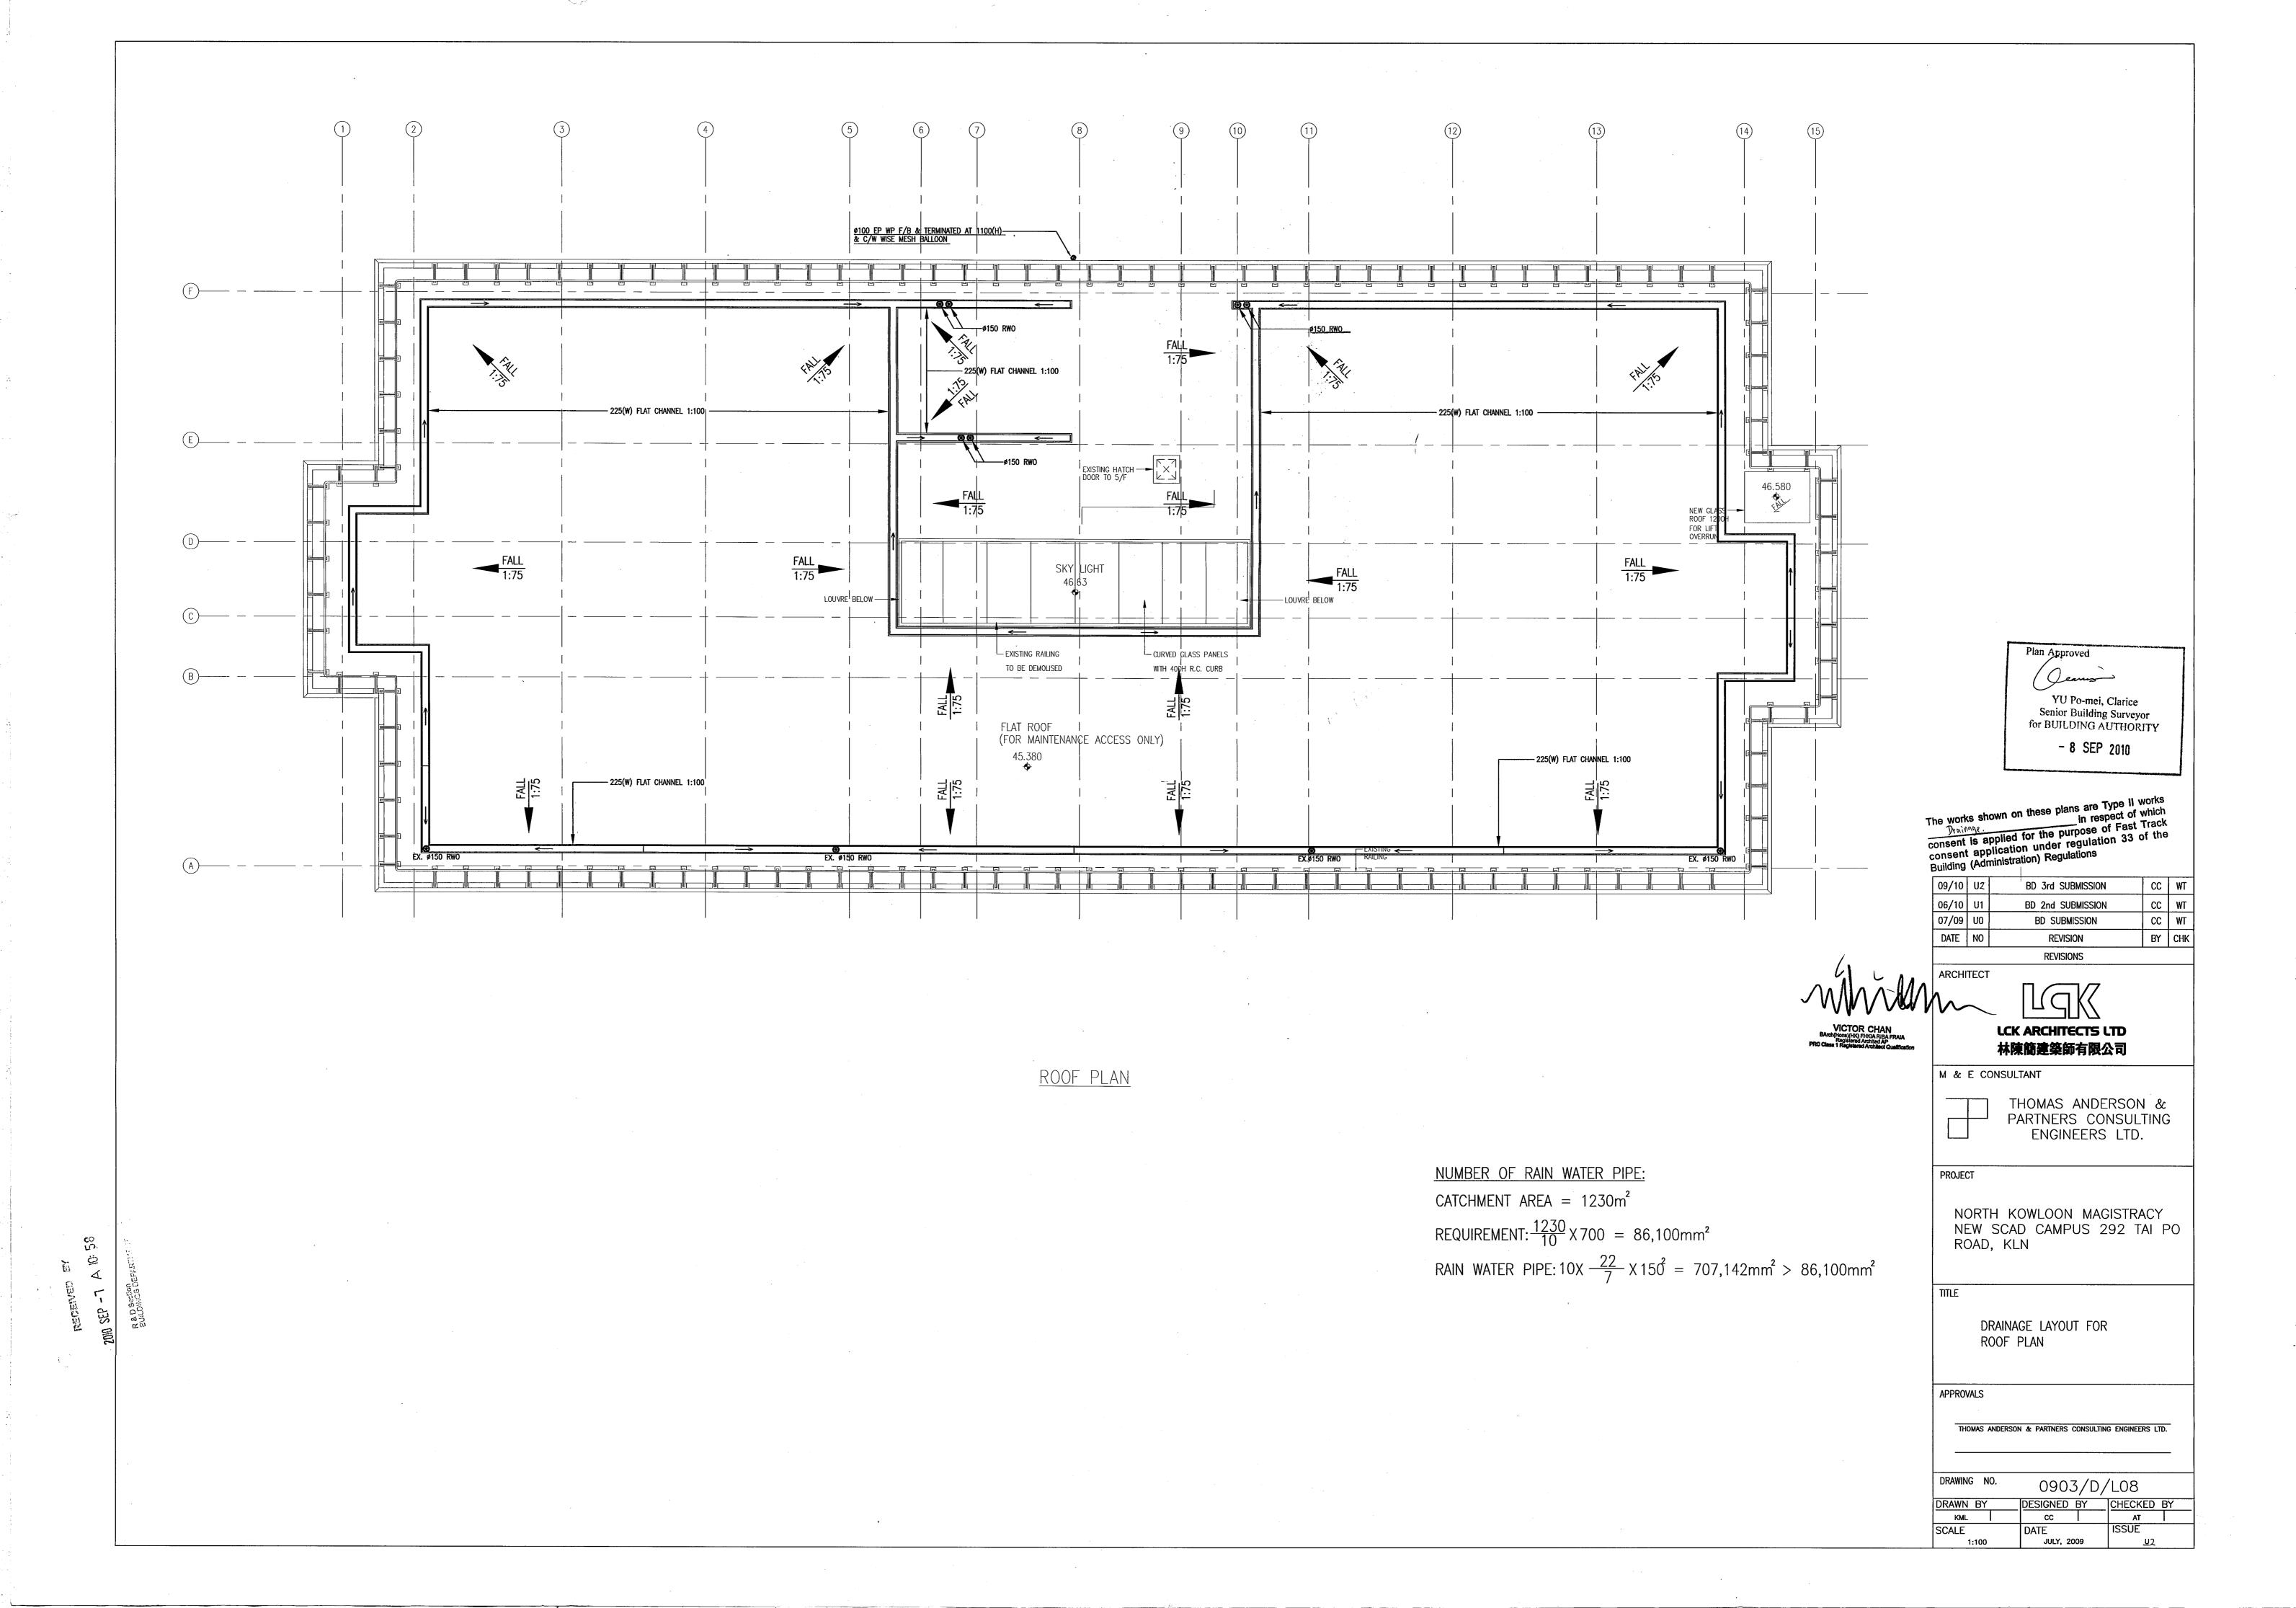

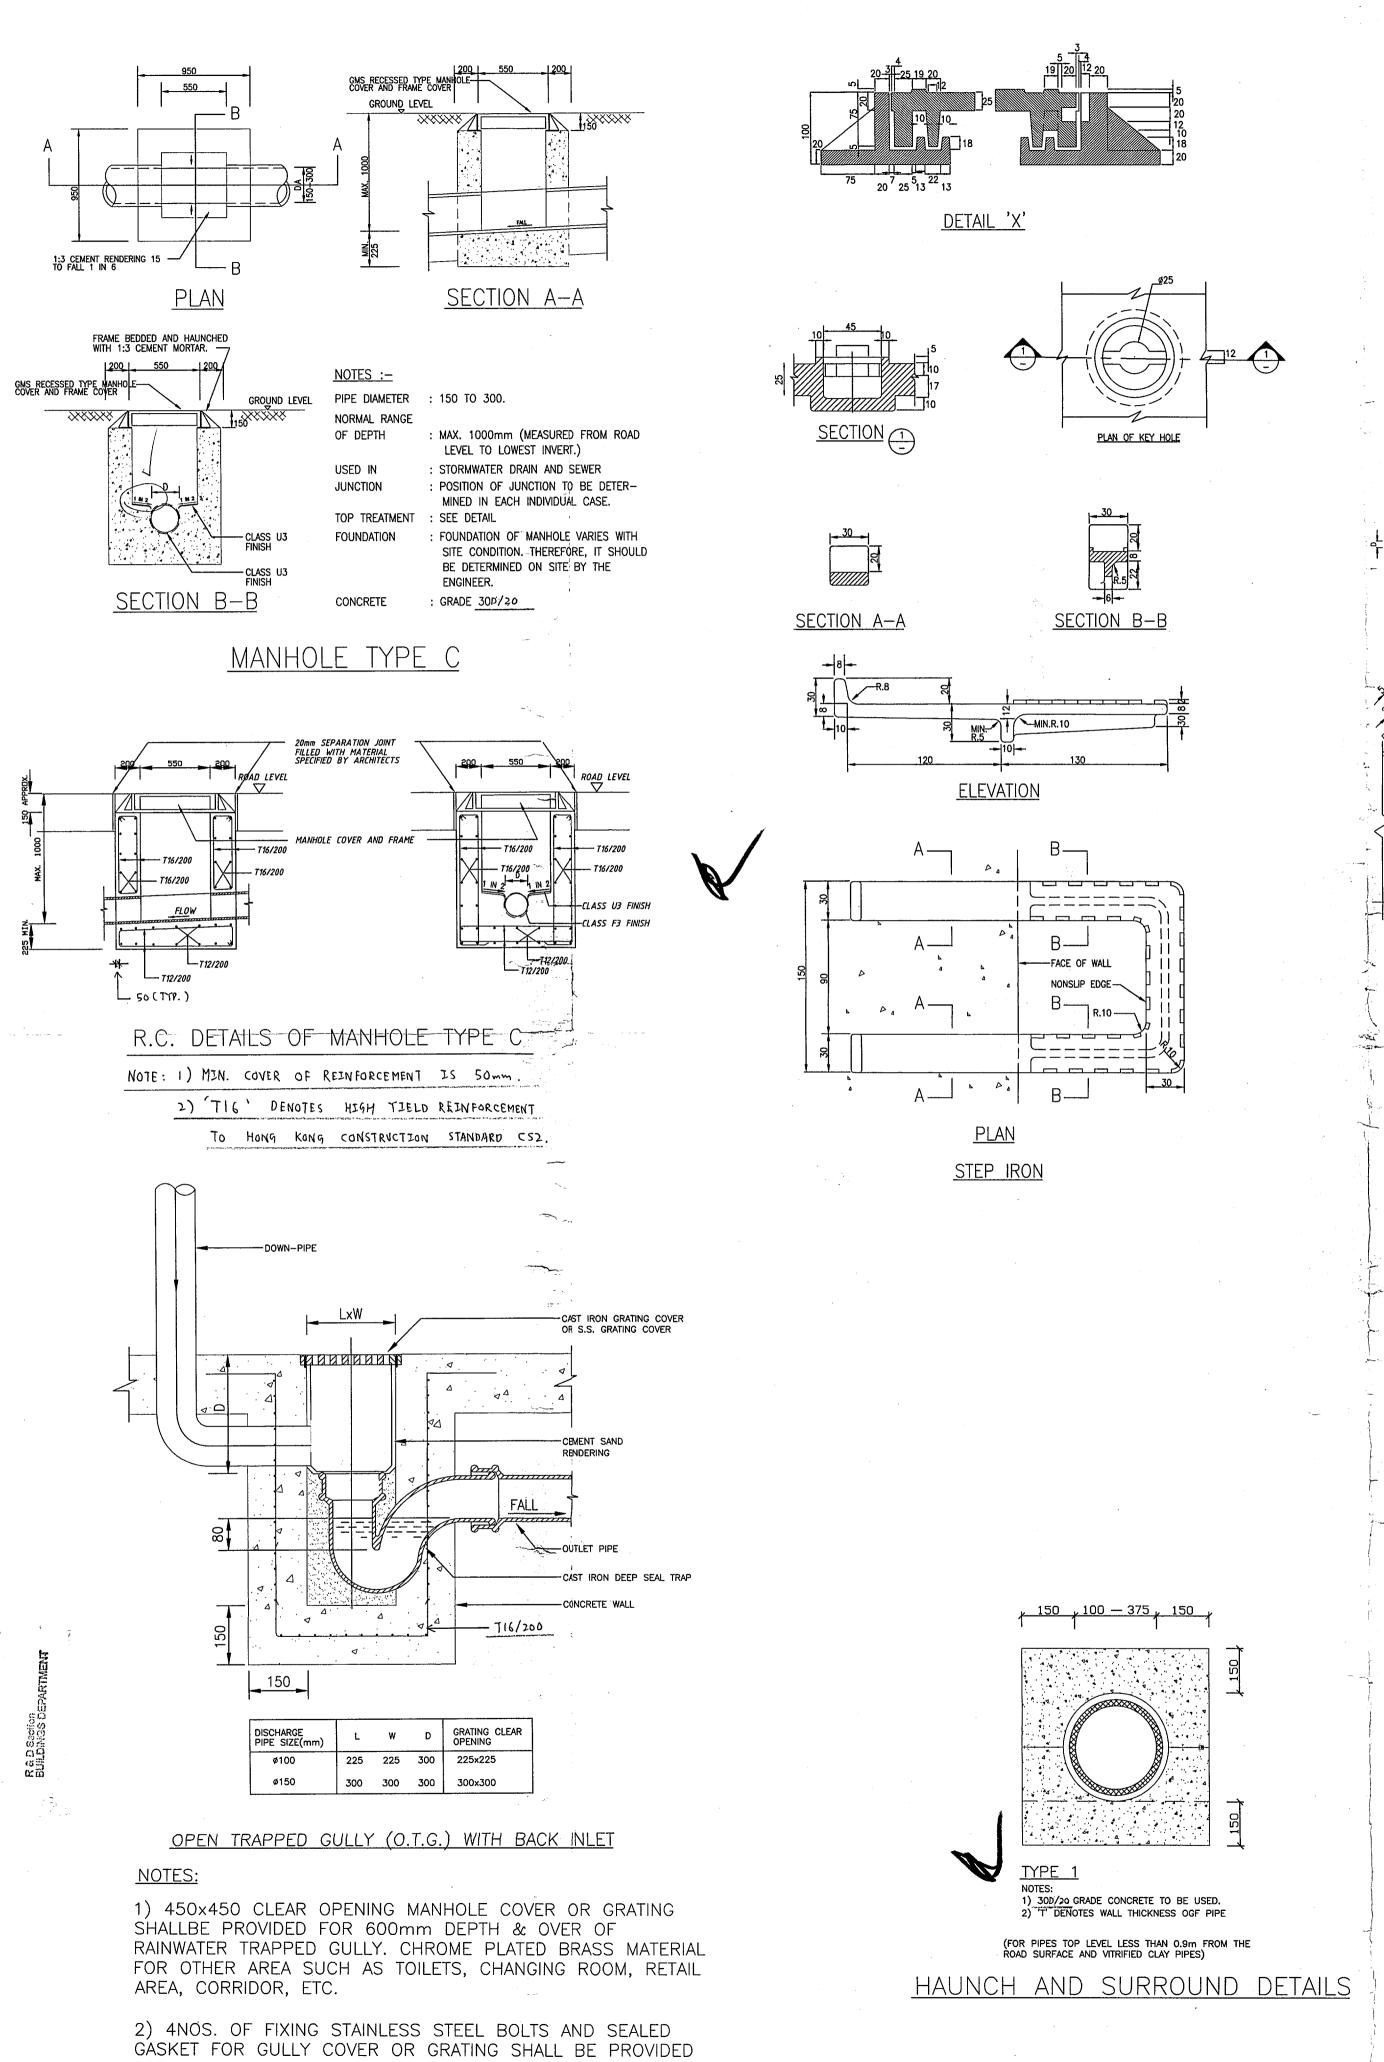


FOR SIZE OF 300mm x 300mm AND BELOW.

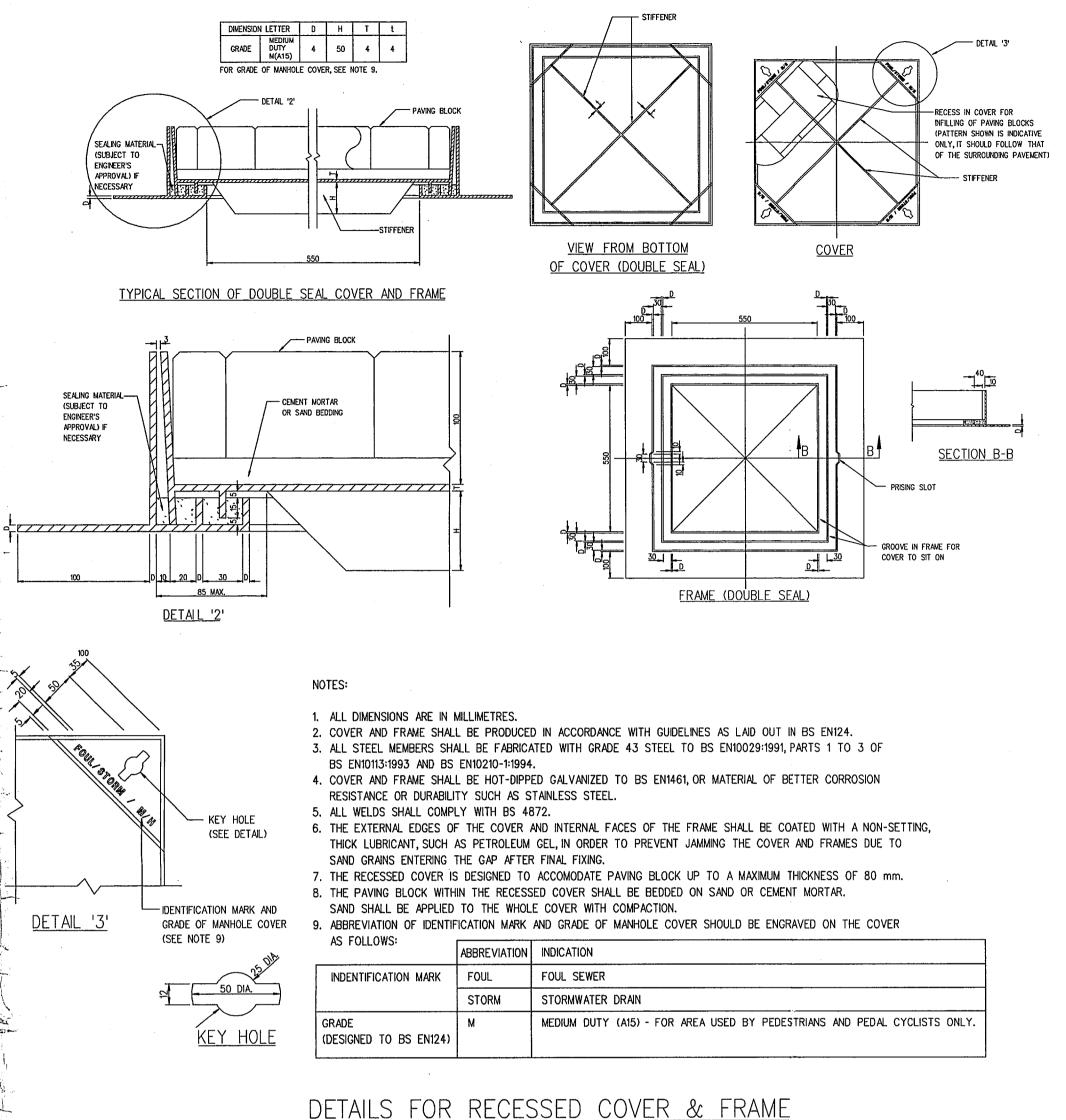

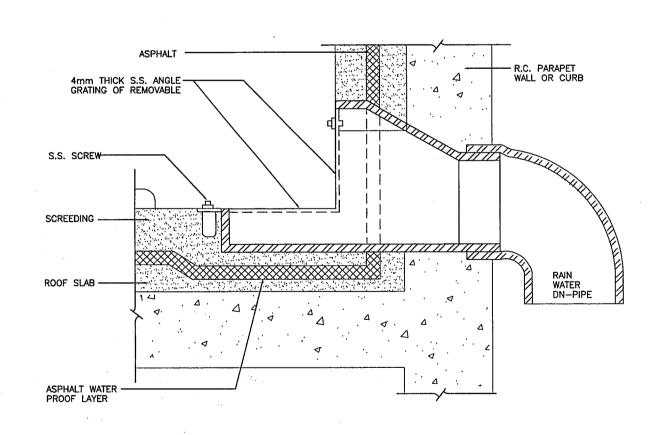


SECTION 'F'-'F'

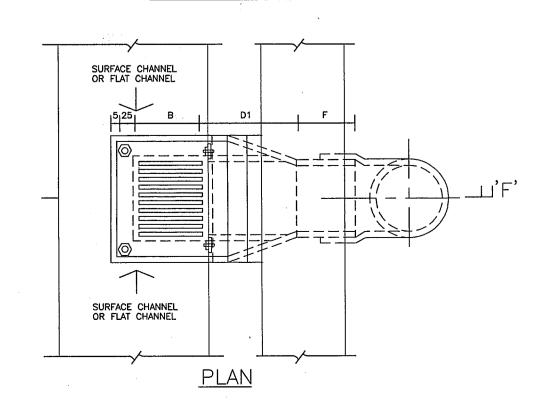

Senior Building Surveyor for BUILDING AUTHORITY 1 7 SEP 2009 07/09 UO BD SUBMISSION

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PROJECT

NORTH KOWLOON MAGISTRACY NEW SCAD CAMPUS 292 TAI PO ROAD, KLN

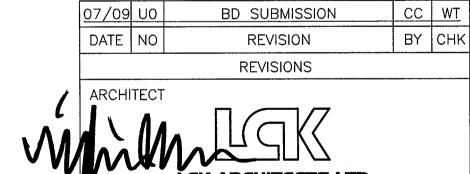
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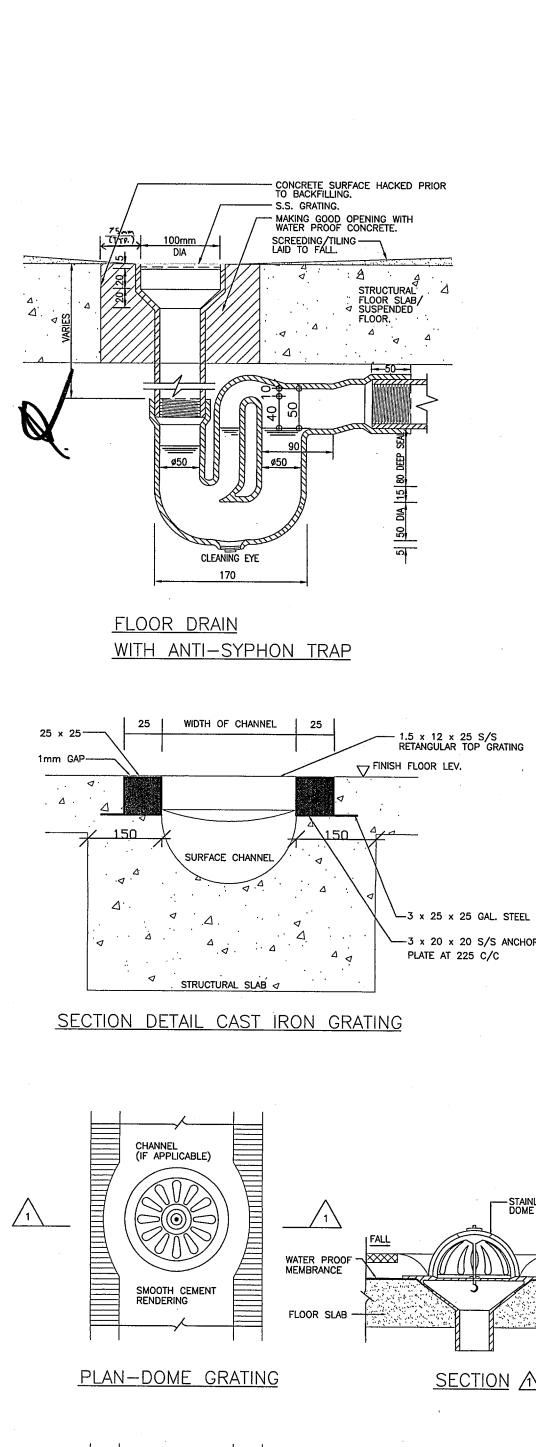
STANDARD DETAILS FOR DRAINAGE SYSTEM (II)


APPROVALS


THOMAS ANDERSON & PARTNERS CONSULTING ENGINEERS LTD.


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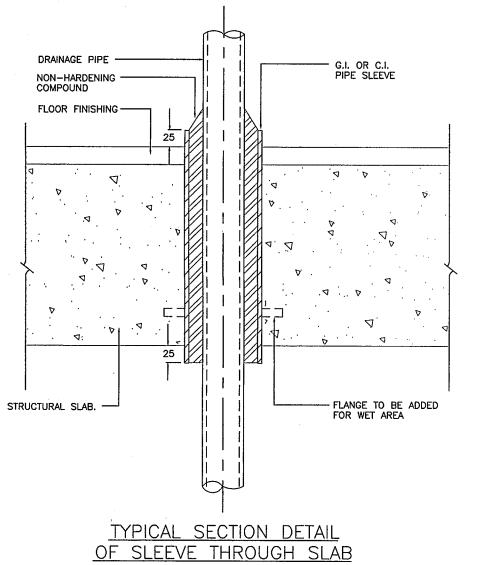




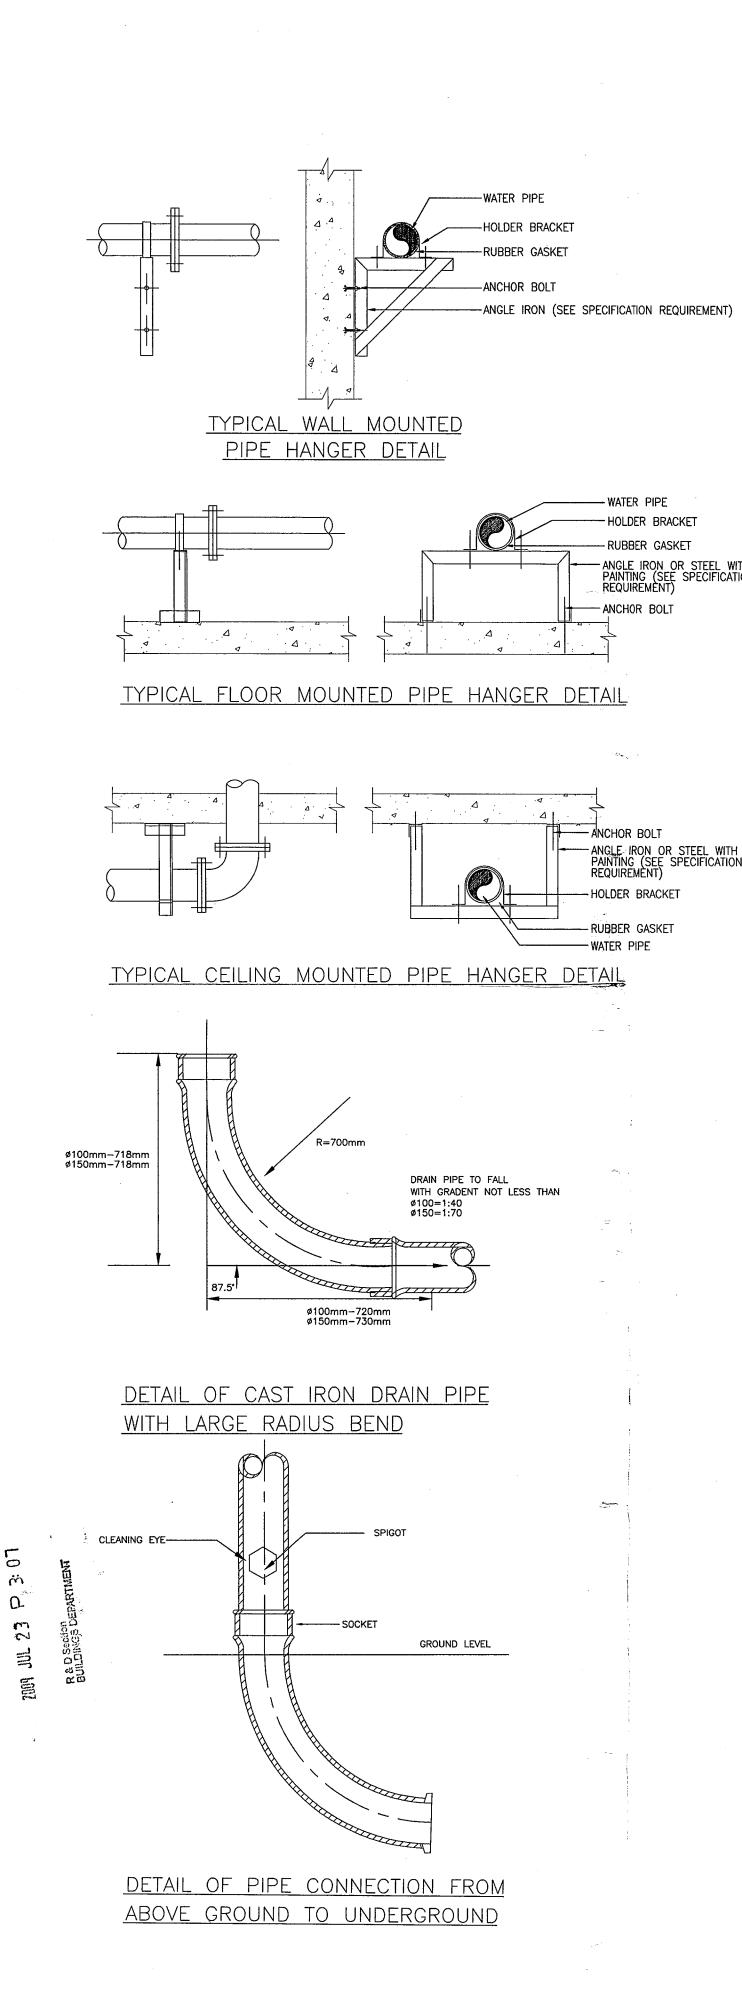

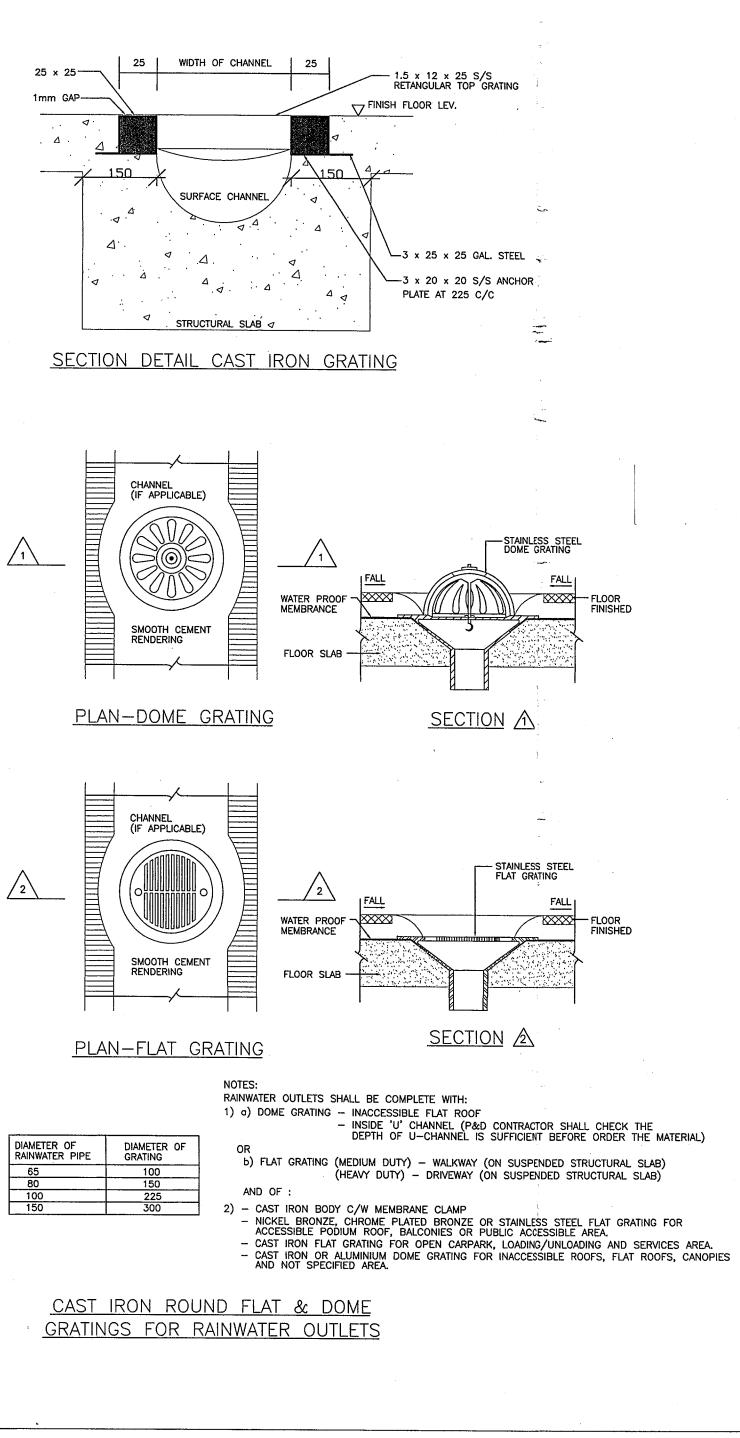


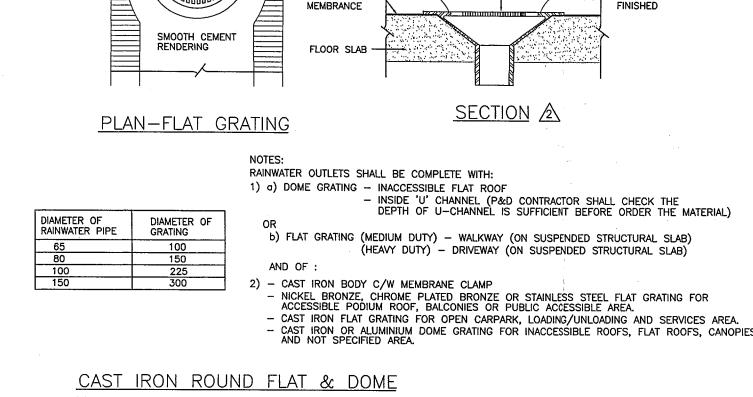-GI OR CI PIPE SLEEVE

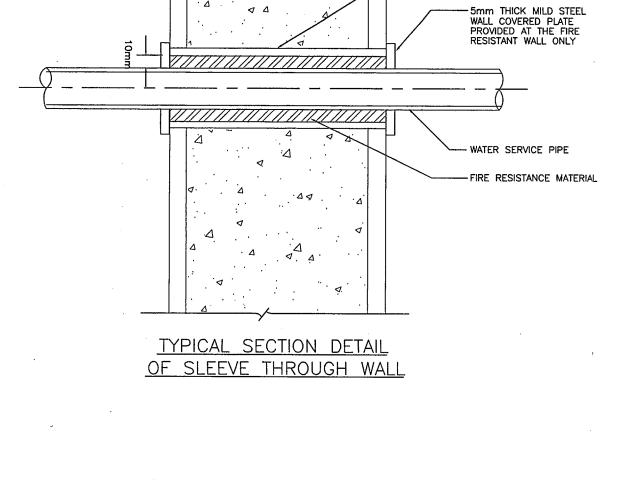


<u>T</u> A	BLE	OF	ANG	LE G	RATIN	1G S	SIZE	& OTHERS
	ıΑ	В	С	D	D1	Ε	F	REMARKS
	67	88	80	65	75	30	50	CONNECTED TO G.I.FITTING
	127	150	100	100	110.4	127	127	CONNECTED TO
	282	150	150	150	166.5	40	103	PVC PIPE FITTING

ANGLE GRATING RAINWATER OUTLET

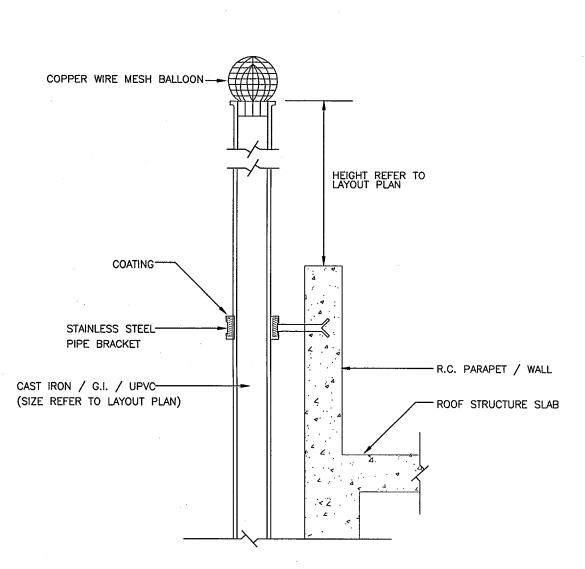

TYPICAL DETAIL FOR WALL-MOUNTED VENT PIPE

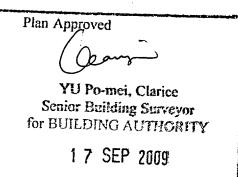

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PROJECT

NORTH KOWLOON MAGISTRACY NEW SCAD CAMPUS 292 TAI PO ROAD, KLN


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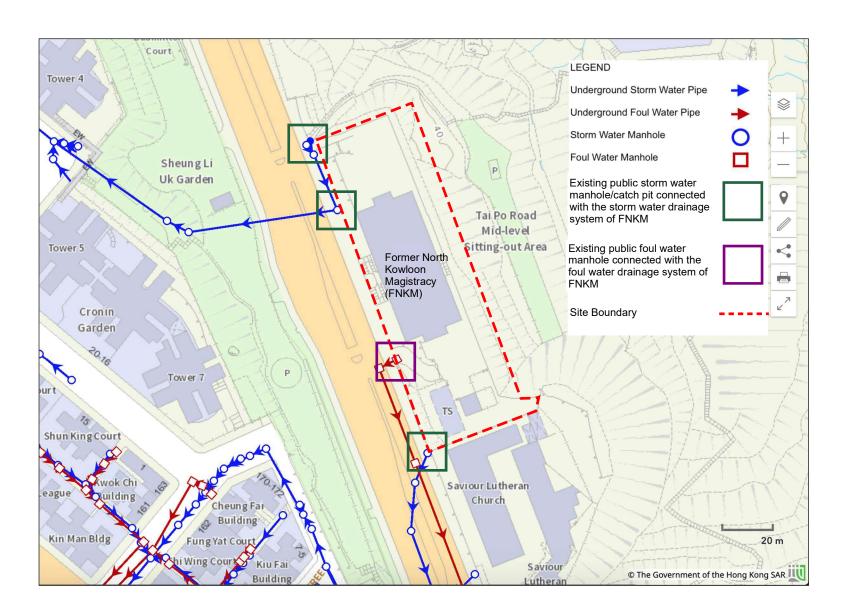
STANDARD DETAILS FOR DRAINAGE SYSTEM (I)

APPROVALS


THOMAS ANDERSON & PARTNERS CONSULTING ENGINEERS LTD.


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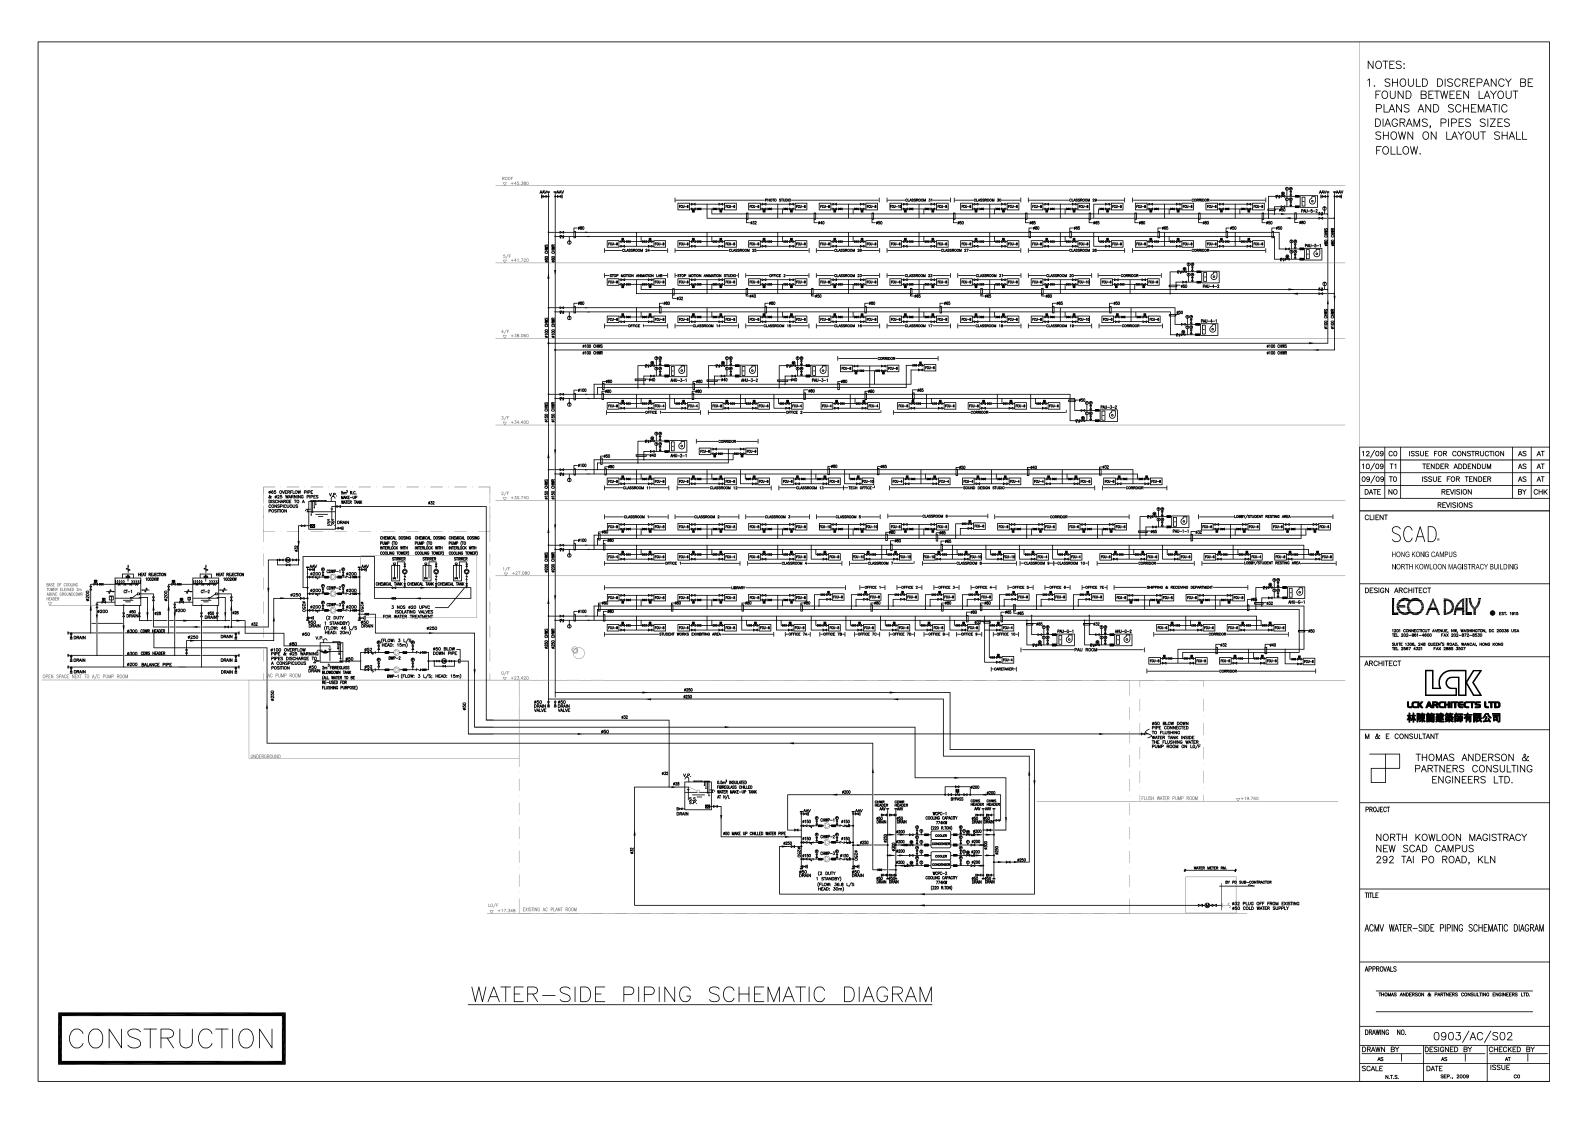


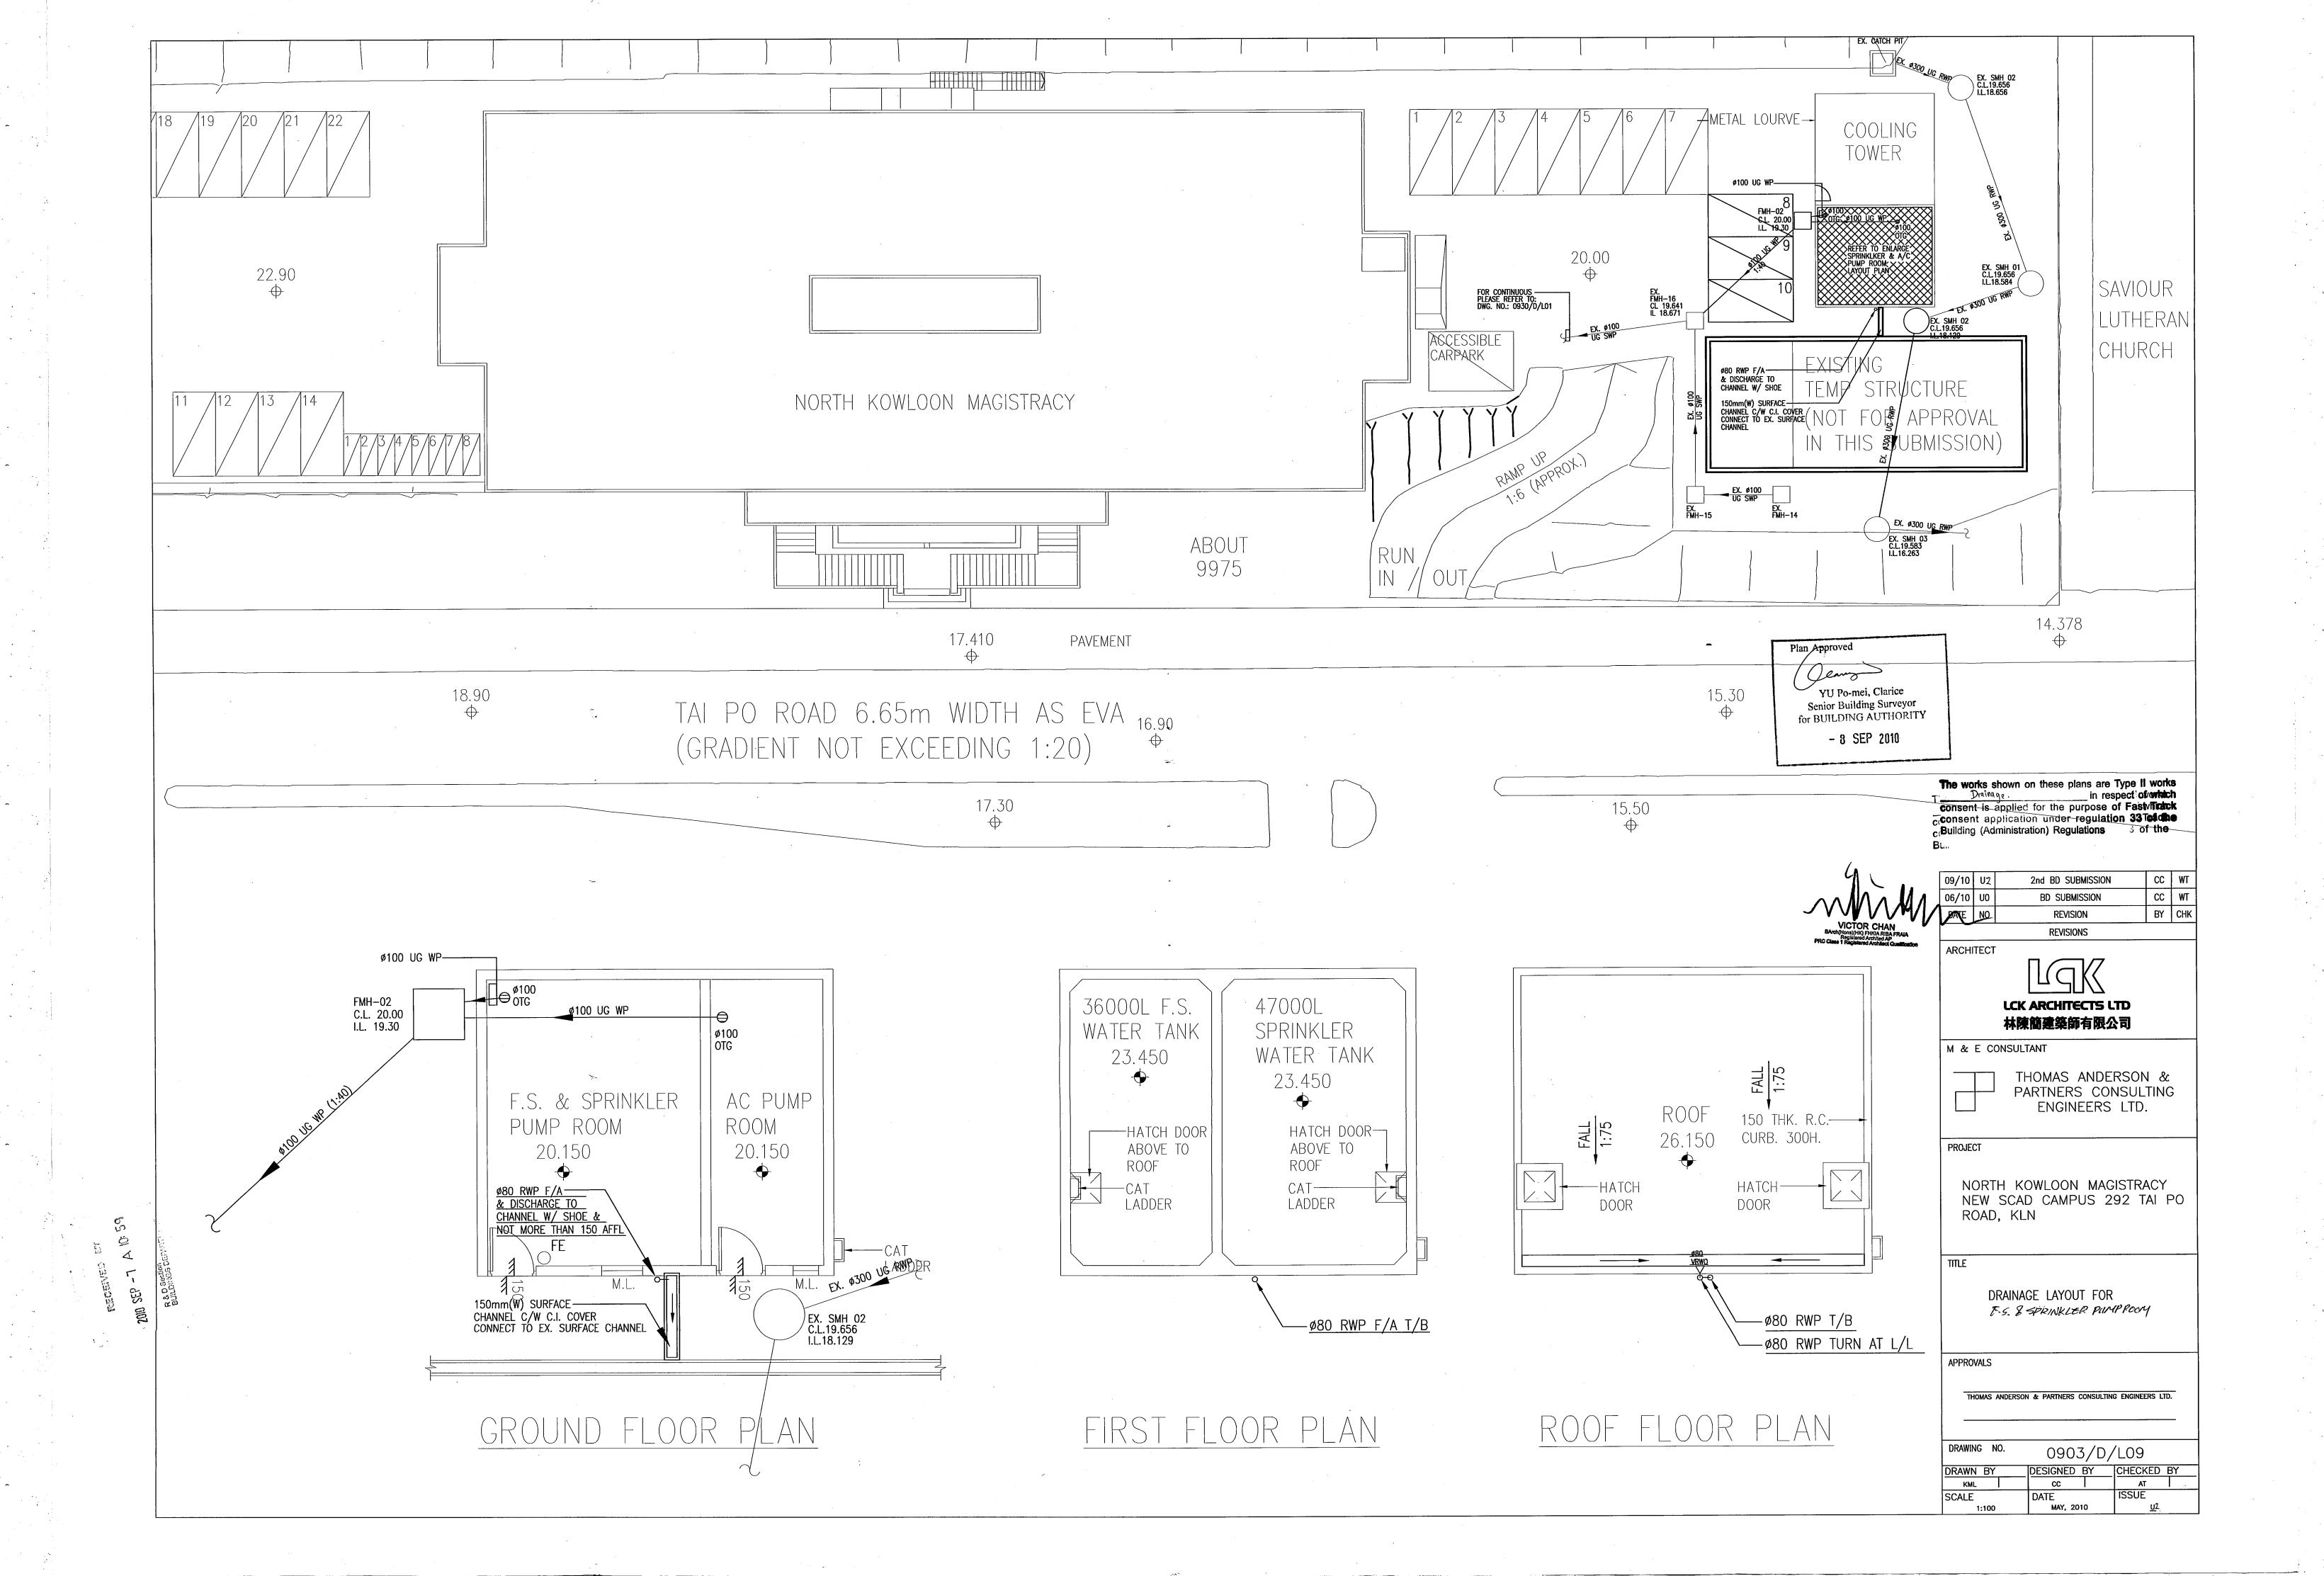

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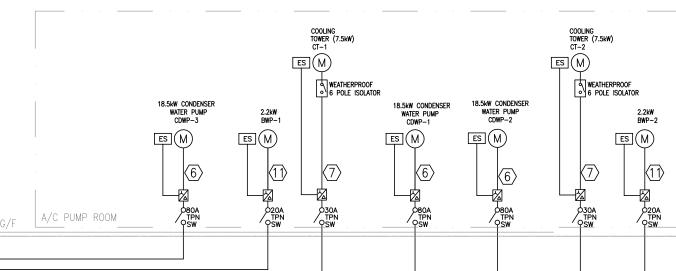





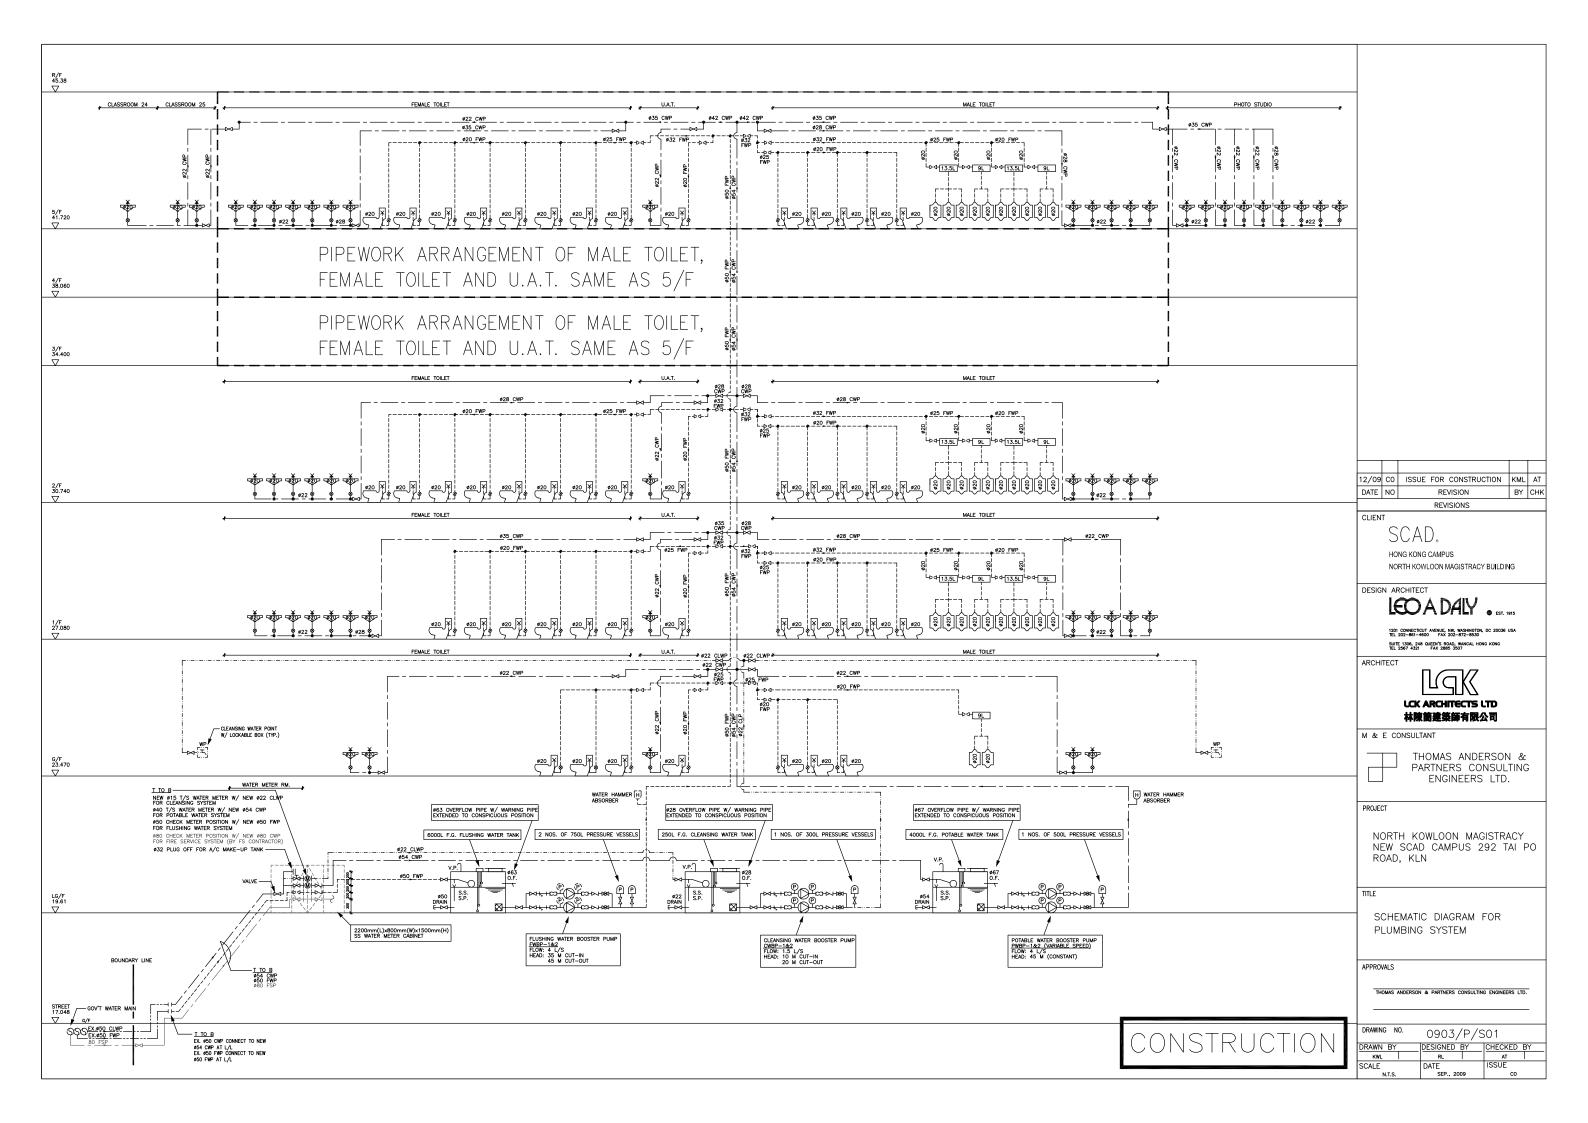

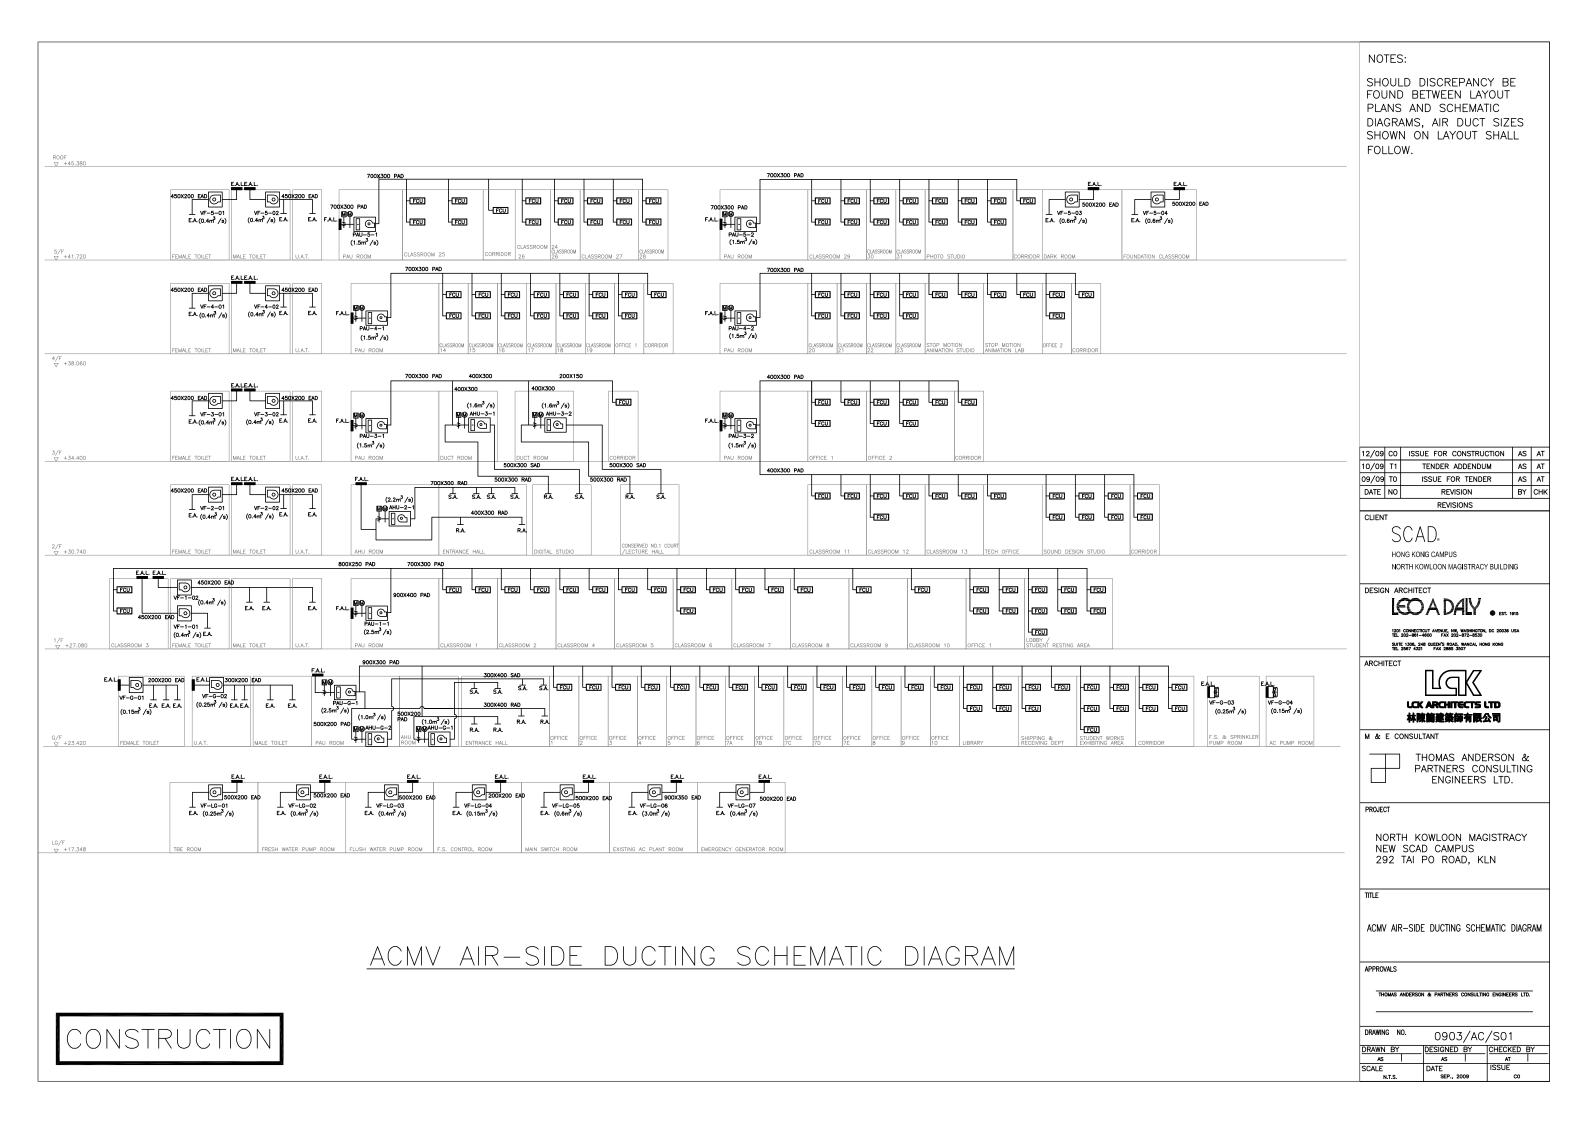CABLE SCHEDULE

CABLE NO.	CABLE SIZE	CABLE TYPE				
1	1 x 300 sq mm	4/C XLPE/SWA/PVCS Cu CABLE ON CABLE TRAY				
2	1 x 35 sq mm	4/C XLPE/SWA/PVCS Cu CABLE ON CABLE TRAY				
3	1 x 35 sq mm	4/C XLPE/SWA/PVCS Cu CABLE ON CABLE TRAY				
4	1 x 10 sq mm	4/C XLPE/SWA/PVCS Cu CABLE ON CABLE TRAY				
(5)	1 x 6 sq mm	4/C XLPE/SWA/PVCS Cu CABLE ON CABLE TRAY				
6	2 x 10 sq mm	3/C XLPE/SWA/PVCS Cu CABLE ON CABLE TRAY				
\bigcirc	2 x 6 sq mm	3/C XLPE/SWA/PVCS Cu CABLE ON CABLE TRAY				
8	2 x 16 sq mm	3/C XLPE/SWA/PVCS Cu CABLE ON CABLE TRAY				
9	1 x 16 sq mm	4/C XLPE/SWA/PVCS Cu CABLE ON CABLE TRAY				
(10)	1 x 150 sq mm	4/C XLPE/SWA/PVCS Cu CABLE ON CABLE TRAY				
(11)	2 x 4 sq mm	3/C XLPE/SWA/PVCS Cu CABLE ON CABLE TRAY				
(12)	1 x 25 sq mm	4/C XLPE/SWA/PVCS Cu CABLE ON CABLE TRAY				



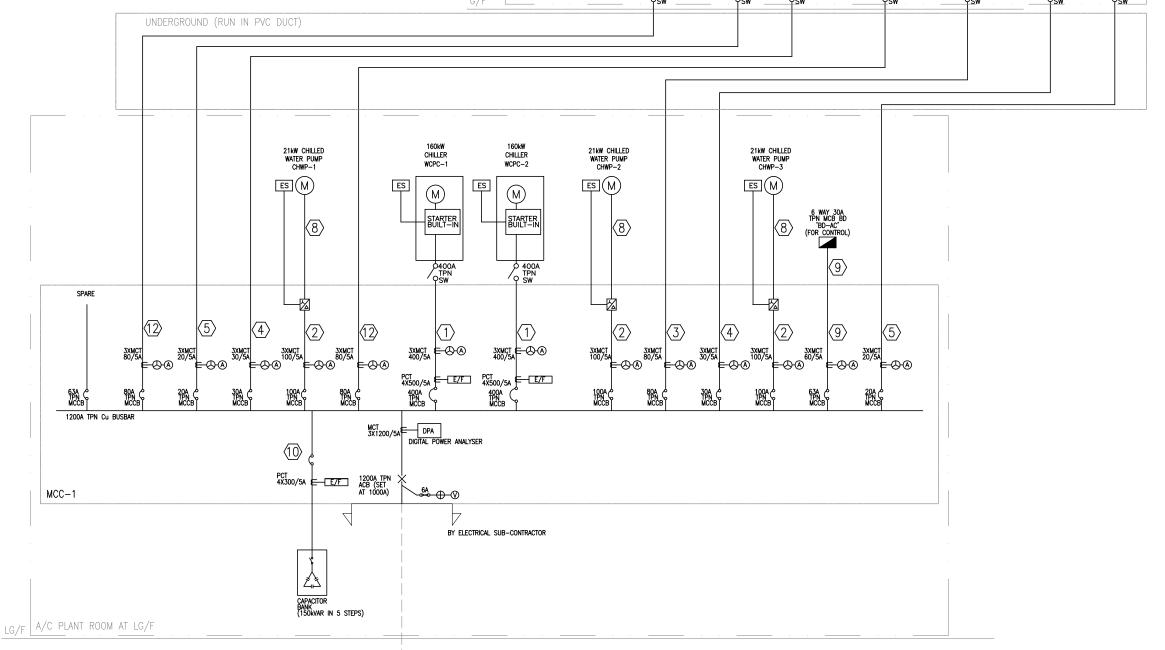

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HONG KONG CAMPUS NORTH KOWLOON MAGISTRACY BUILDING

DESIGN ARCHITECT

LEOADALY . EST. 1976

ARCHITECT



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THOMAS ANDERSON & PARTNERS CONSULTING ENGINEERS LTD.

PROJECT

NORTH KOWLOON MAGISTRACY NEW SCAD CAMPUS 292 TAI PO ROAD, KLN

POWER DISTRIBUTION SCHEMATIC DIAGRAM FOR MOTOR CONTROL CENTRE

APPROVALS

THOMAS ANDERSON & PARTNERS CONSULTING ENGINEERS LTD.

DRAWING NO.	0903/AC/S05			
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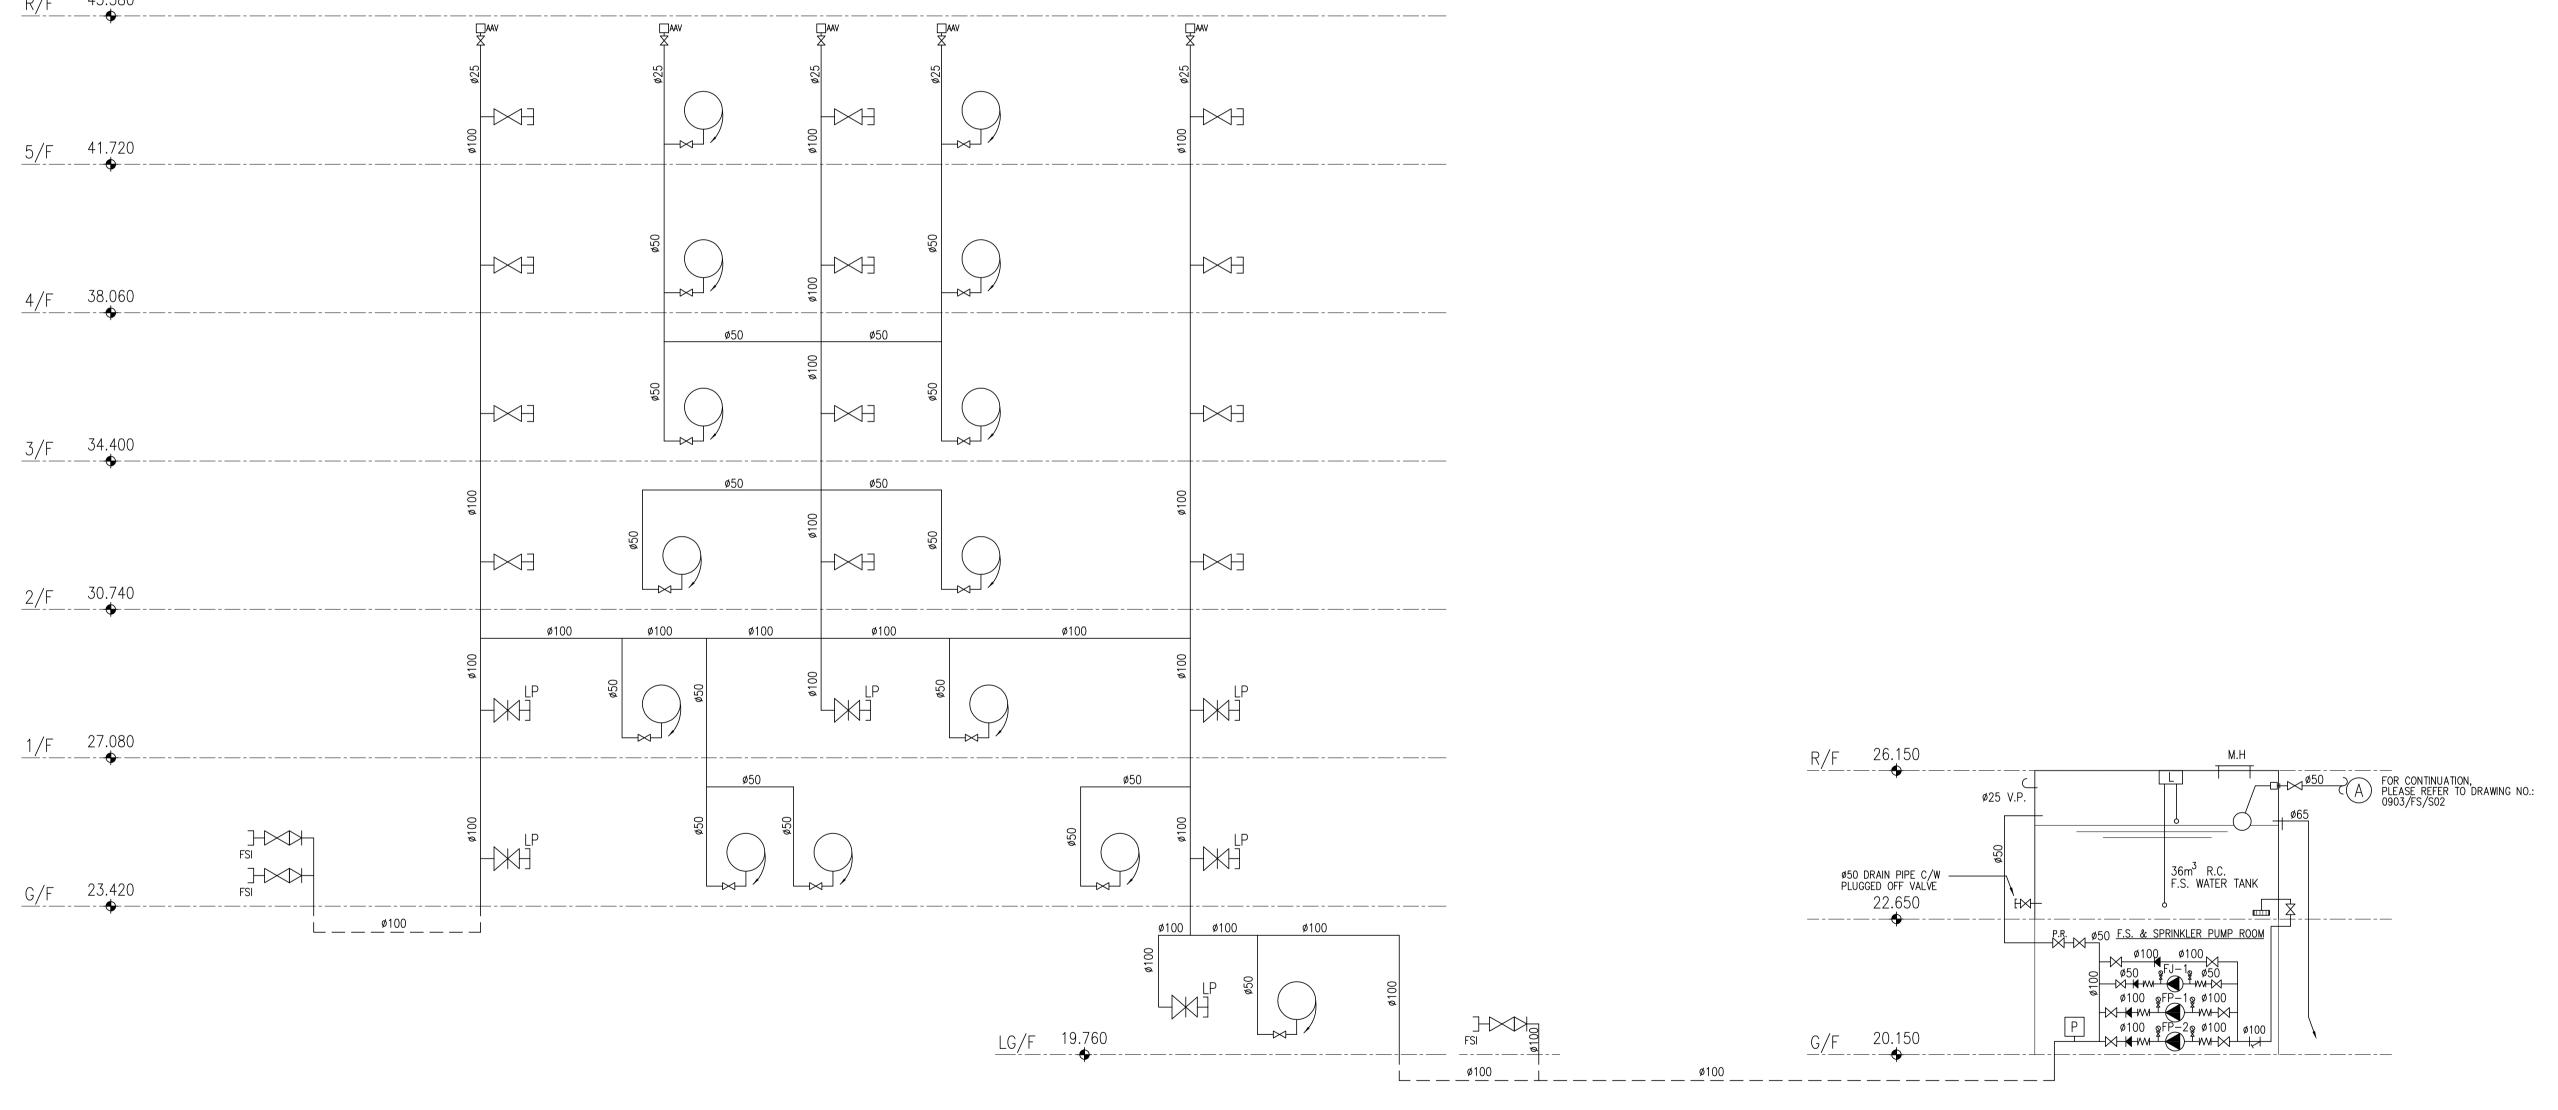
CONSTRUCTION

POWER DISTRIBUTION SCHEMATIC DIAGRAM FOR MOTOR CONTROL CENTRE

FROM LG/F MAIN SWITCH ROOM

PIPE SCHEDULE							
NOMINAL PIPE SIZE	SPECIFICATION						
ø150mm & BELOW, (ABOVE-GROUND PIPWORK)	G.I. PIPE TO BS EN 10255:2004 (BS 1387) MEDIUM GRADE						
ABOVE Ø150mm, (ABOVE-GROUND PIPWORK)	DUCTILE IRON PIPES AND FITTINGS TO BS EN545:2002, CLASS K12 COLD BITUMEN COATED EXTERNALLY AND INTERNALLY TO BS 3416:1991 TYPE II						
ø150mm & BELOW, (UNDERGROUND PIPEWORK OR WORKING PRESSURE >1600KPa)	G.I. PIPE TO BS EN 10255:2004 (BS 1387) HEAVY GRADE						
REMARK: ALL UNDERGROUND PIPE SHOULD BE TREATED AND COATED WITH AT LEAST TWO COATS OF BITUMINOUS PAINTS & WRAPPED WITH CORROSION AND WATER RESISTANCE SELF—AMALGAMATING TAPES AND MASTICS.							

PUMP SCHEDULE						
PUMP		PRESSURE (BAR)	FLOW (L/min)	TYPE		TOR RATING (KW)
FIXED FIRE PUMP	FP-1 FP-2	7.5	900	HORIZONAL END-SUCTION	2900	37
F.S. JOCKEY PUMP	FJ-1	8	60	VERTICAL MULTI-STAGE	2900	4
		KING PRESSURI AND OF MINIM		0% OF THE HIGHEST POSSI	BLE DISCHARG	E
·		•	•	·	•	



SCHEMATIC DIAGRAM FOR FIRE HYDRANT AND HOSE REEL SYSTEM

CONSTRUCTION

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HONG KONG CAMPUS
NORTH KOWLOON MAGISTRACY BUILDING

DESIGN ARCHITECT

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1201 CONNECTICUT AVENUE, NW, WASHINGTON, DC 20036 USA TEL 202-861-4600 FAX 202-872-8530 SUITE 1306, 248 QUEEN'S ROAD, WANCAI, HONG KONG TEL 2567 4321 FAX 2885 3507

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PROJECT

NORTH KOWLOON MAGISTRACY NEW SCAD CAMPUS 292 TAI PO ROAD, KLN

TITLE


SCHEMATIC DIAGRAM FOR FIRE HYDRANT & HOSE REEL SYSTEM

APPROVALS


THOMAS ANDERSON & PARTNERS CONSULTING ENGINEERS LTD.

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PUMP SCHEDULE							
PUMP		PRESSURE	FLOW	TYPE	MO ⁻	TOR	
PUMP		(BAR)	(L/min)	IIPE	SPEED (RPM)	RATING	(KV
SPRINKLER PUMP	SP-1 SP-2	1.9/4.2/4.5	1150/540/375	HORIZONTAL END-SUCTION	2900	15	
SPRINKLER JOCKEY PUMP	SJ-1	5.0	45	VERTICAL MULTI-STAGE	2900	2.2	
REMARKS: PUMP CASING WORKING PRESSURE SHALL BE 150% OF THE HIGHEST POSSIBLE DISCHARGE SYSTEM PRESSURE AND OF MINIMUM 16 BARS.							

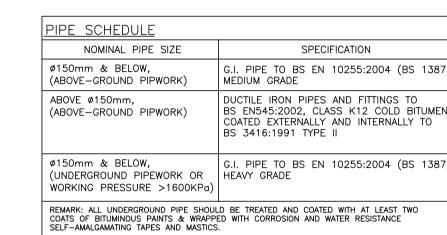

SCHEMATIC DIAGRAM FOR SPRINKLER SYSTEM

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PROJECT

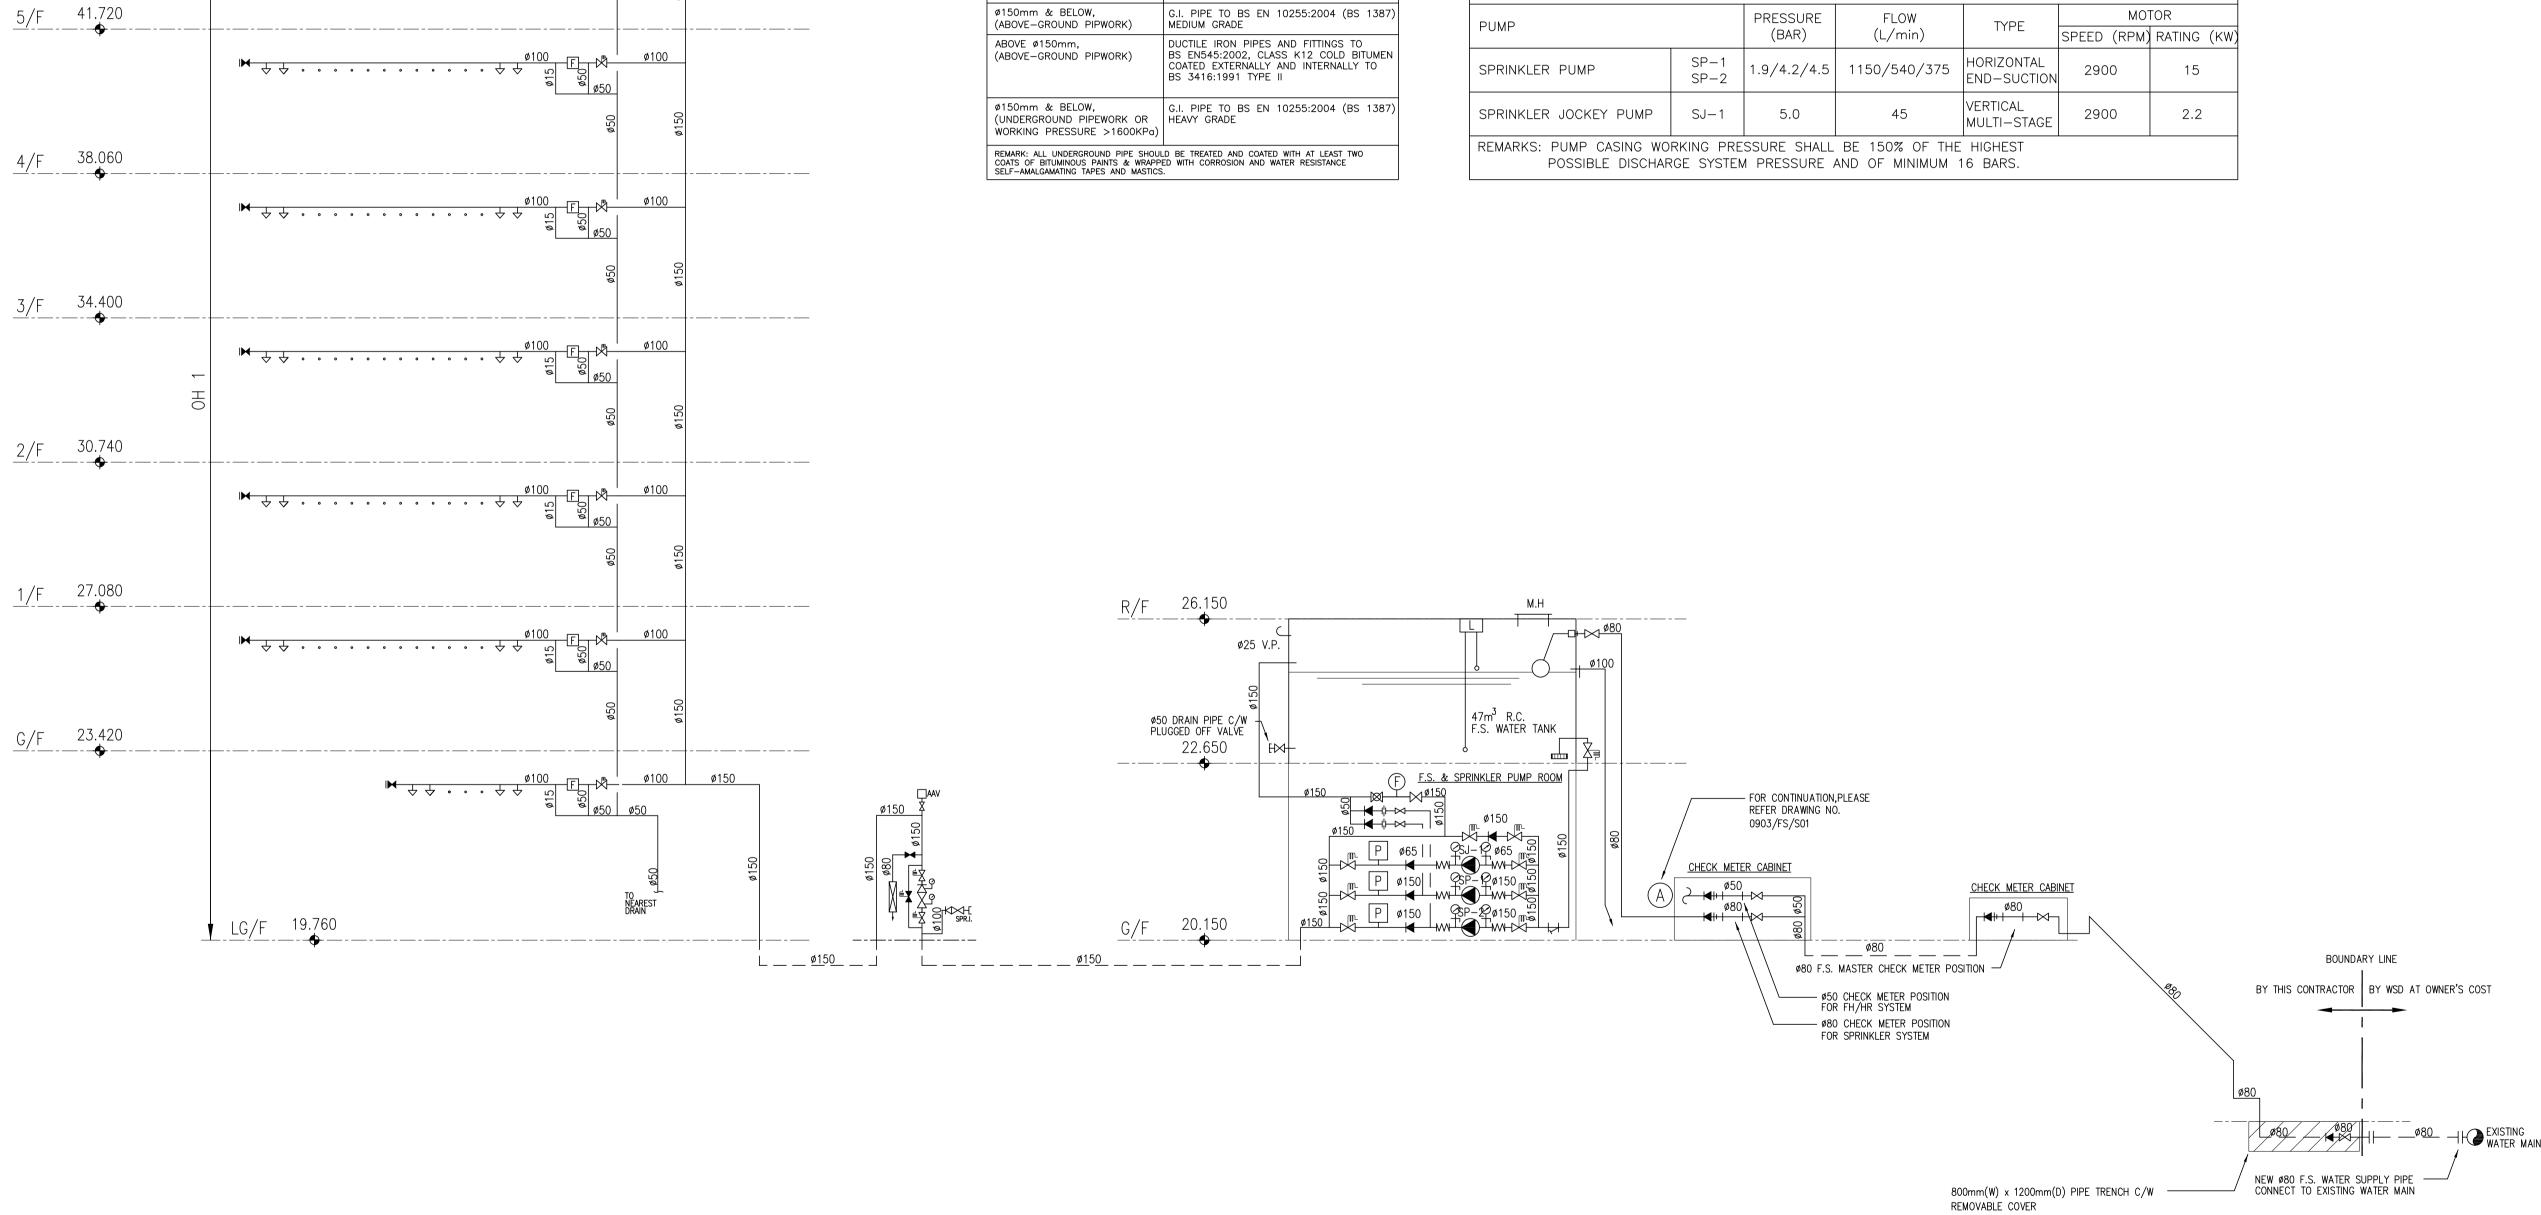NORTH KOWLOON MAGISTRACY NEW SCAD CAMPUS 292 TAI PO ROAD, KLN

TITLE

SCHEMATIC DIAGRAM FOR SPRINKLER SYSTEM


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THOMAS ANDERSON & PARTNERS CONSULTING ENGINEERS LTD.

0903/FS/S02

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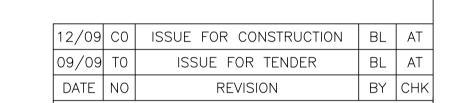
LE	LED/LCD DISPLAY POINT SCHEDULE FOR MFAP (ADDRESSABLE TYPE)																						
	BREAKGLASS FIRE FLOW SUBSIDIARY VALVE FIRE PUMP (SP/SJ) SPRINKLER PUMP (SP/SJ) SPRINKLER / F.S. WATER TANK													EMER(GENE	GENCY RATOR								
FC	ZONE DR POINT	ONE FOR DETE	EACH		ZONE EACH TCH		ZONE EACH _VE		ONE ZONE ONE ZONE FOR EACH PUMP FOR EACH PUMP EACH TAI)R		FOR	ZONE EACH RATOR							
FIRE	FAULT	FIRE	FAULT	FIRE	FAULT	CLOSE	OPEN	POWER SUPPLY ON	POWER SUPPLY FAILURE	PUMP FAILED	PUMP RUNNING	POWER SUPPLY ON		VER SUF FAILURE TI VIER SUF		PUMP FAILED	PUMP RUNNING	OVERFLOW ALARM	EMPTY ALARM	POWER SUPPLY FAILURE	GENERATOR FAILED	GENERATOR RUNNING	MCB FAULT



SCHEMATIC DIAGRAM FOR MANUAL AND AUTOMATIC FIRE ALARM SYSTEM
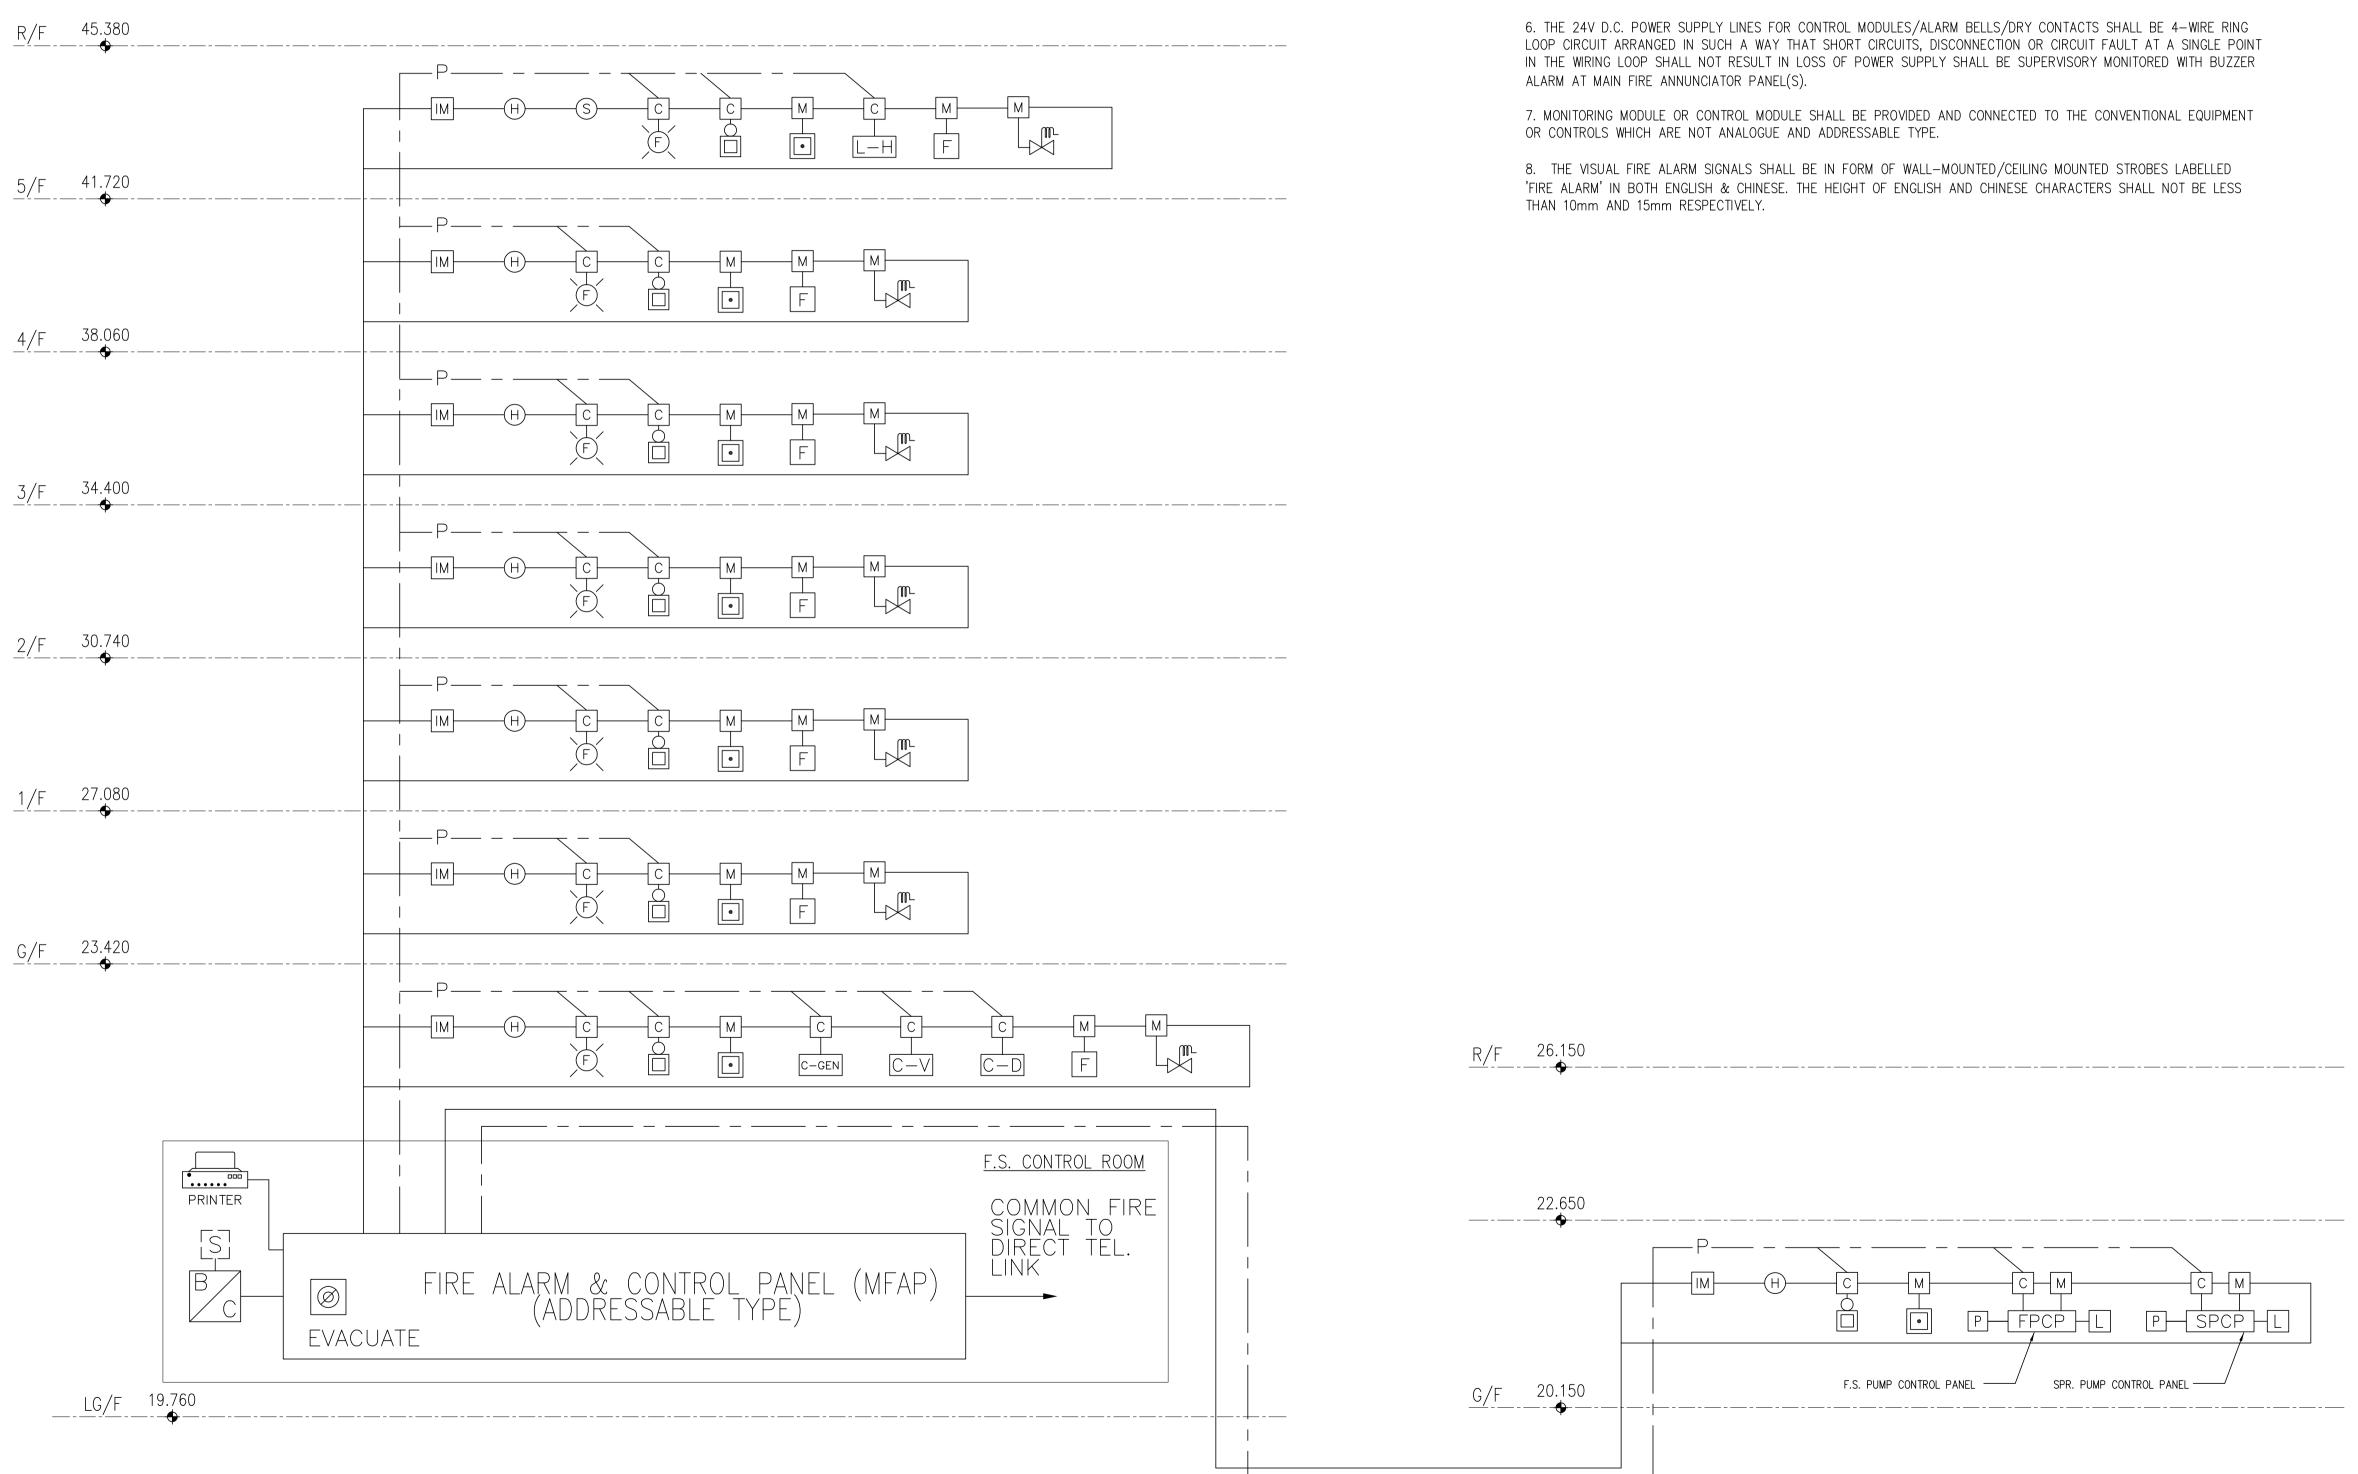
<u>NOTES</u>

- 1. THE SYSTEM SHALL BE MICROPROCESSOR BASED ANALOGUE AND ADDRESSABLE TYPE FIRE DETECTION AND ALARM SYSTEM. THIS SCHEMATIC SHOWS CONCEPTUAL DESIGEN. THE DETAILLED LAYOUT AND WIRING DESIGN SHALL BE PROVIDED BY THIS CONTRACTOR ACCORDING TO MANUFACTURES'S DESIGN AND INSTALLATION MANUAL.
- 2. ALL SYSTEM COMMUNICATION CABLE WIRING AND 24V D.C. POWER LINES SHALL BE LSHF & FIRE RESISTANT GRADE. ie TO BS6387 CAT CWZ
- 3. FAULT ISOLATOR MODULES SHALL BE PLACED EVERY 25 SENSING DEVICES TO LIMIT THE NUMBER LOST IN THE EVENT OF A SHORT CIRCUIT.
- 4. FOR EXACT NUMBERS OF EQUIPMENT INCLUDING BREAKGLASS UNIT AND ALARM BELLS. REFER TO INSTALLATION LAYOUT PLANS.
- 5. ALL ADDRESSABLE LOOPS SHALL BE BASED ON 4-WIRE CLOSE LOOP CONFIGURATION.



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HONG KONG CAMPUS
NORTH KOWLOON MAGISTRACY BUILDING

REVISIONS

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THOMAS ANDERSON & PARTNERS CONSULTING ENGINEERS LTD.

PROJECT

NORTH KOWLOON MAGISTRACY NEW SCAD CAMPUS 292 TAI PO ROAD, KLN

TITLE

SCHEMATIC DIAGRAM FOR MANUAL & AUTOMATIC FIRE ALARM SYSTEM

APPROVALS

THOMAS ANDERSON & PARTNERS CONSULTING ENGINEERS LTD.

DRAWING NO. 0903/FS/S03

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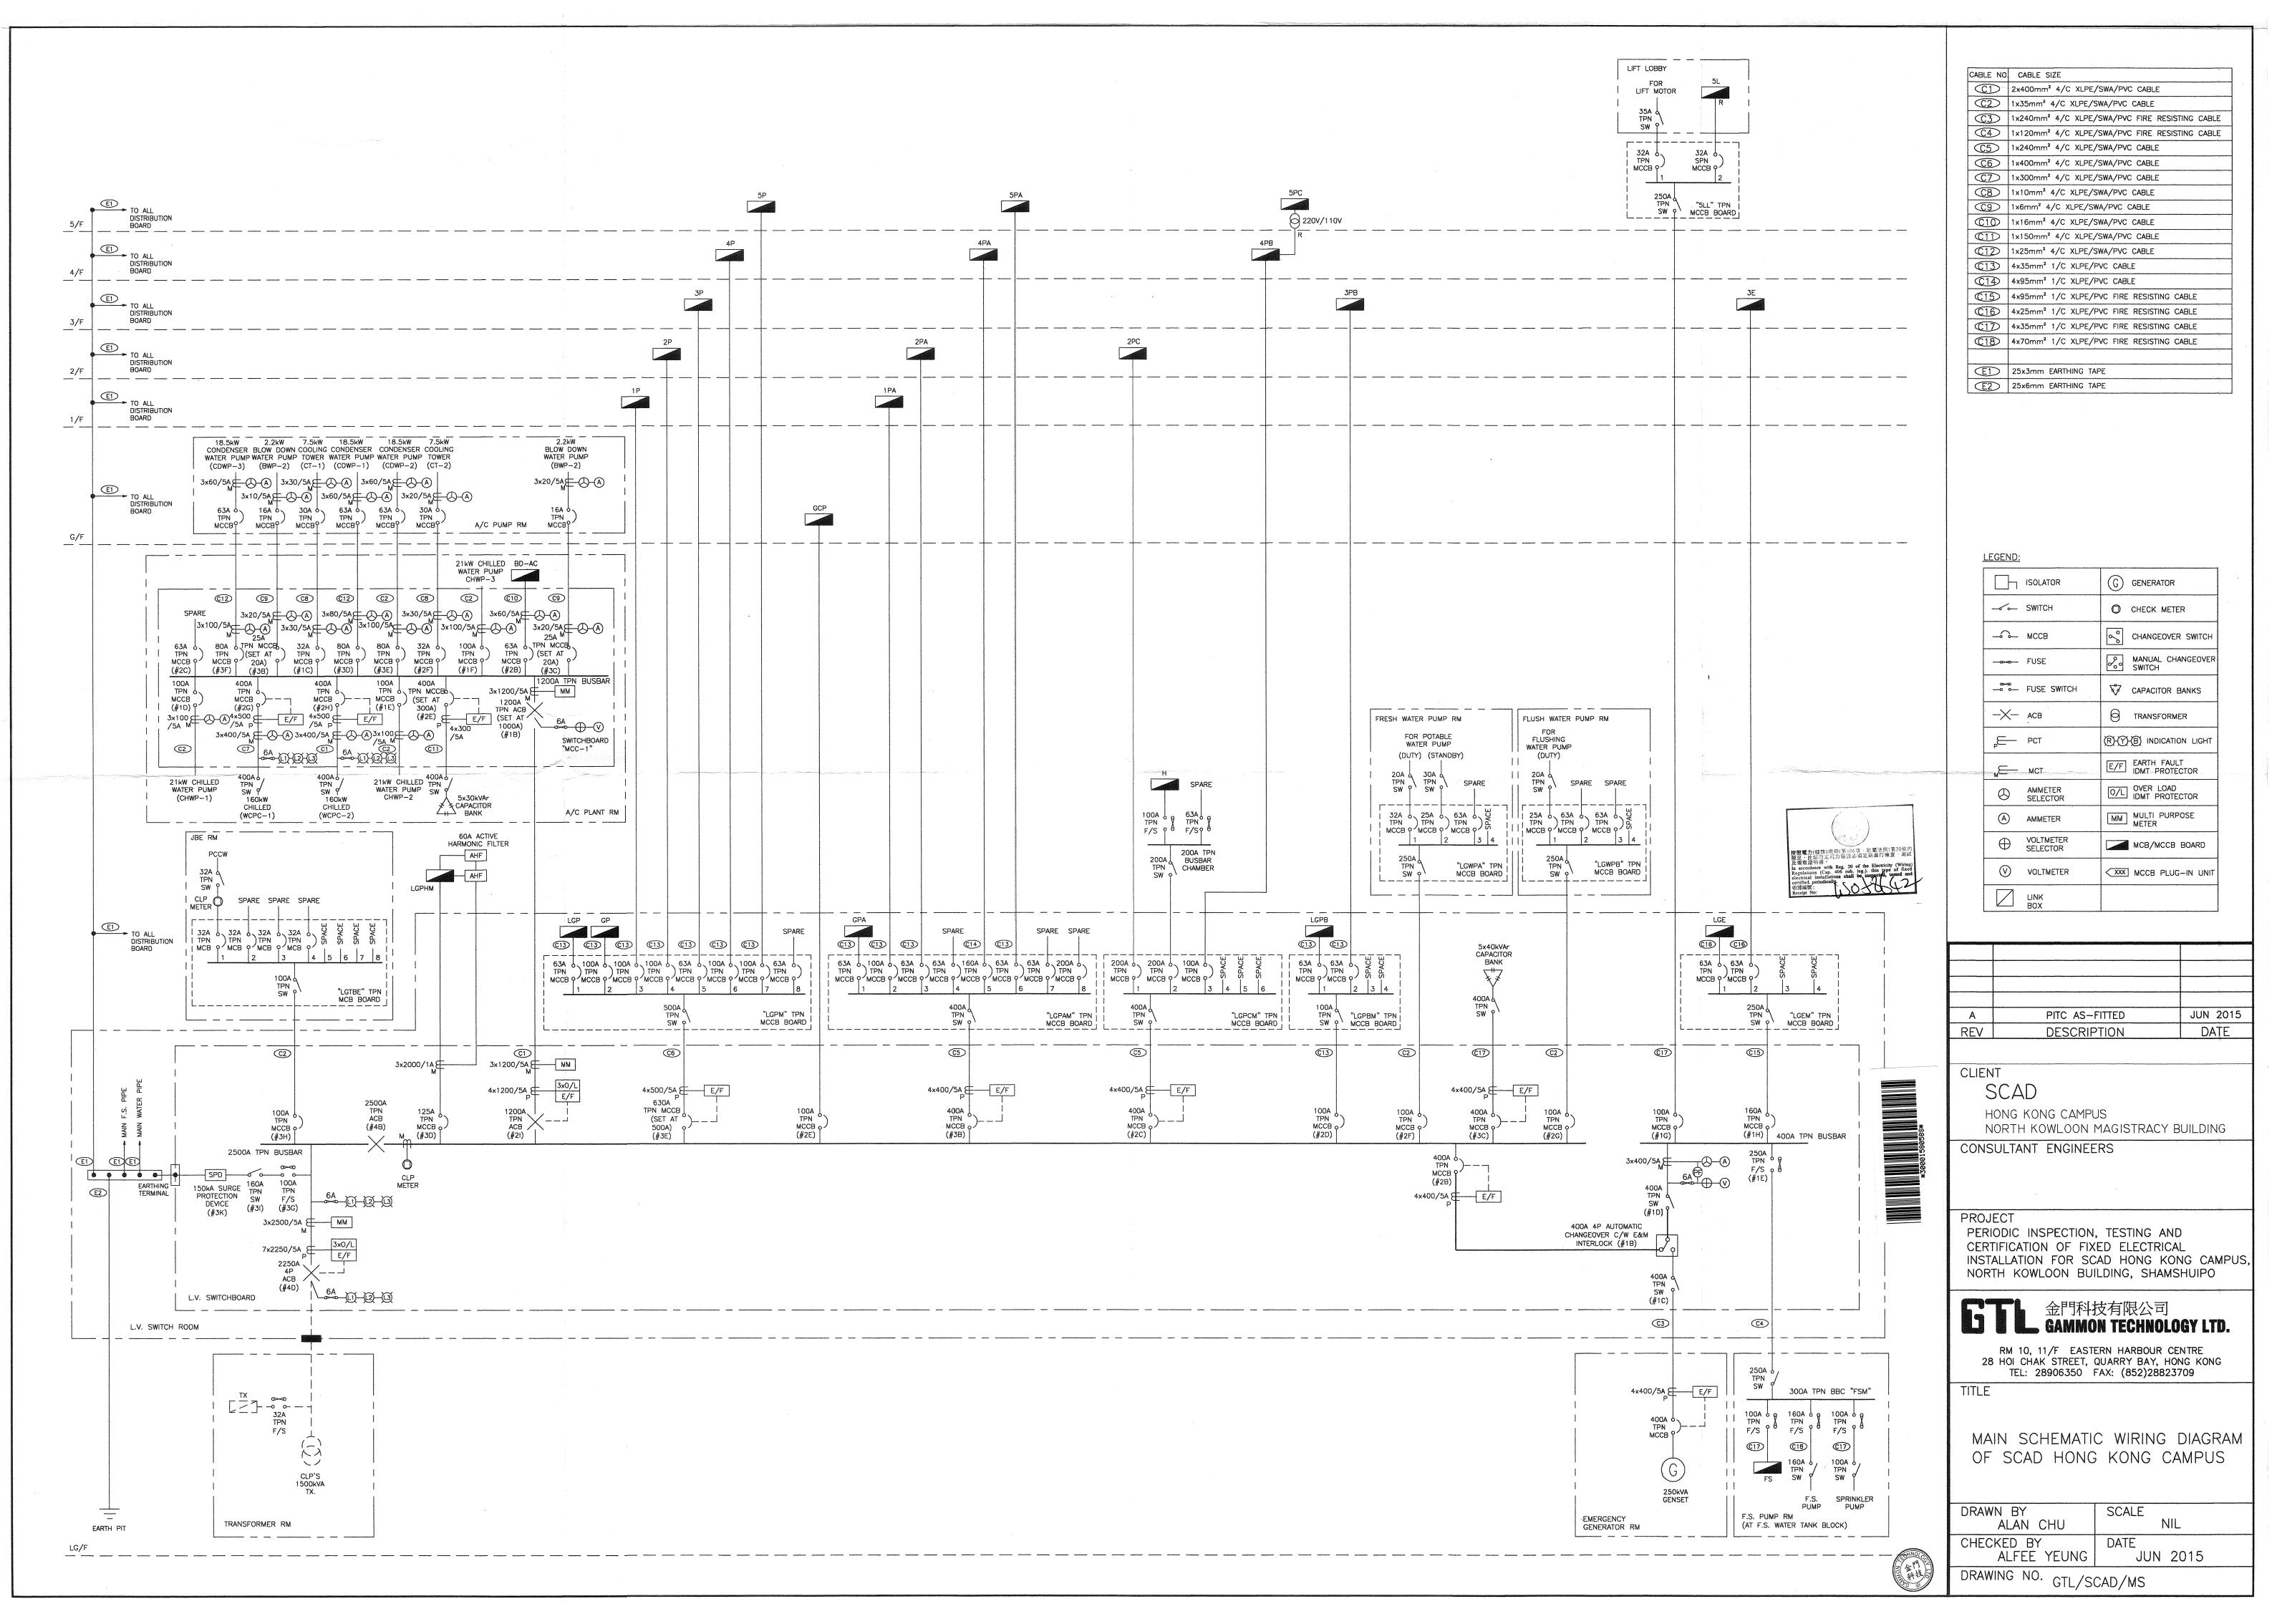
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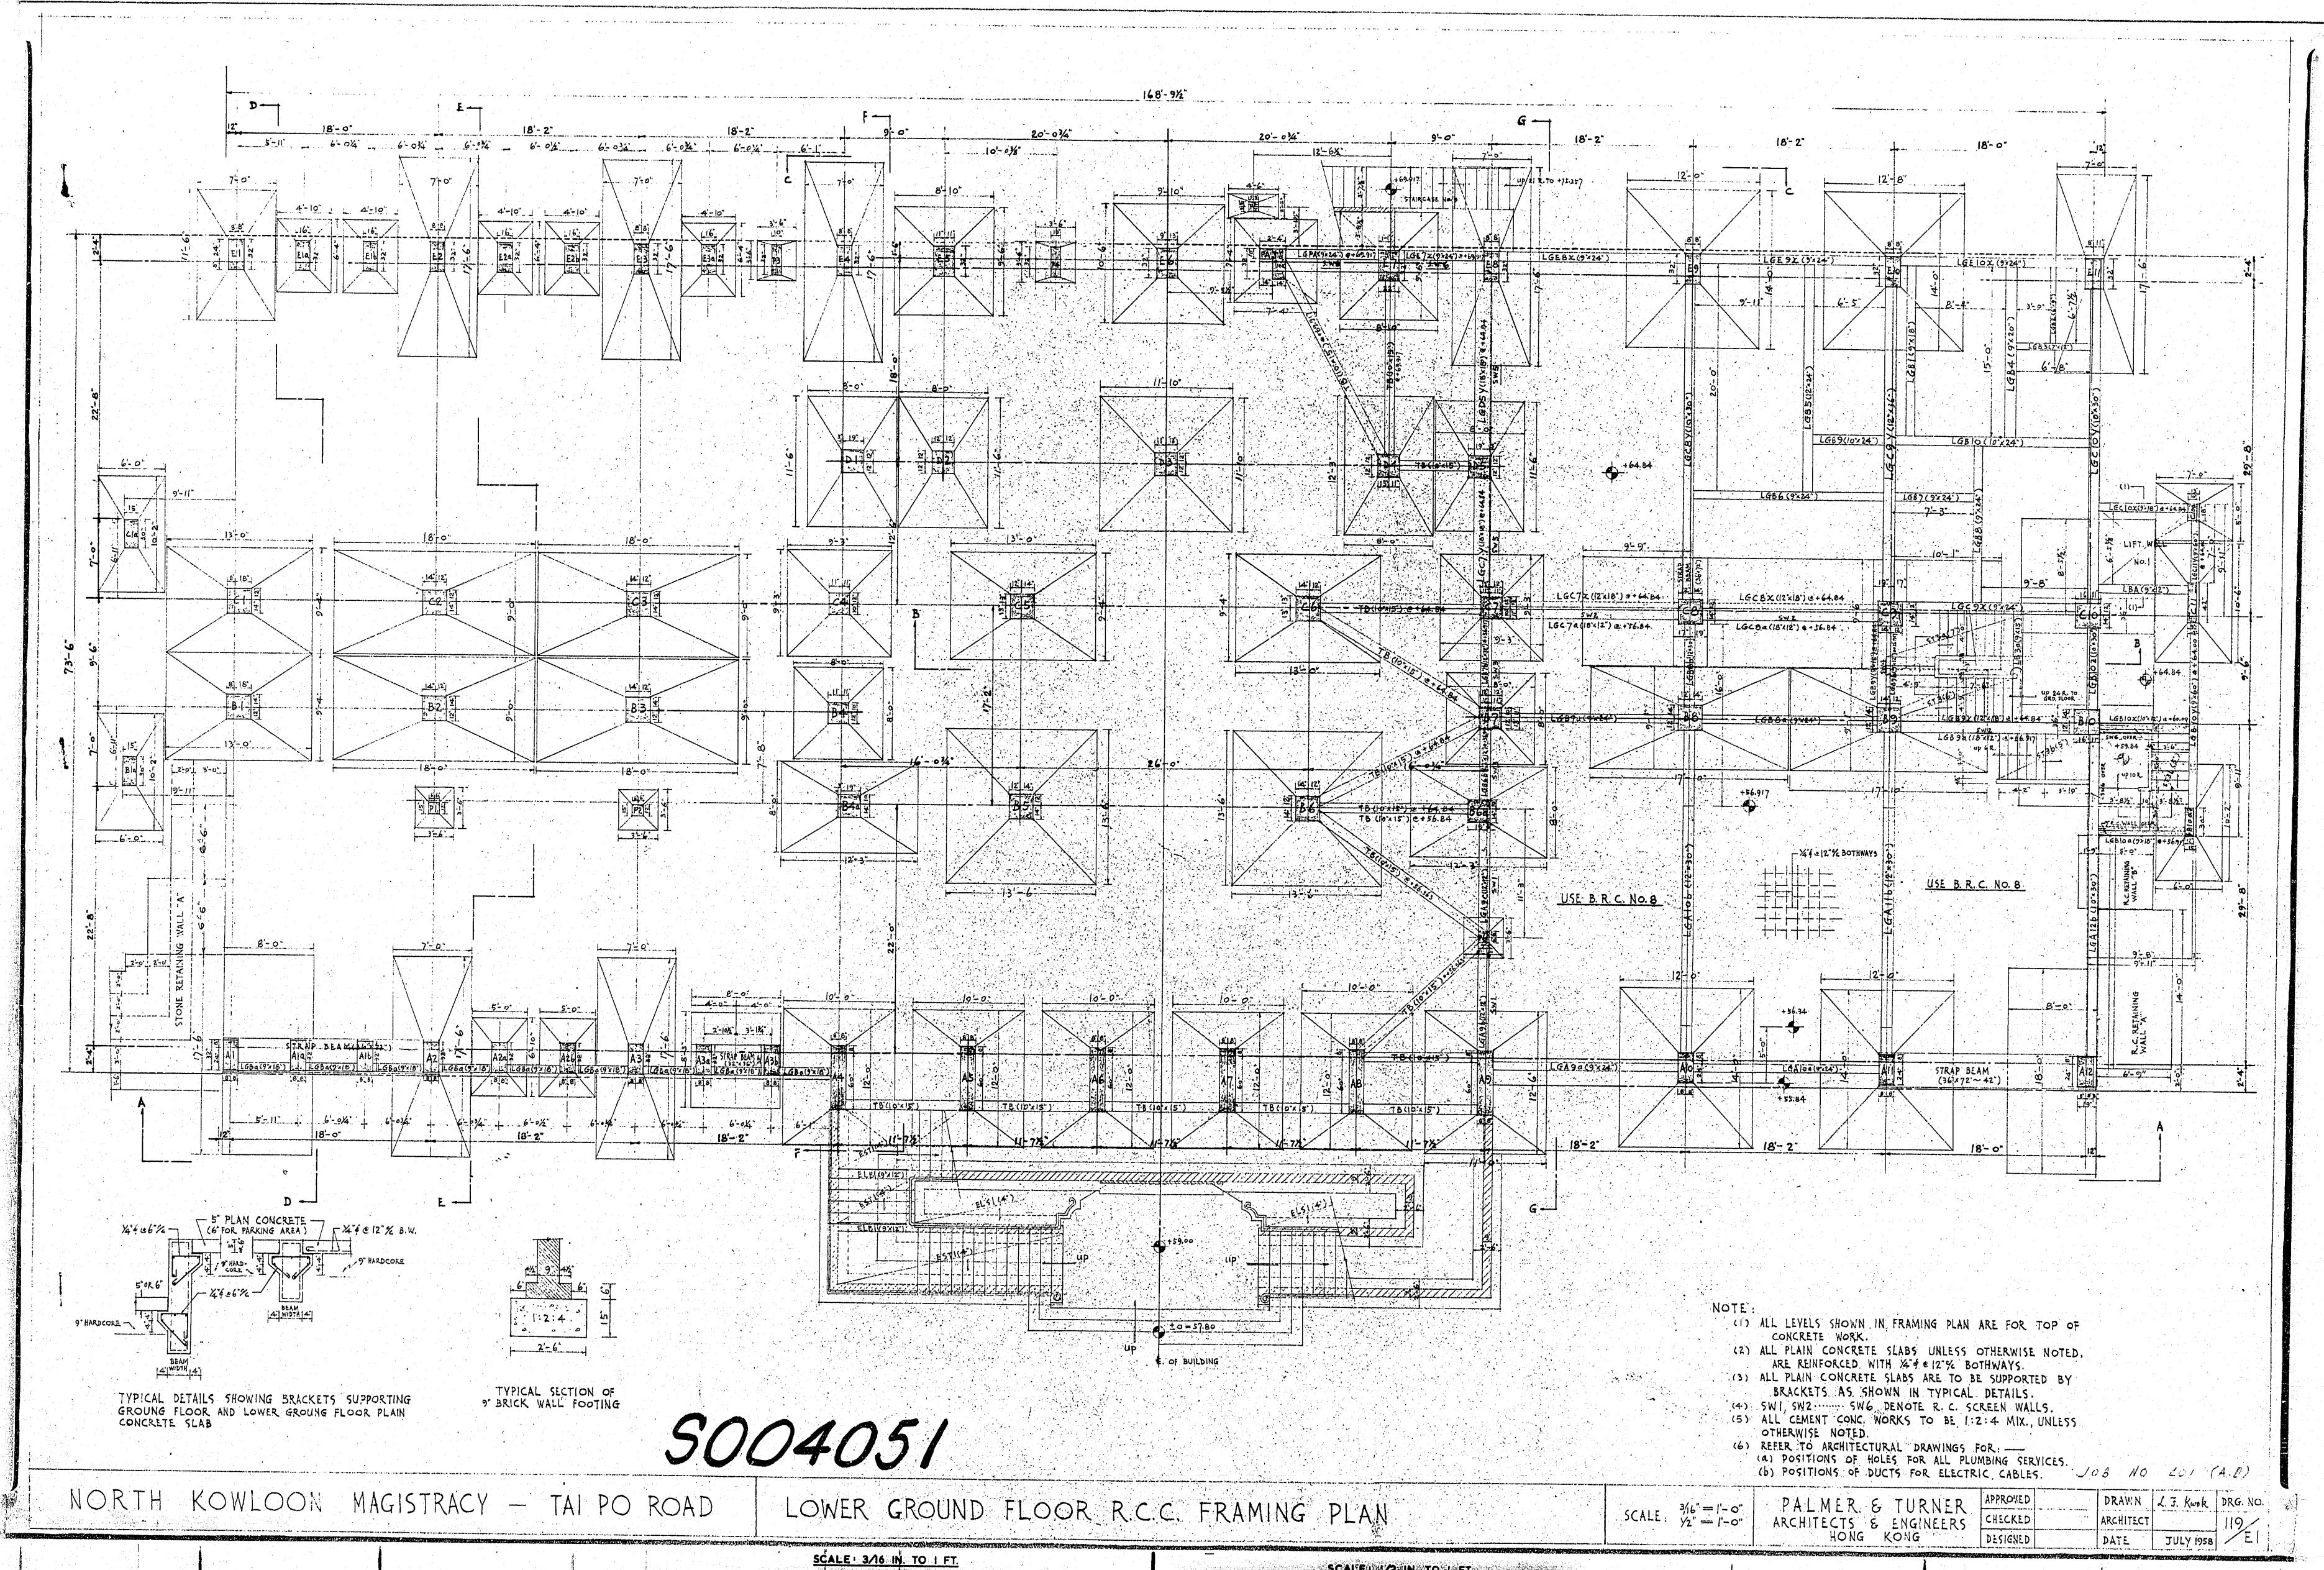


Appendix VI(C)

Structural Record Drawings

Appendix VI(C) – Structural Record Drawings <u>Drawing List</u>

	Drawing No.	Drawing Title
Frami	ng Plans	
1.	S004051	Framing Plan for LG/F
2.	S004052	Framing Plan for G/F
3.	S004053	Framing Plan for 1/F
4.	S004054	Framing Plan for 2/F
5.	S004055	Framing Plan for 3/F
6.	S004056	Framing Plan for 4/F
7.	S004057	Framing Plan for 5/F
8.	S004057A	Framing Plan for Roof
9.	0907/AFR/01	A&A Framing Plan for LG/F
10.	0907/AFR/02	A&A Framing Plan for G/F
11.	0907/AFR/03	A&A Framing Plan for 1/F
12.	0907/AFR/04	A&A Framing Plan for 2/F
13.	0907/AFR/05	A&A Framing Plan for 3/F
14.	0907/AFR/06	A&A Framing Plan for 4/F
15.	0907/AFR/07	A&A Framing Plan for 5/F
16.	0907/AFR/08	A&A Framing Plan for Roof




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FT. 1 O 2 4 6 8 10 12 14 16 18 FT.

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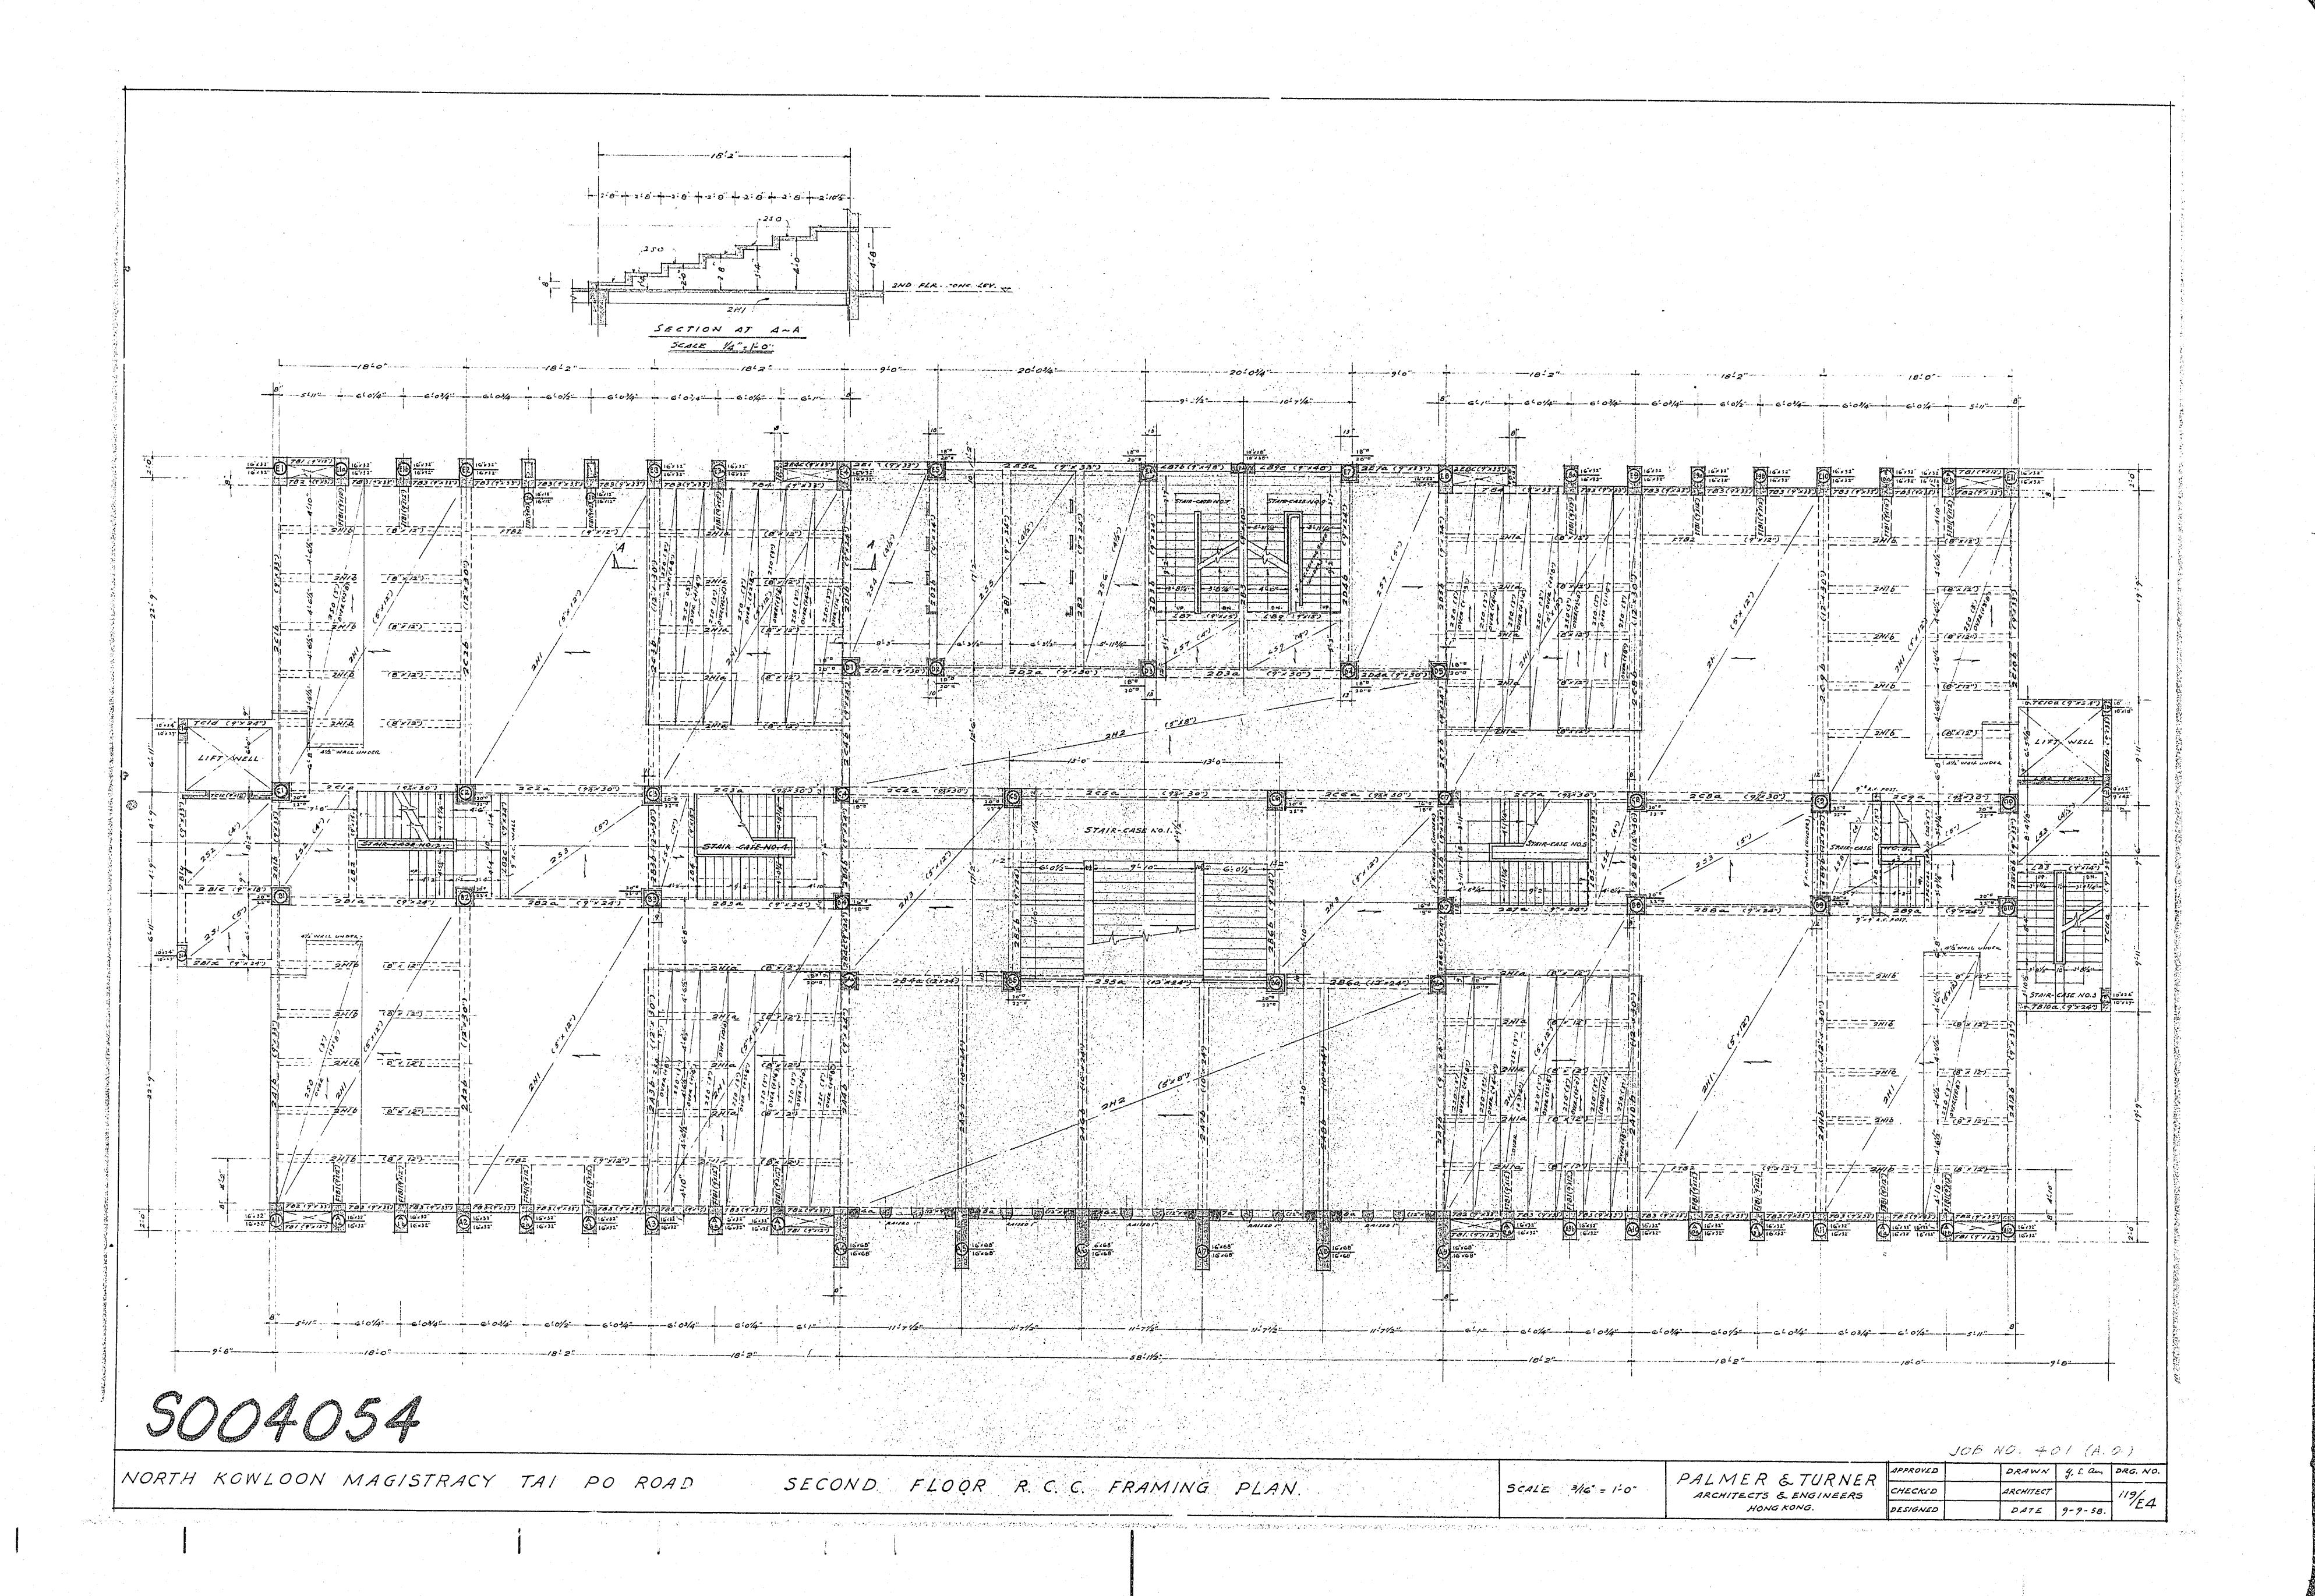
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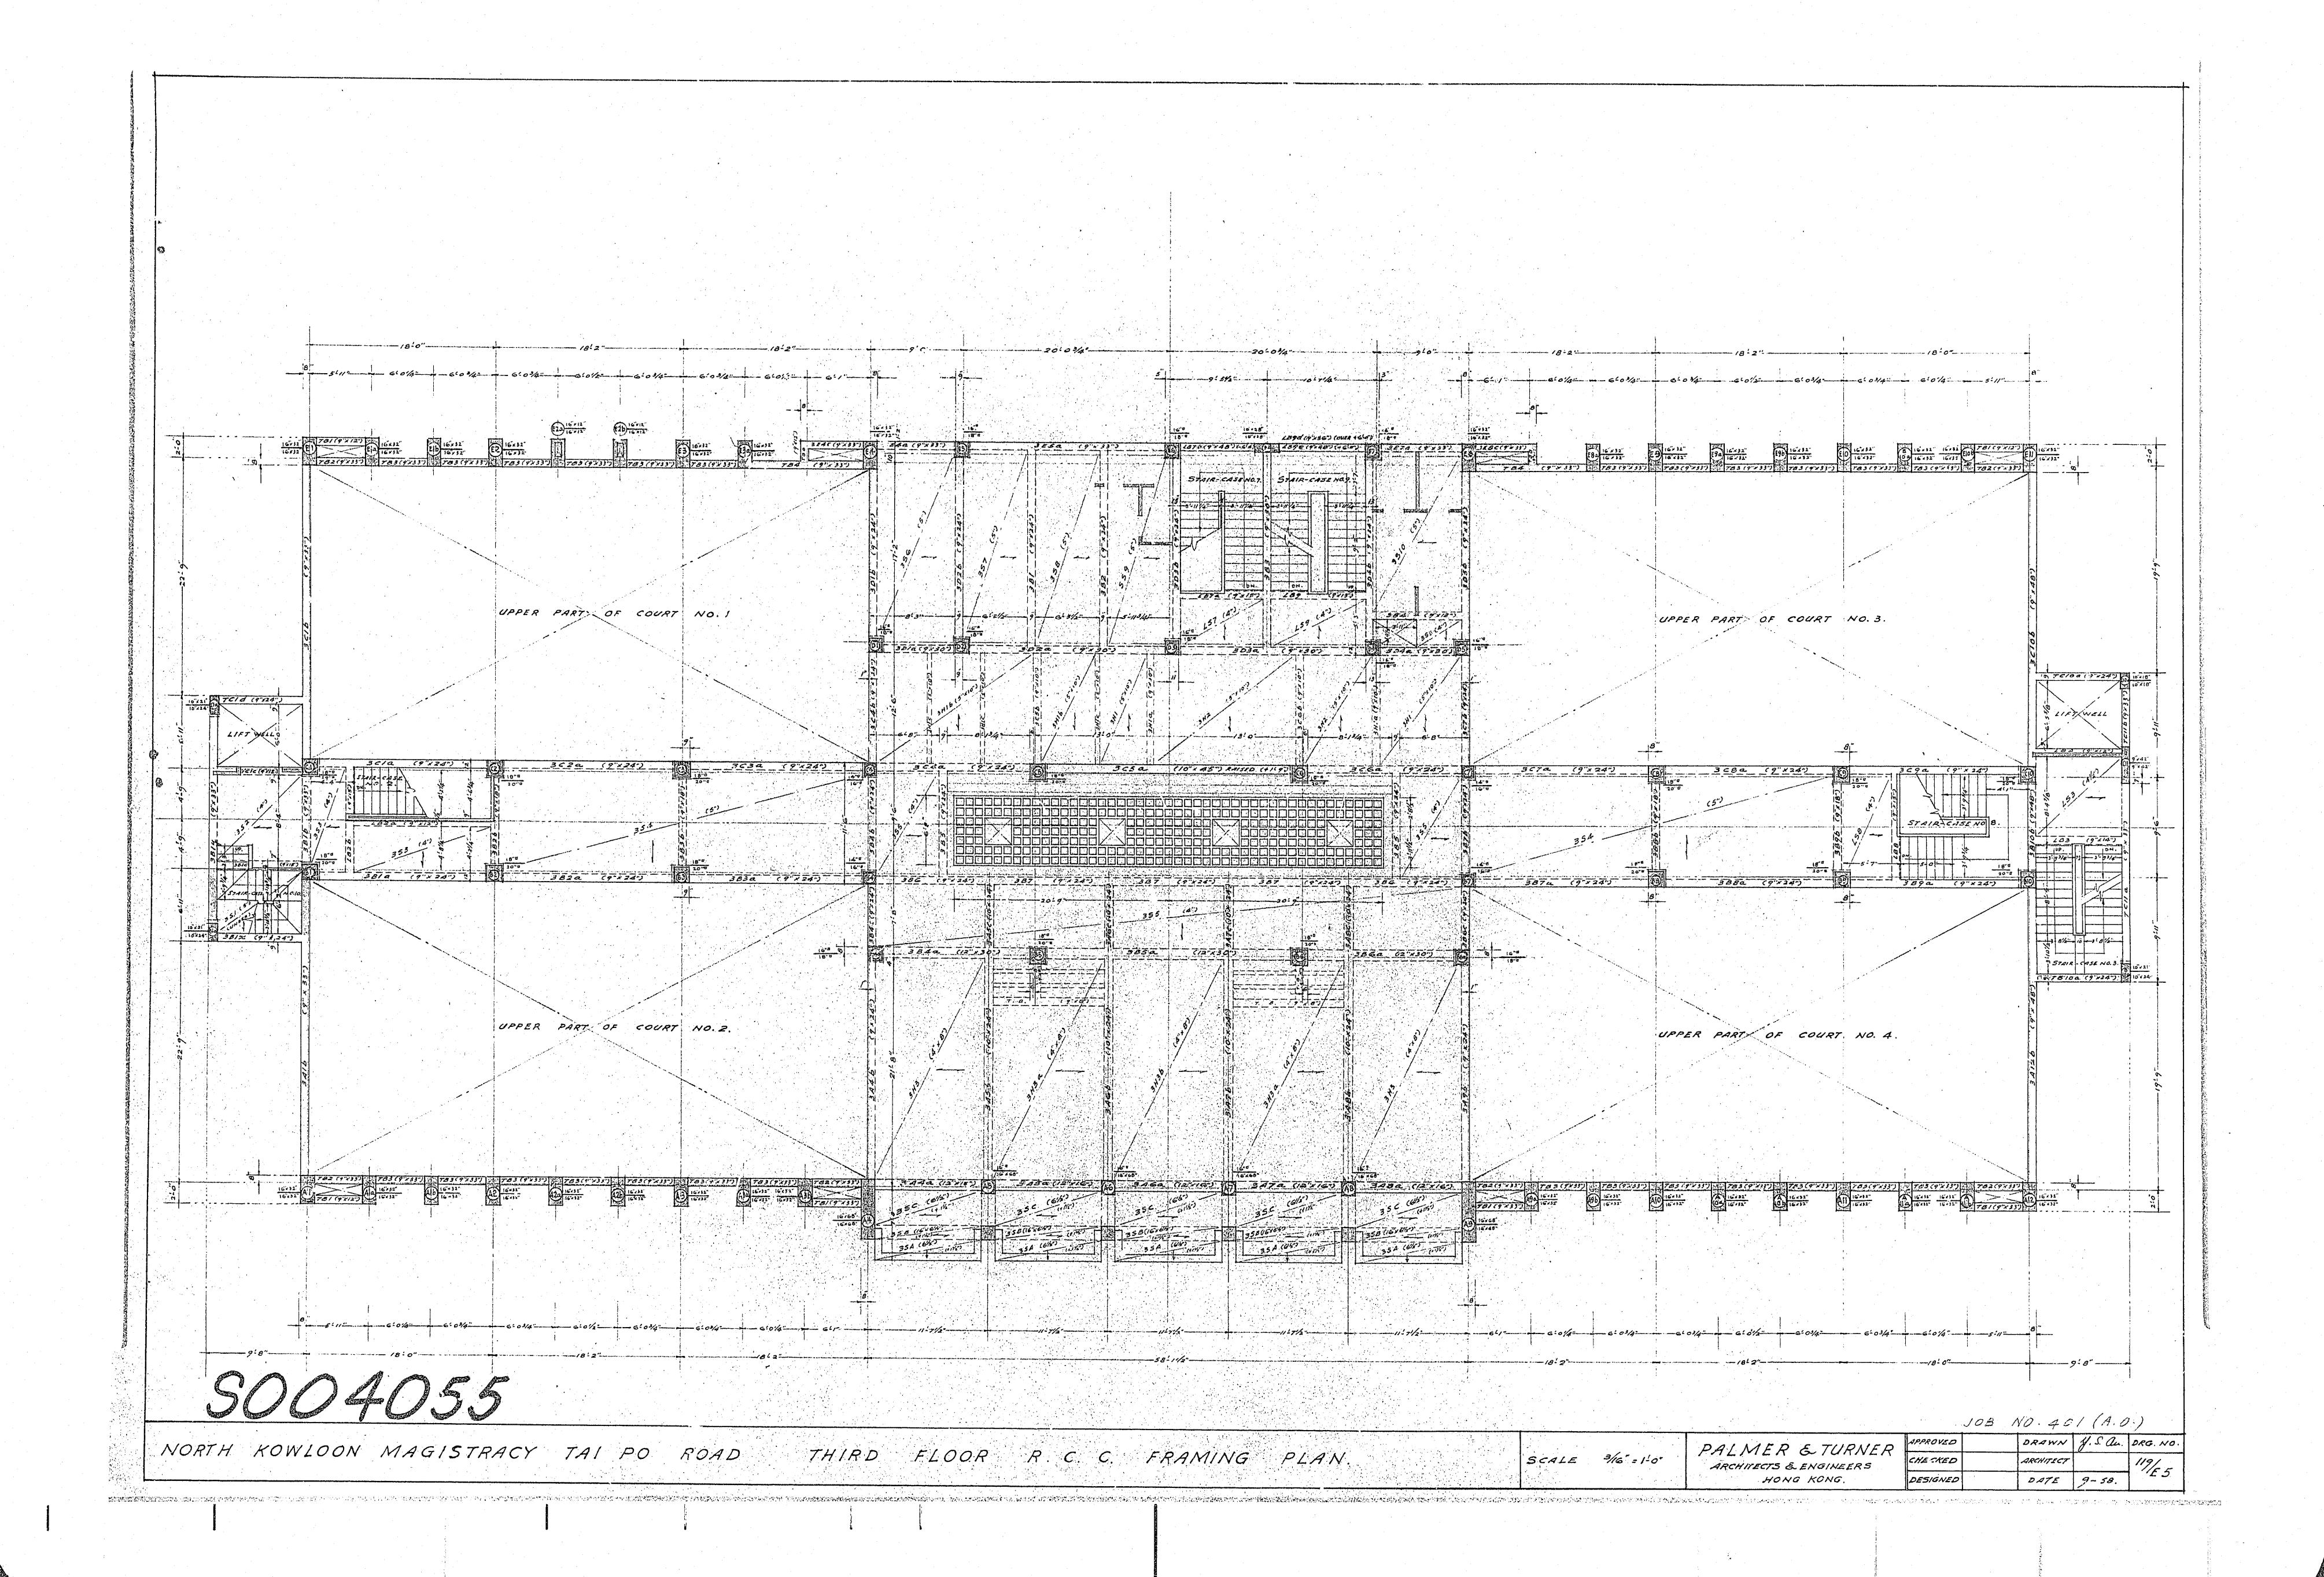



50004053 REINFE OF FTB2 & FTB4 TYPICAL TIE BEAMS TO 16'x32"


COLS. AT EVERY FLOOR

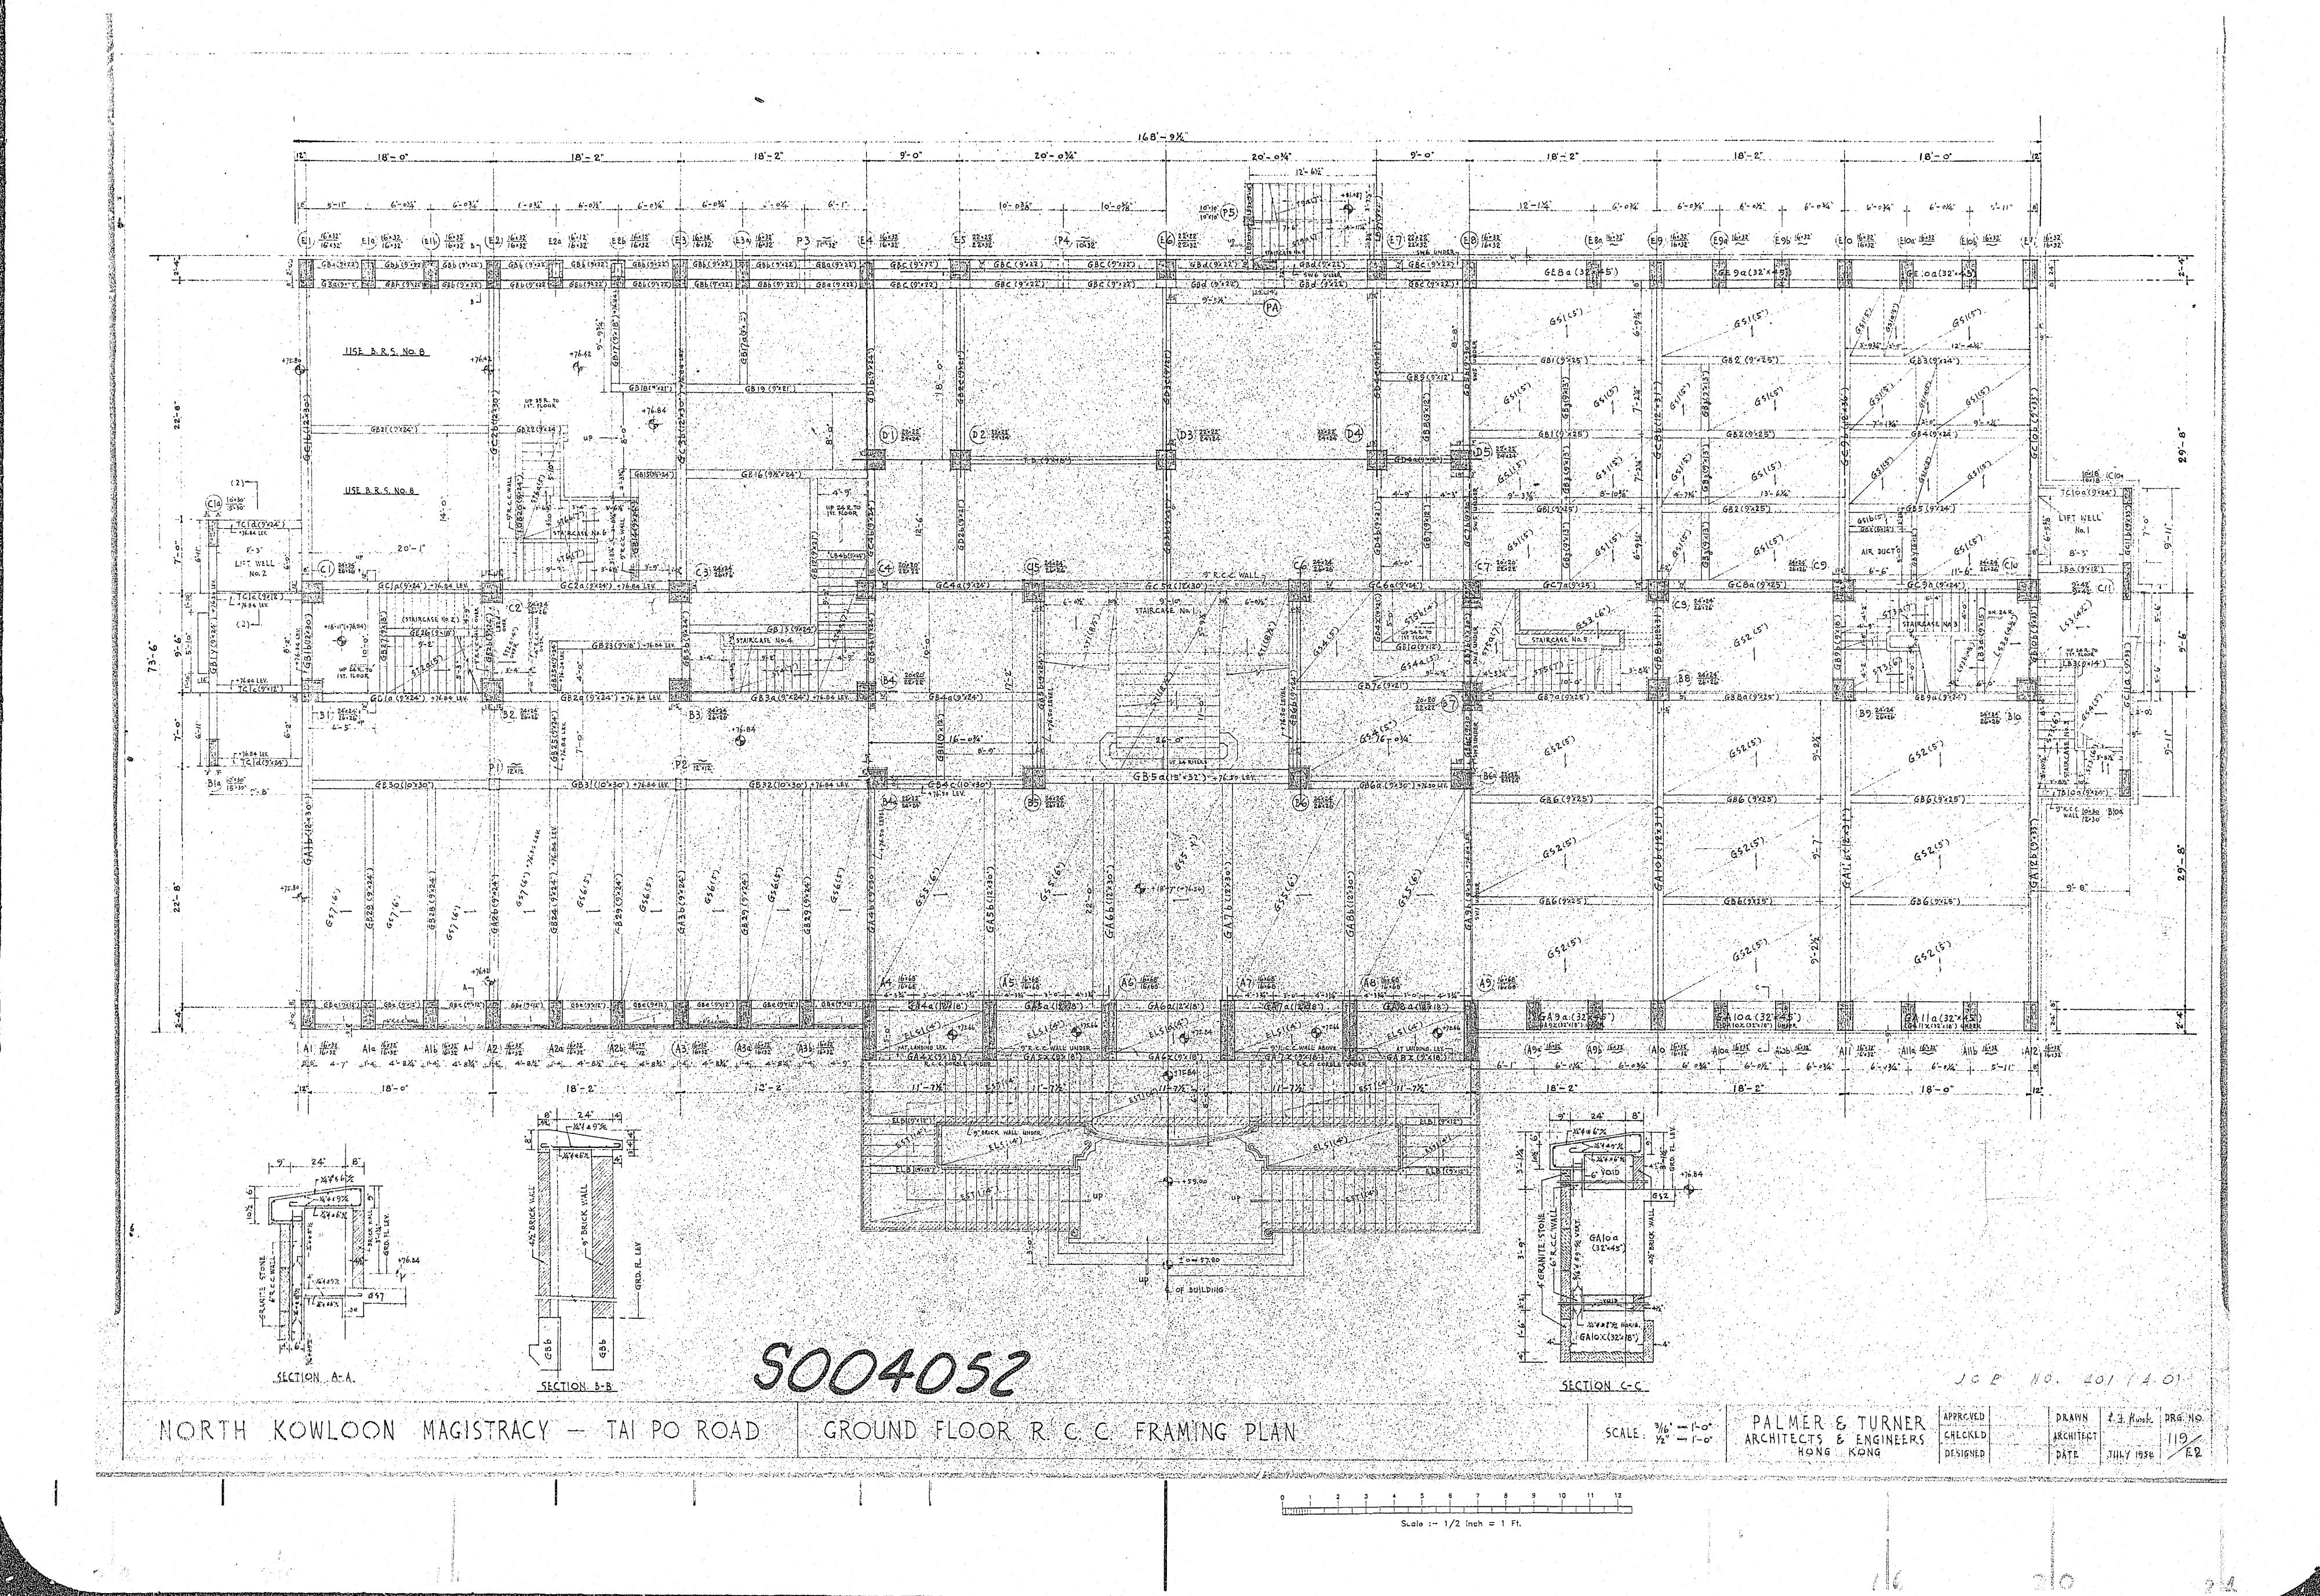
(WHERE MESESSARY) St 9/2° 2'63' 3-3-71/4" 3'4 216/2" 4'2" / TCId (9'x24") : 1 CA a. (10" x30") 1H2a (9"x 12") 18C1 (9"x18") INVERTED 18C1 (9"x18") INVERTED 18C1 (9"x18") 103 NO. 601 (A.O) PALMER & TURNER NORTH KOWLOON MAGISTRACY TAI PO ROAD FIRST FLOOR R. C. C. FRAMING PLAN. ARCHITECT ARCHITECTS & ENGINEERS HONG KONG Common the second with the common the second of the second of the common the second of the second of the common the secon







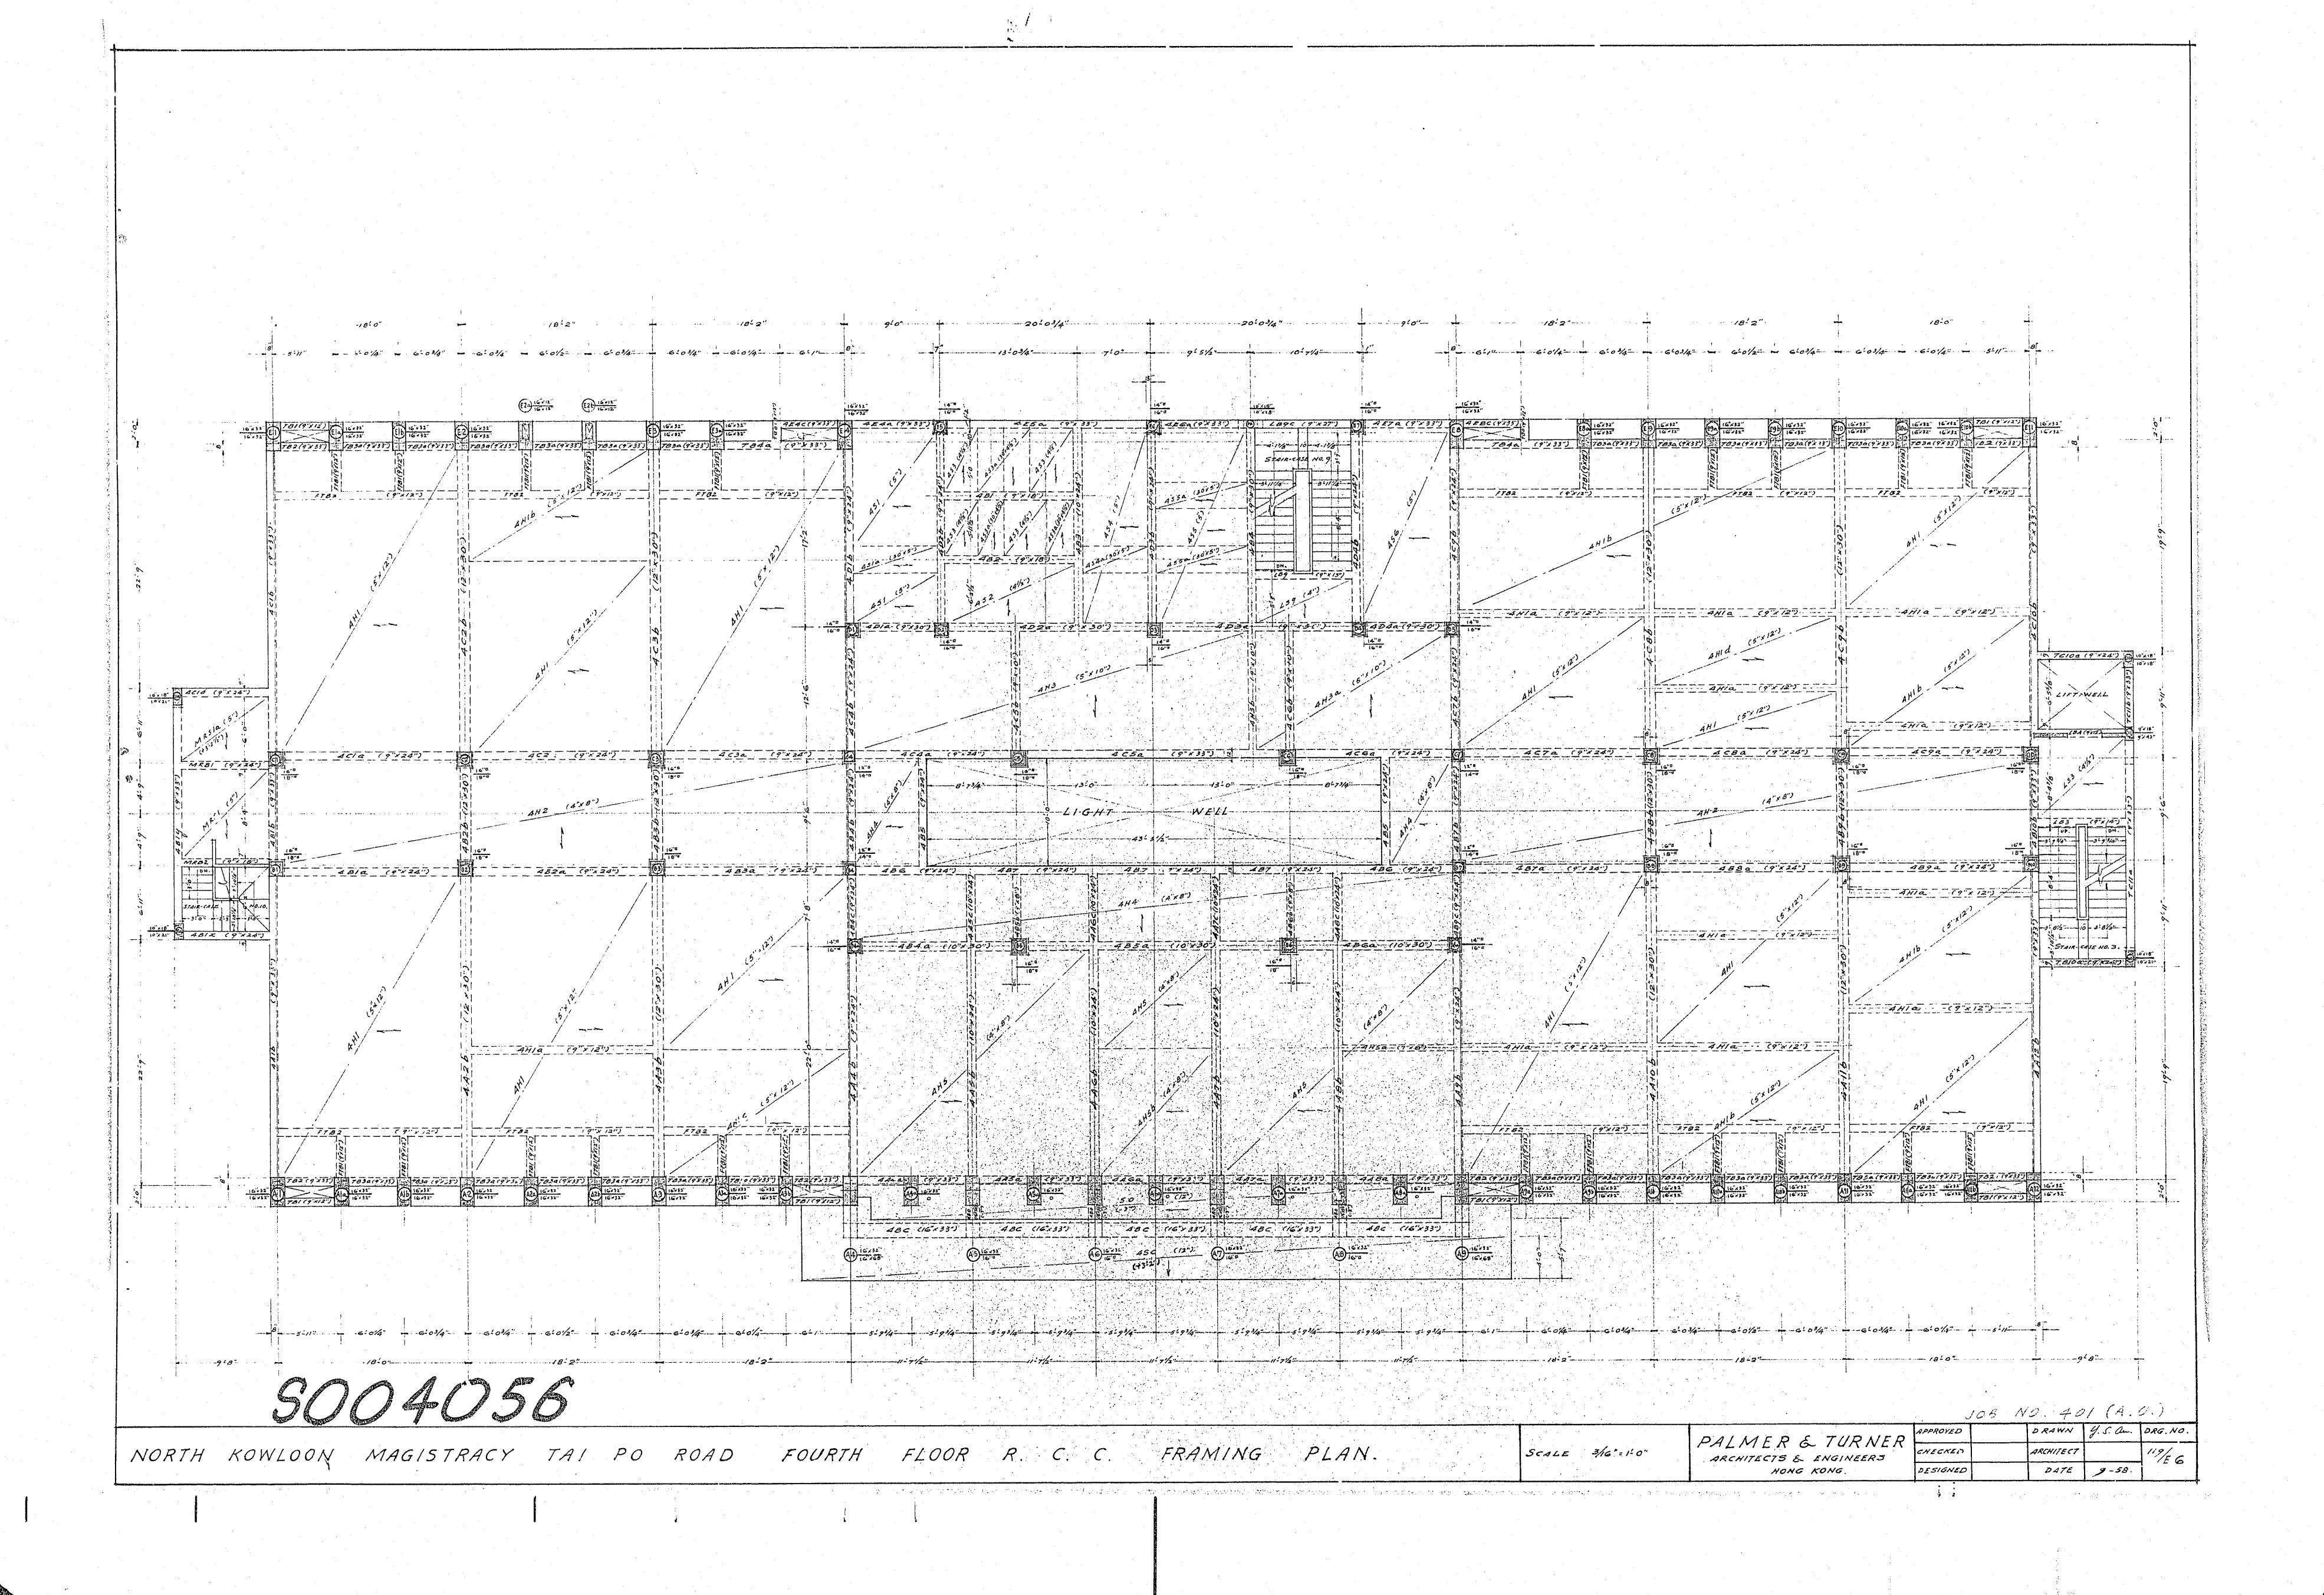


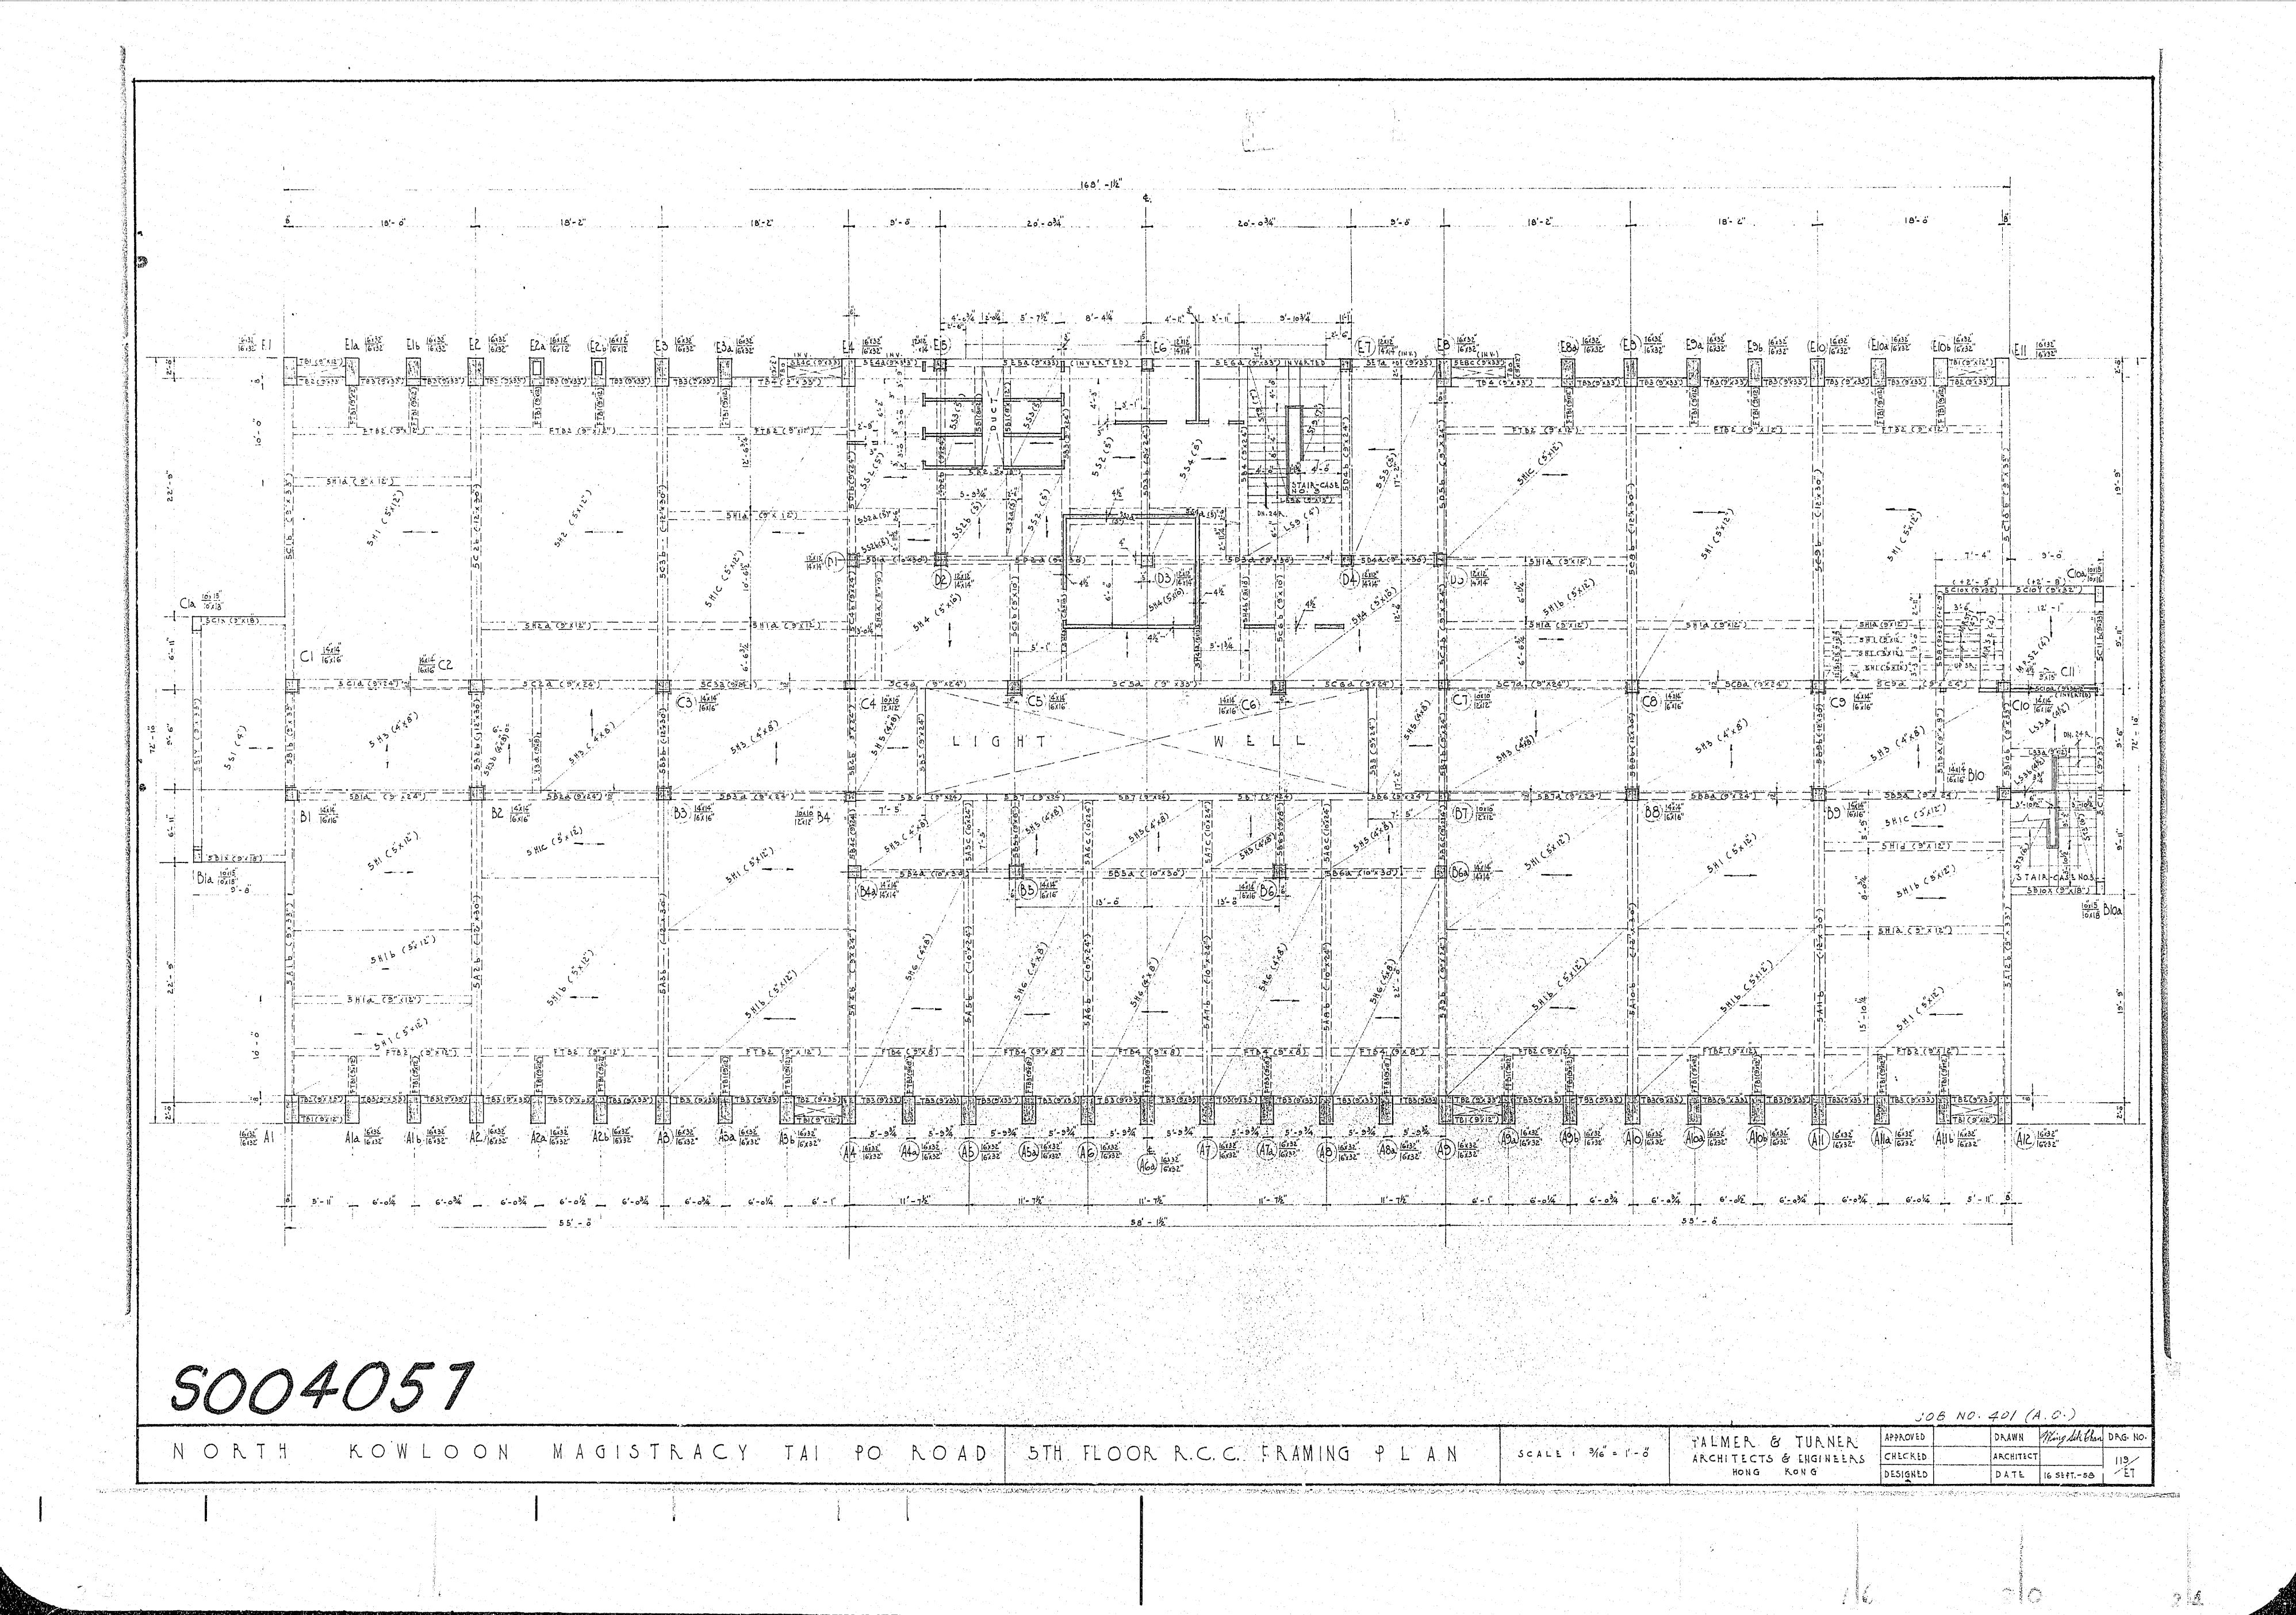


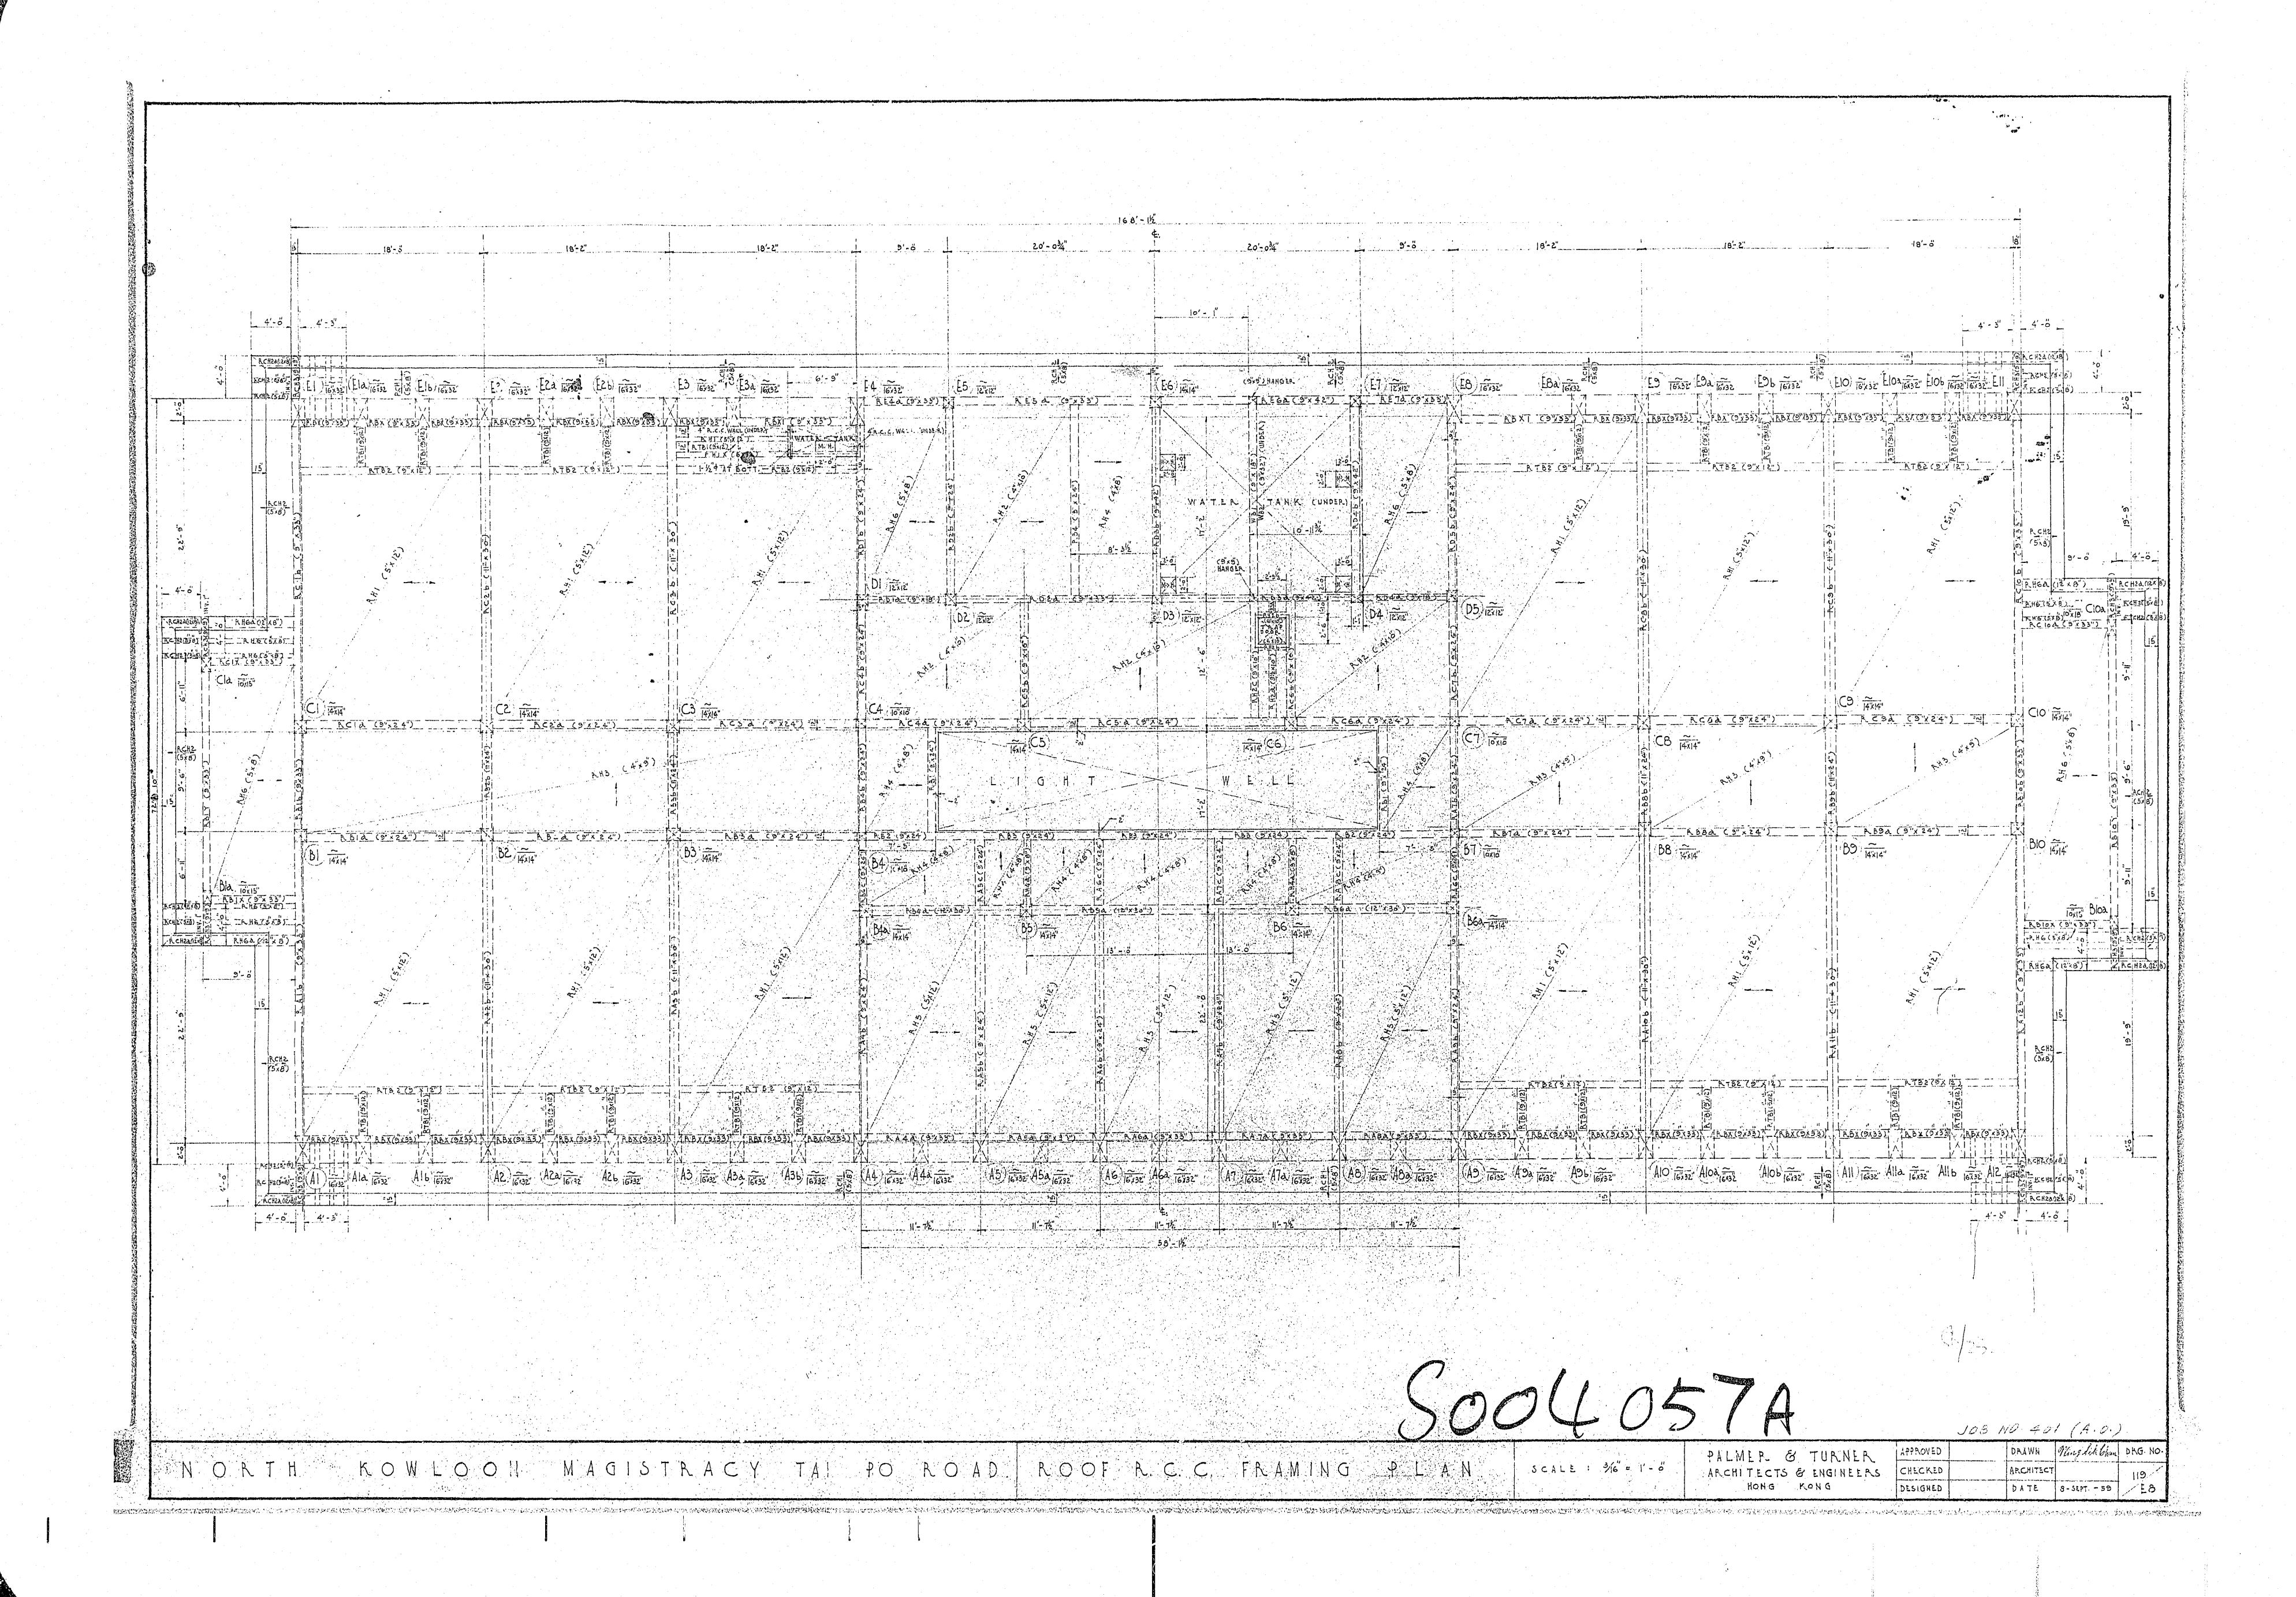


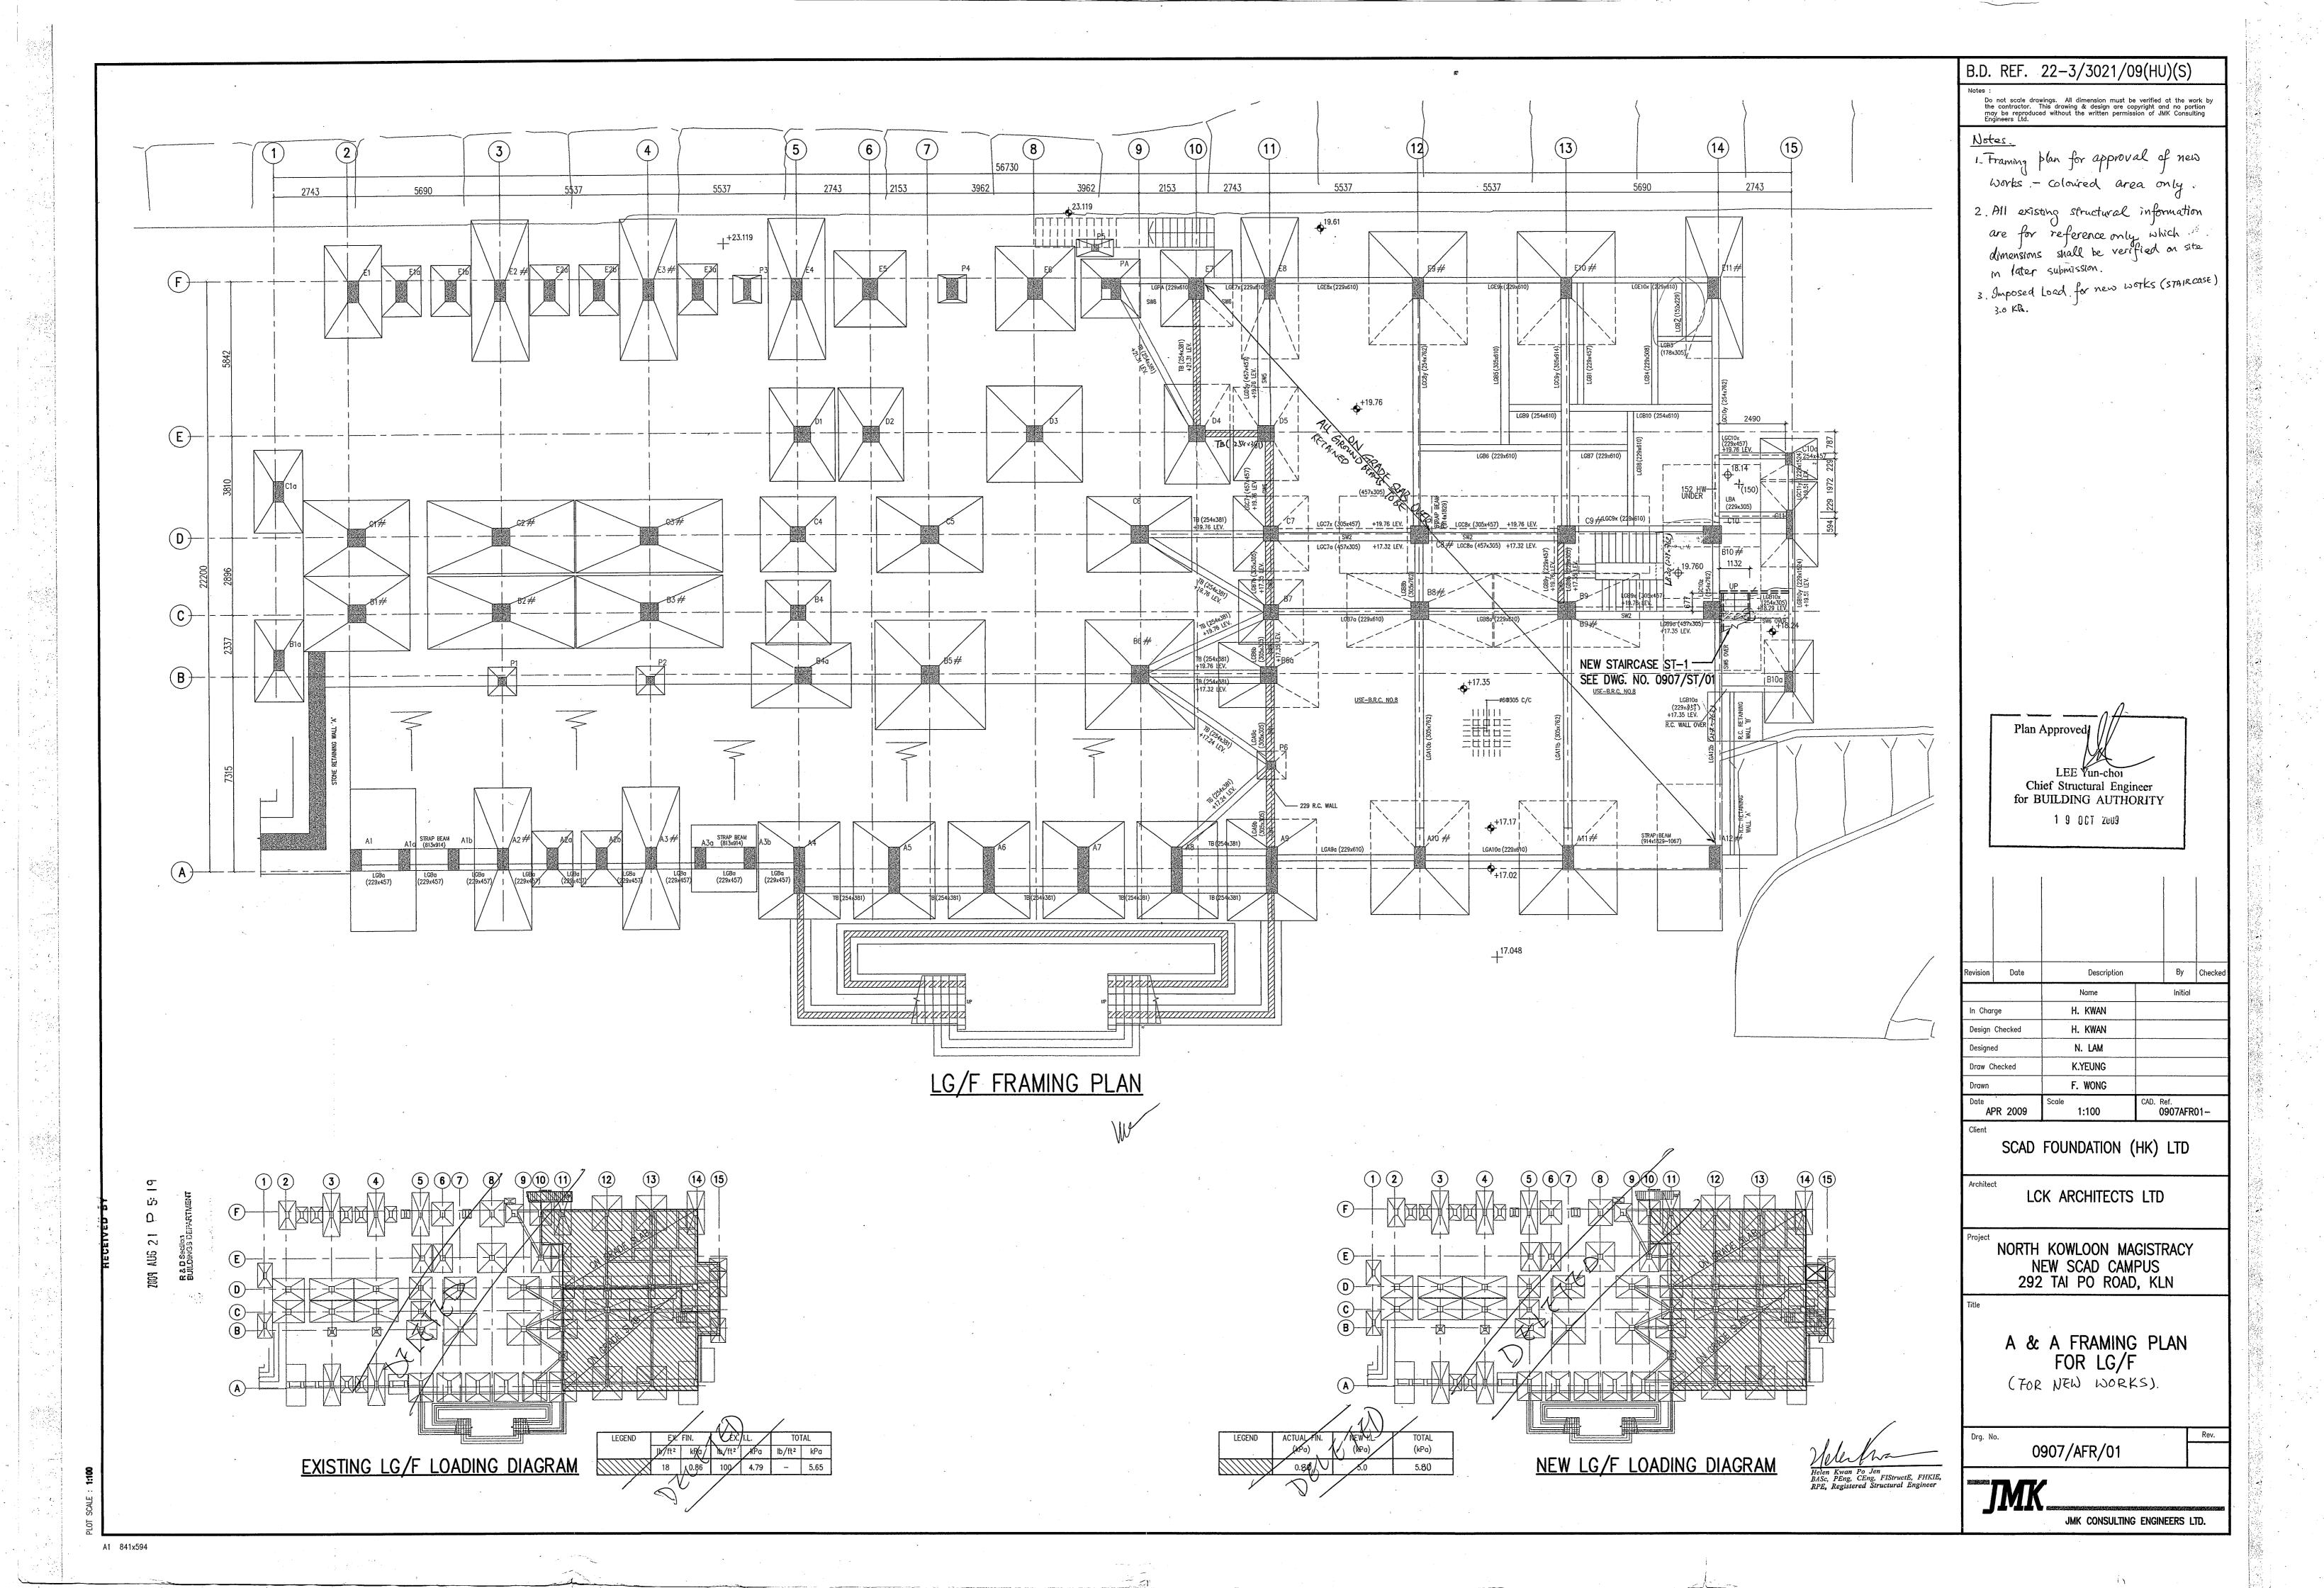


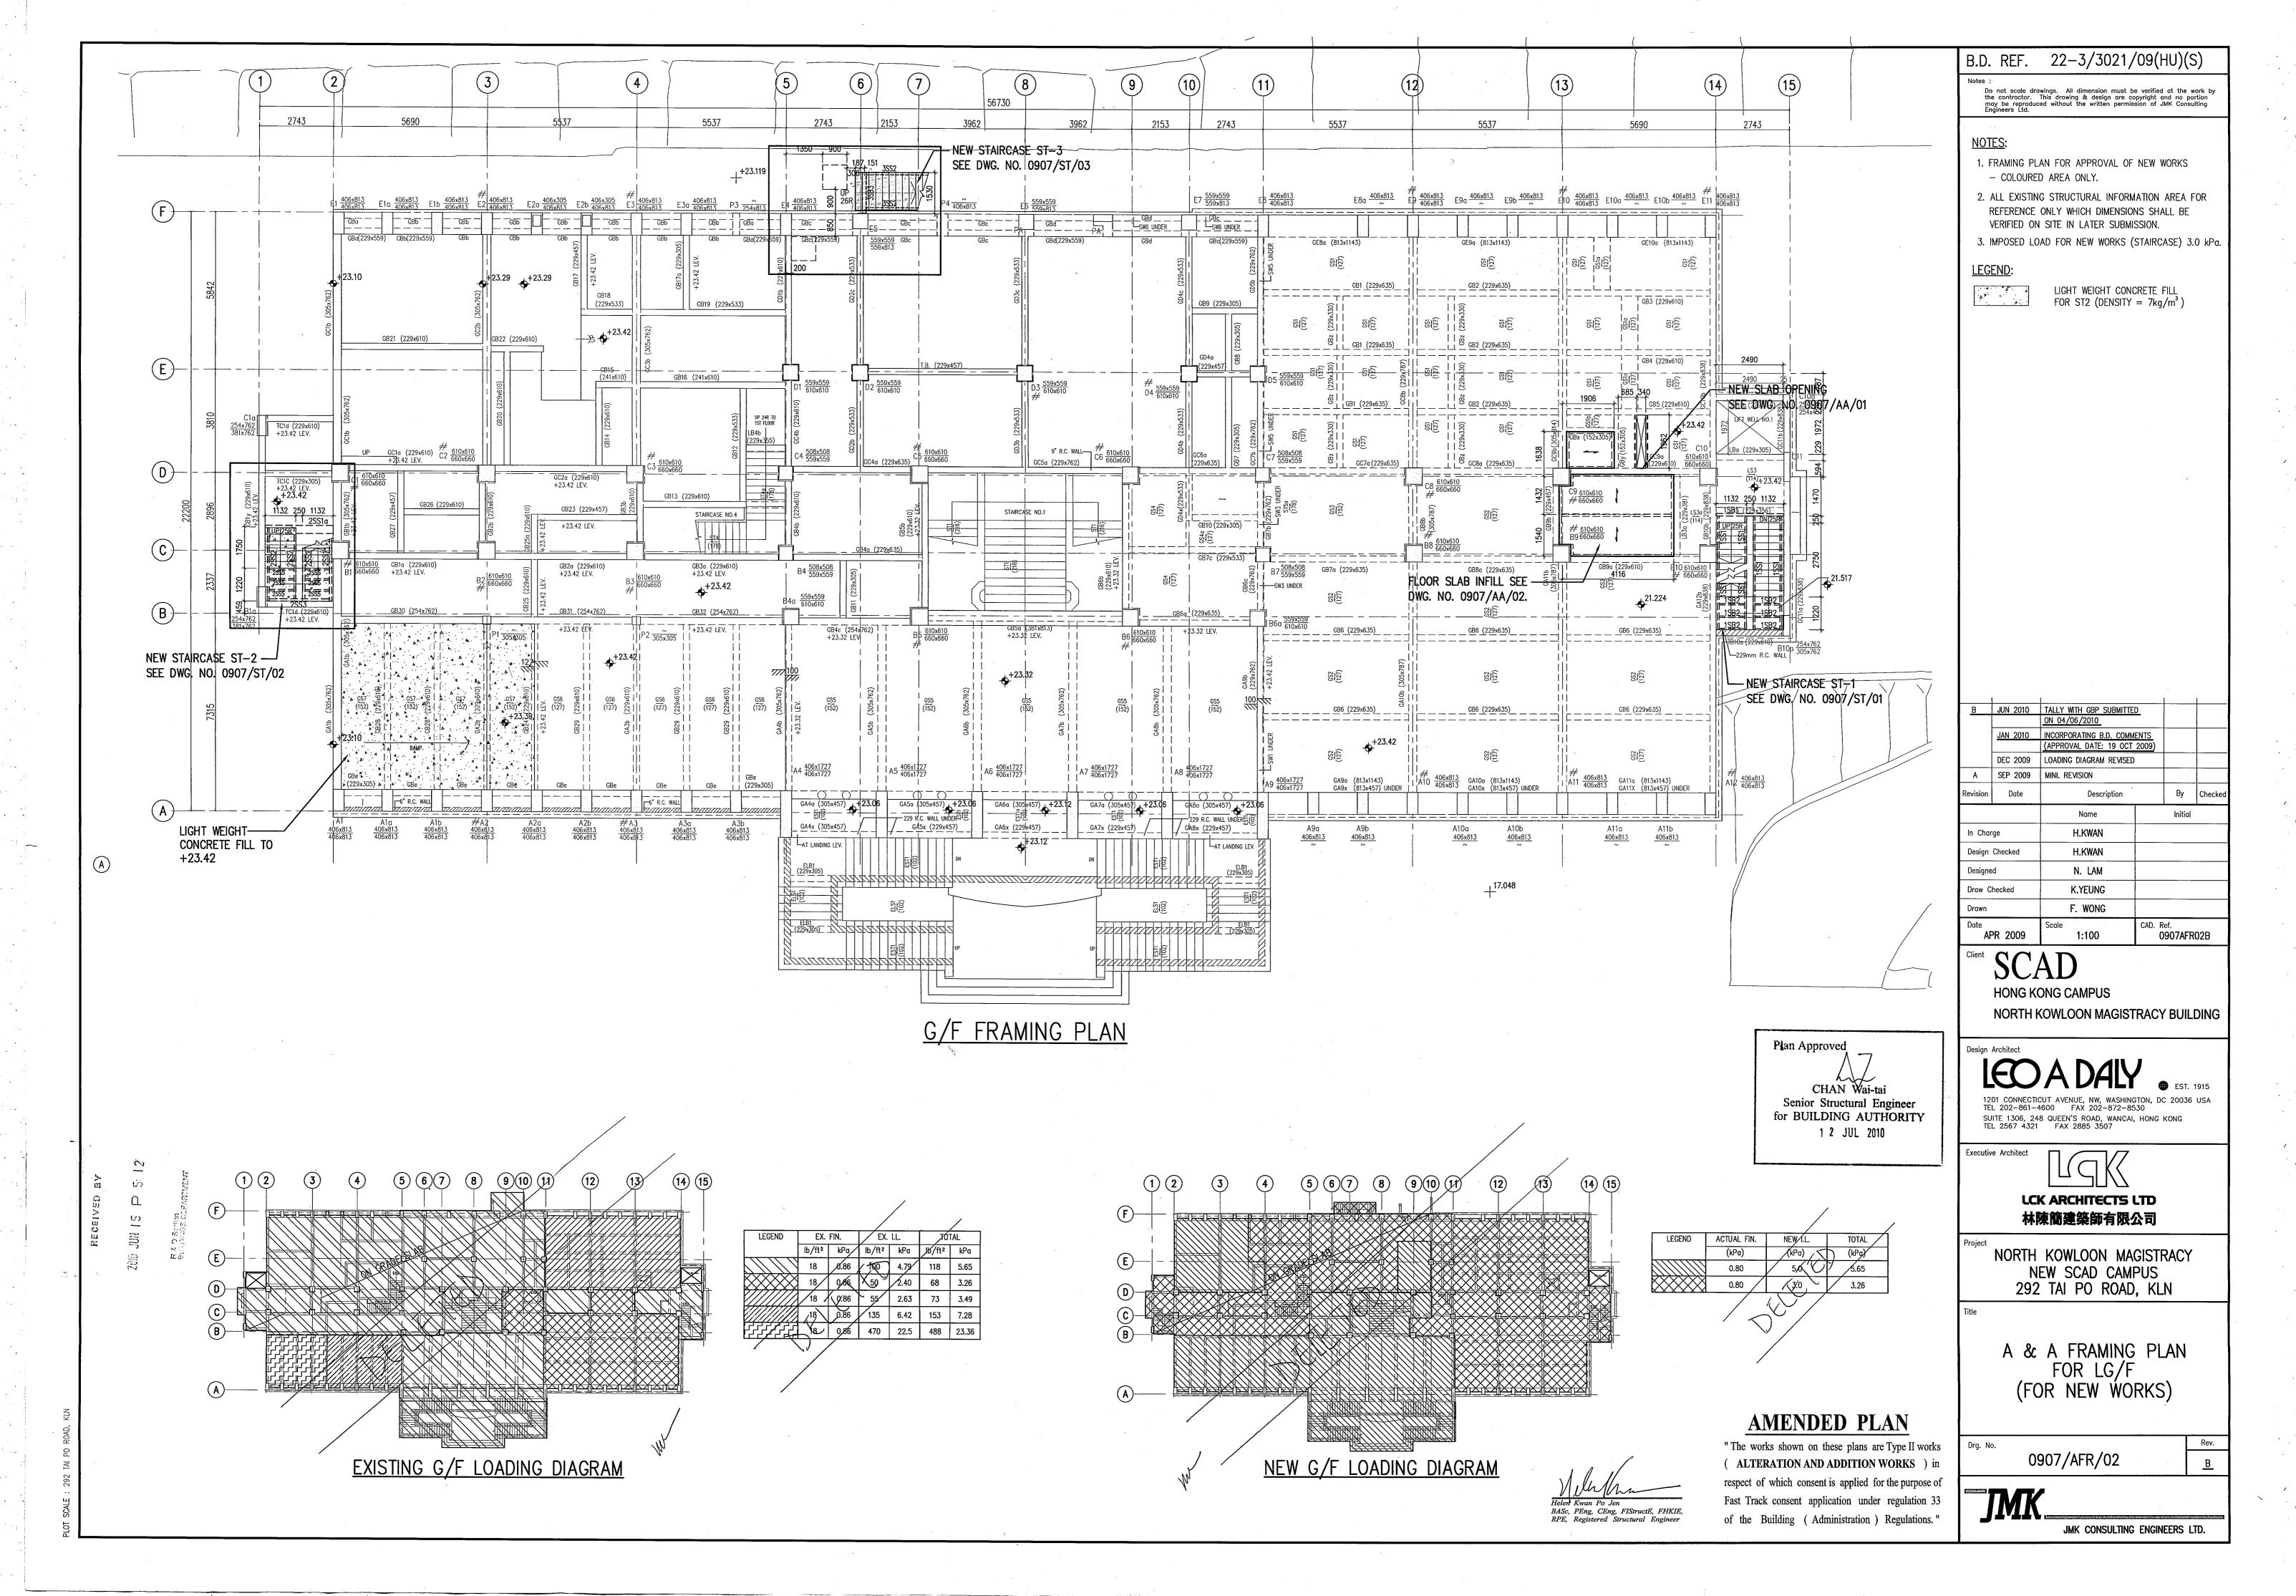


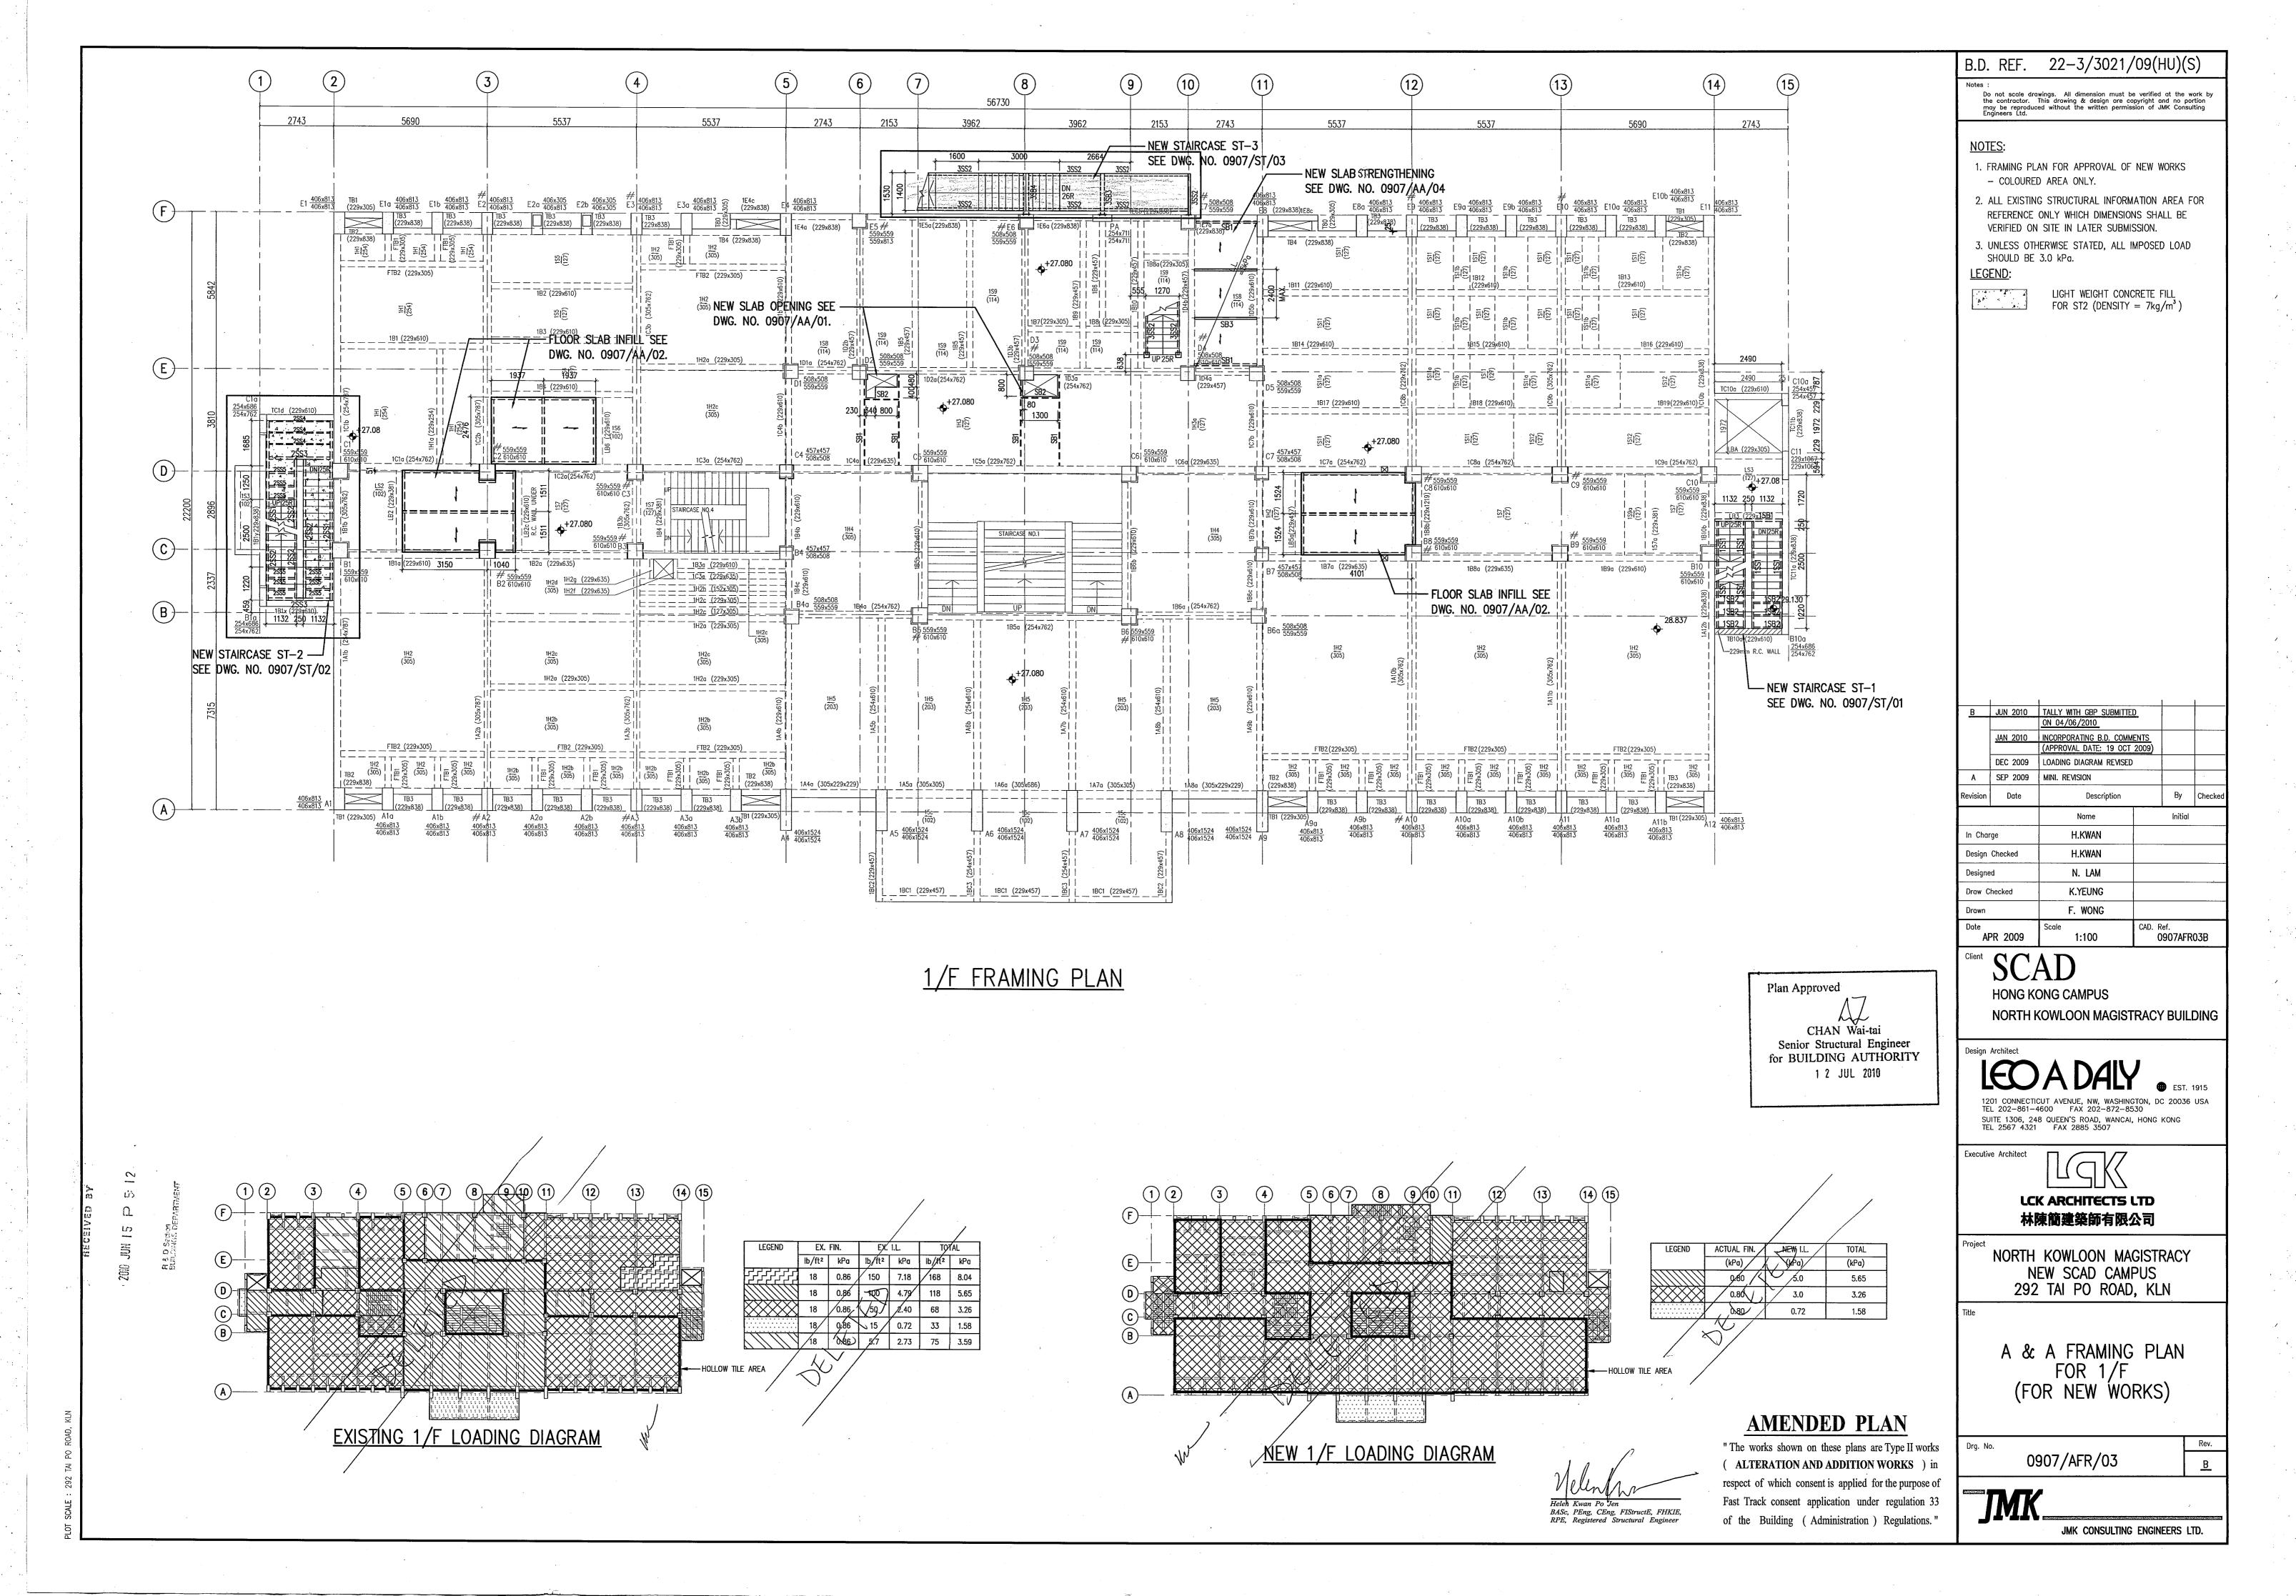


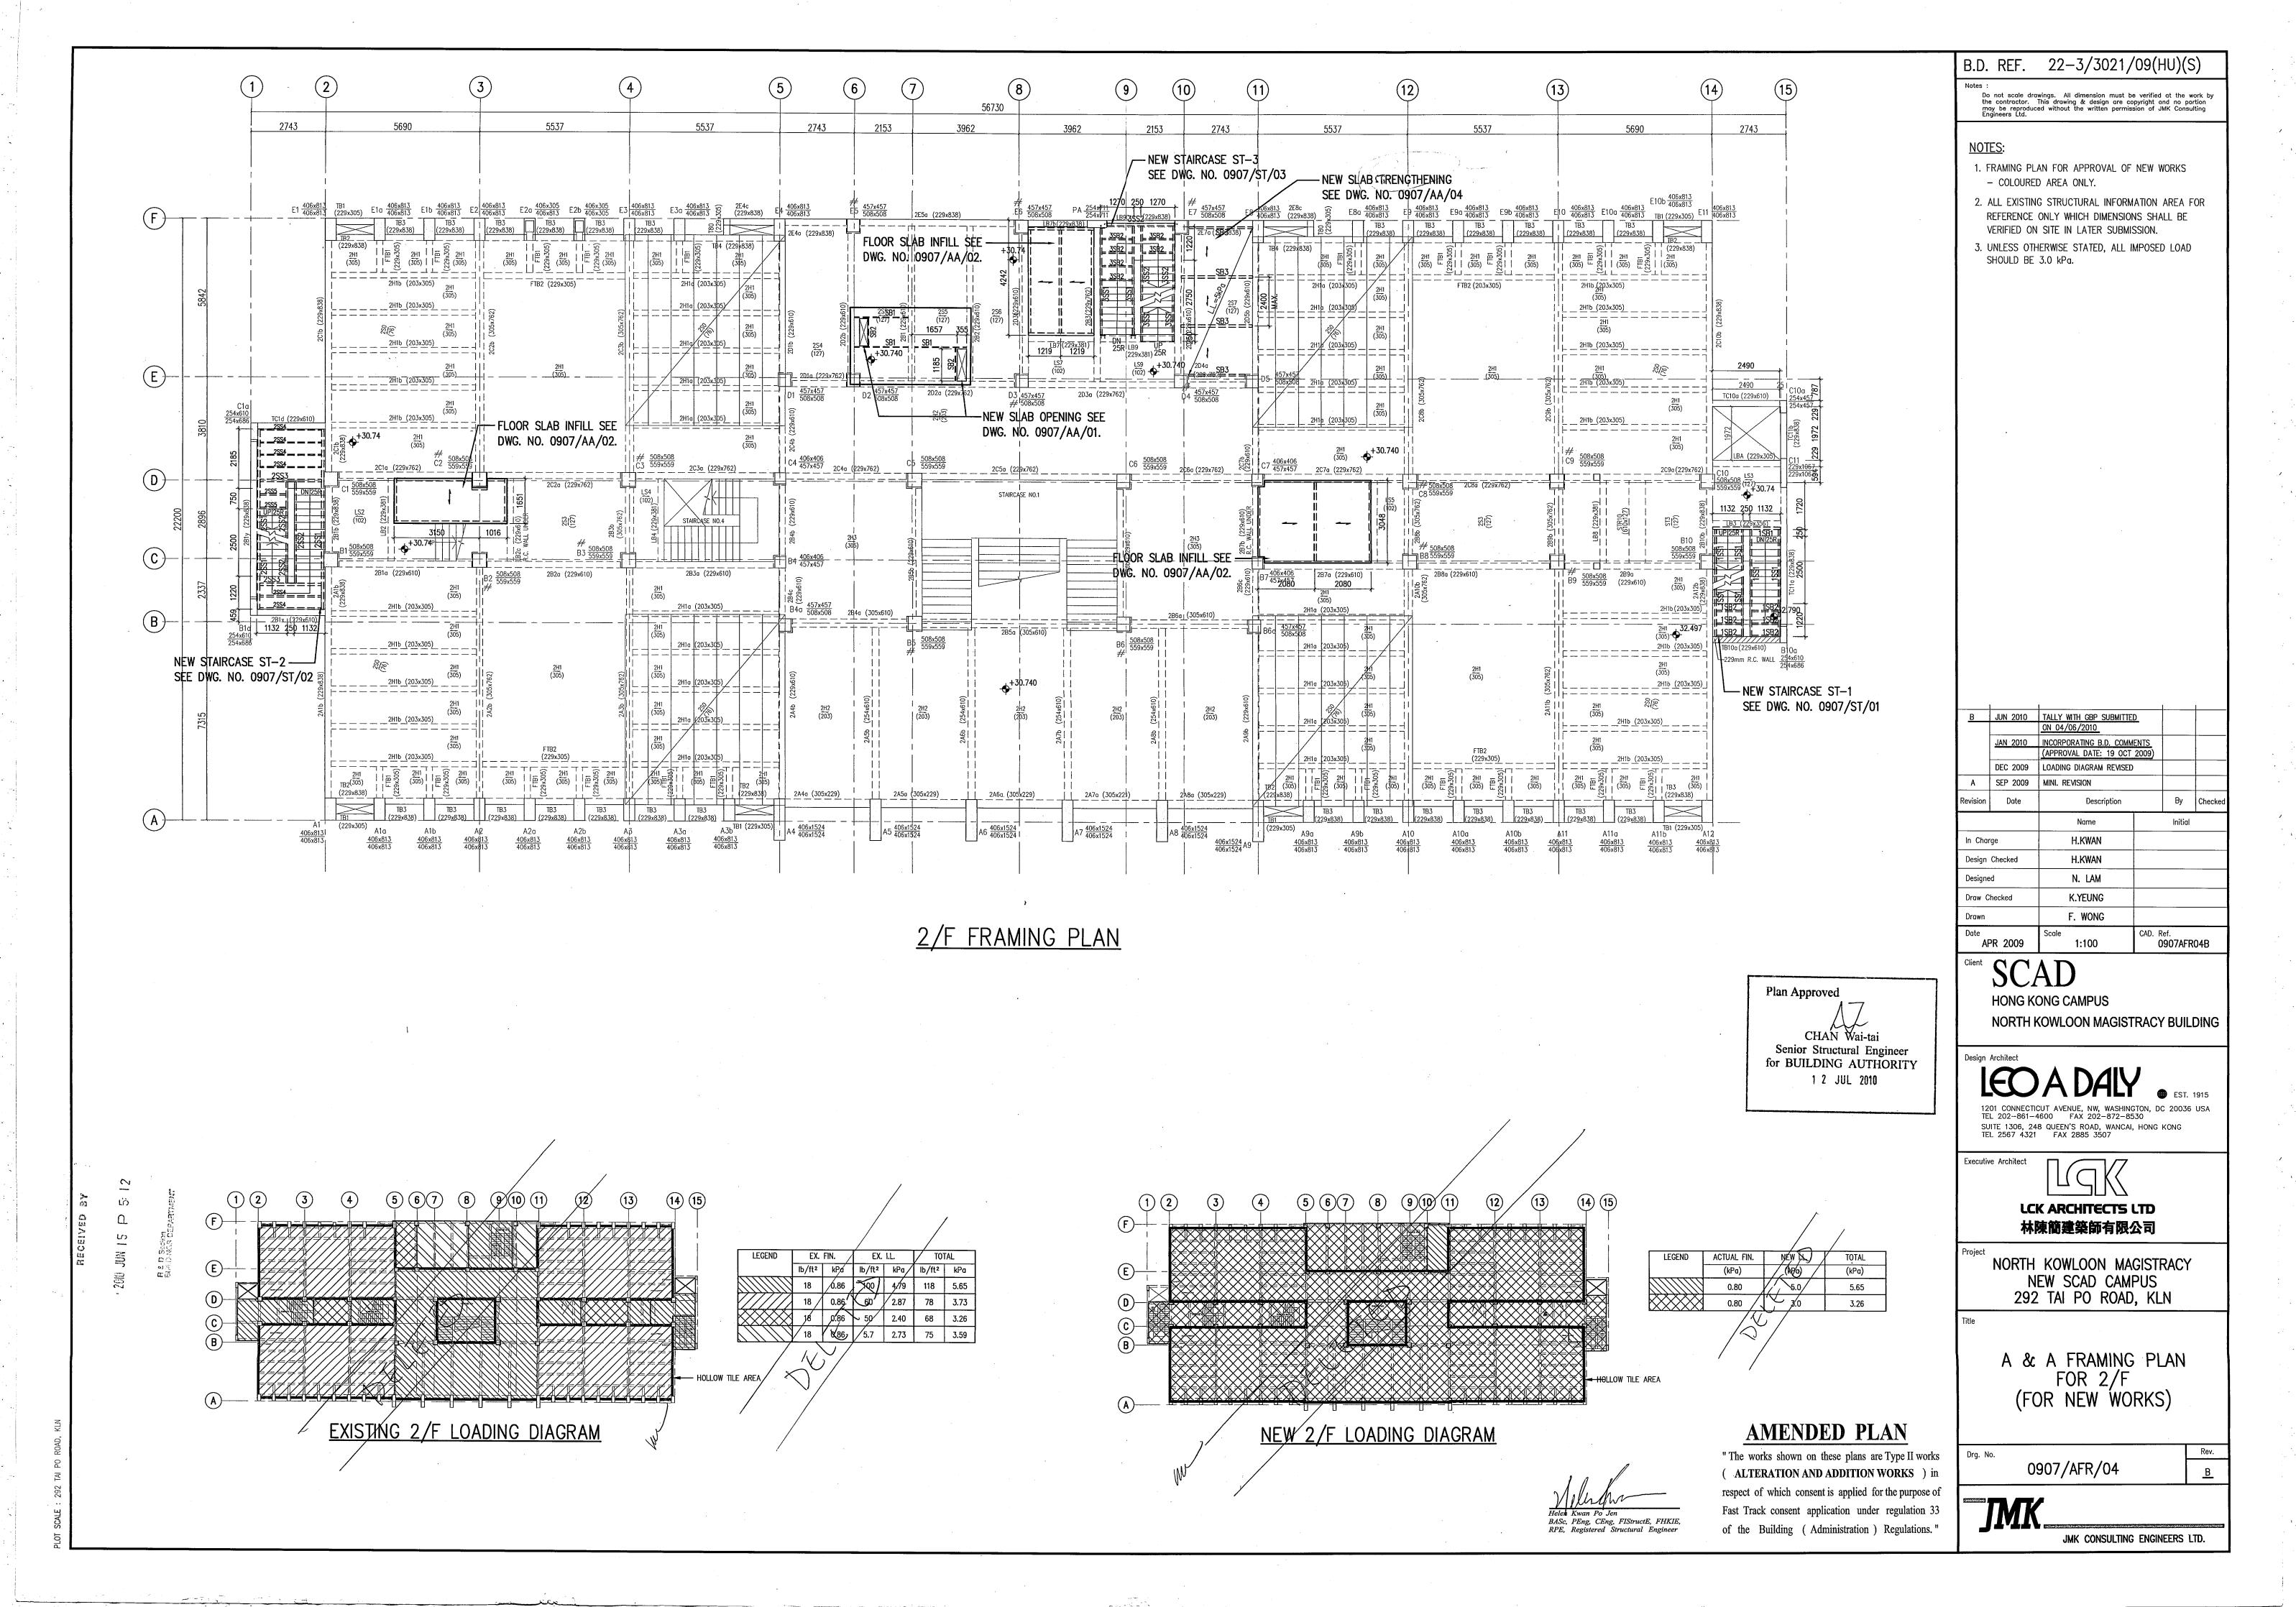

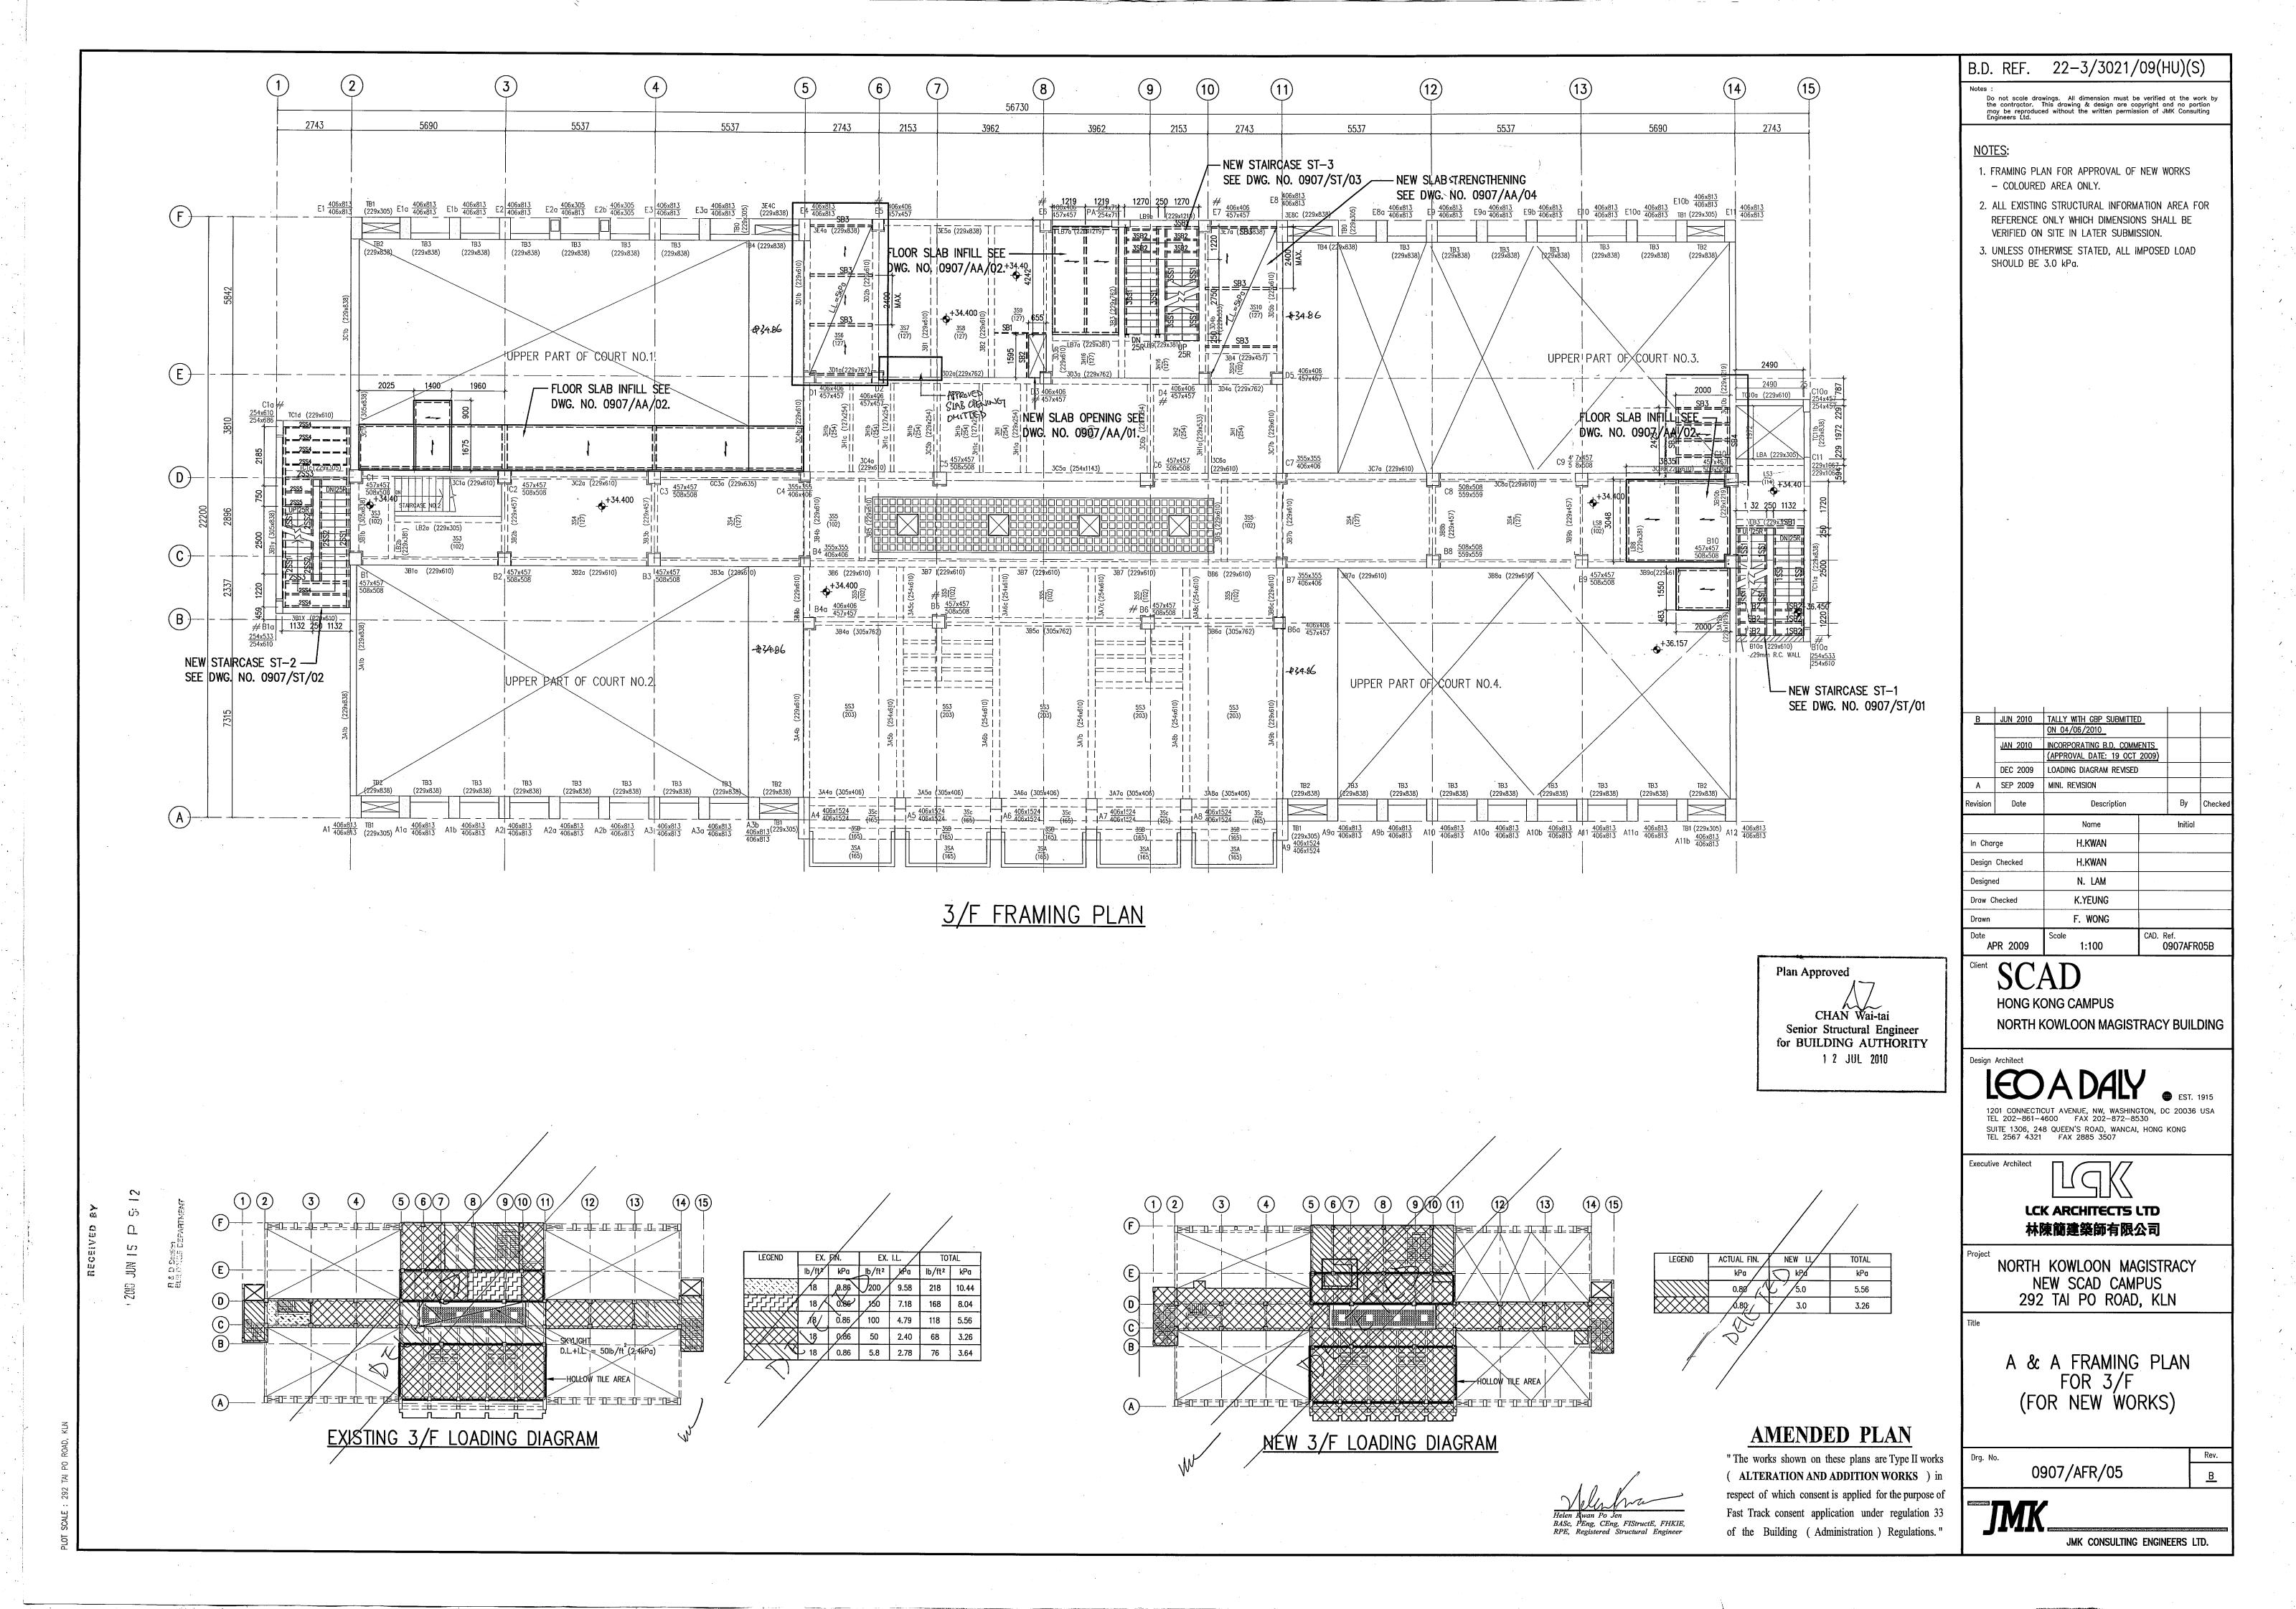

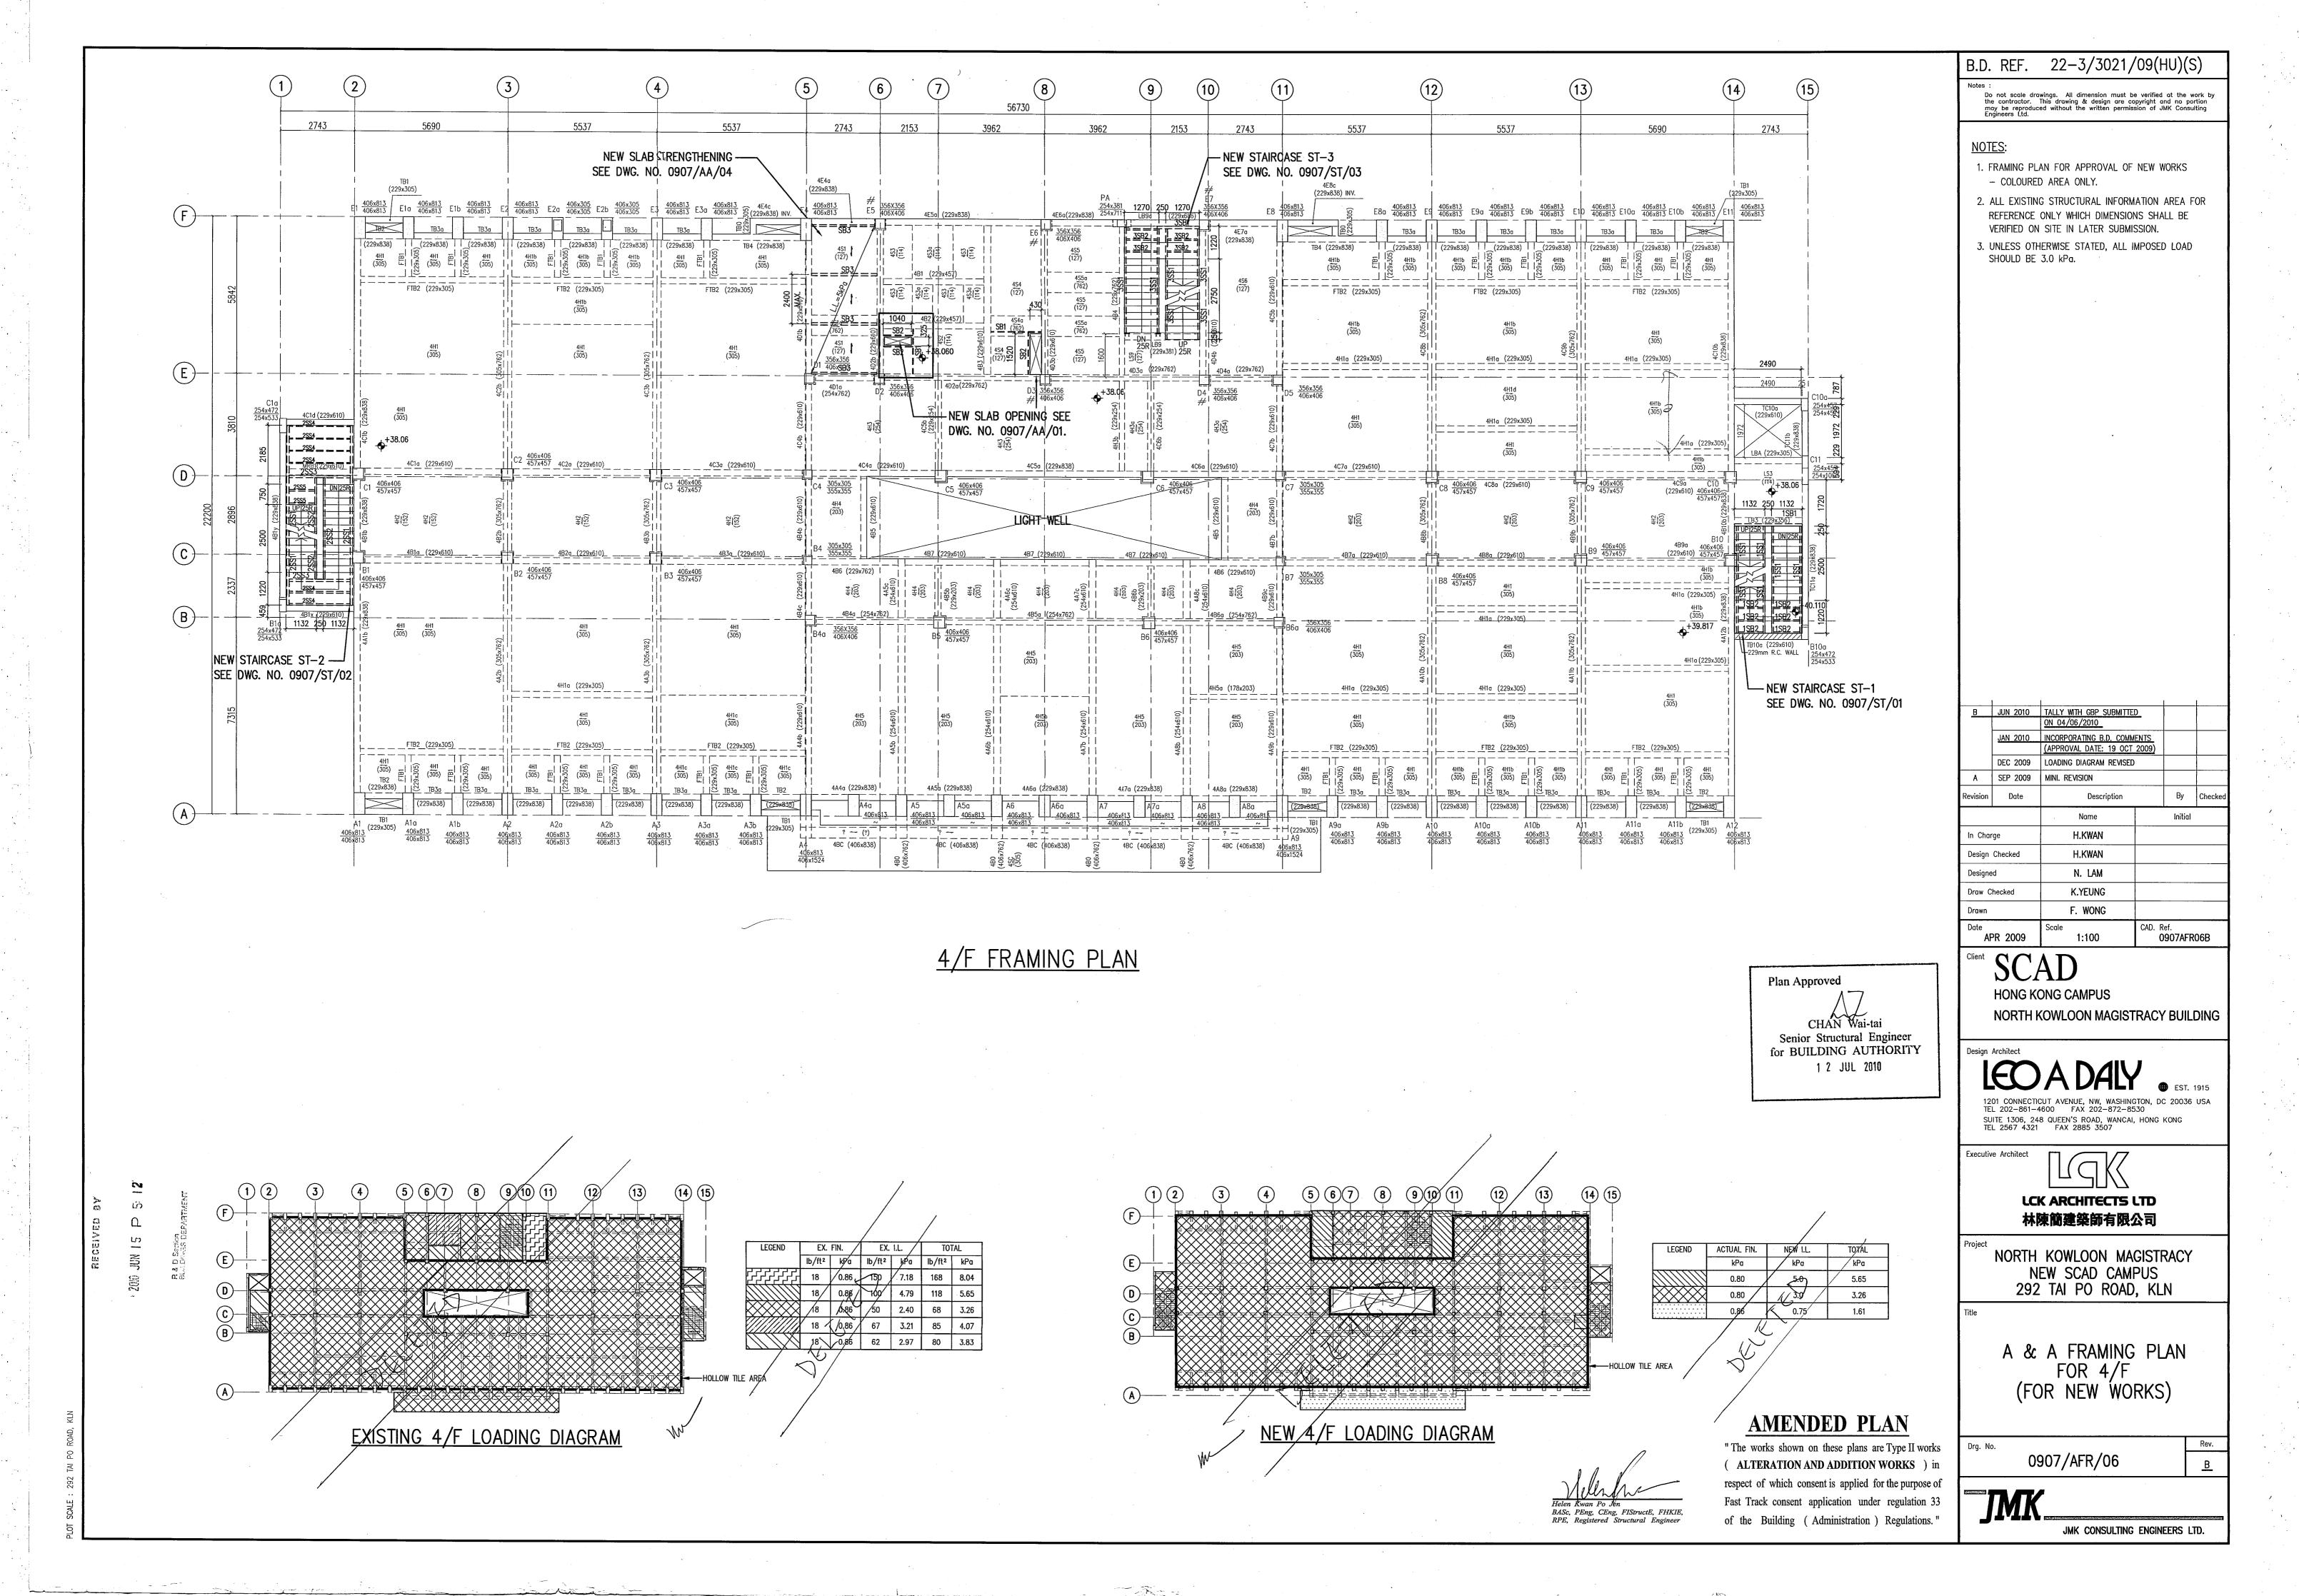

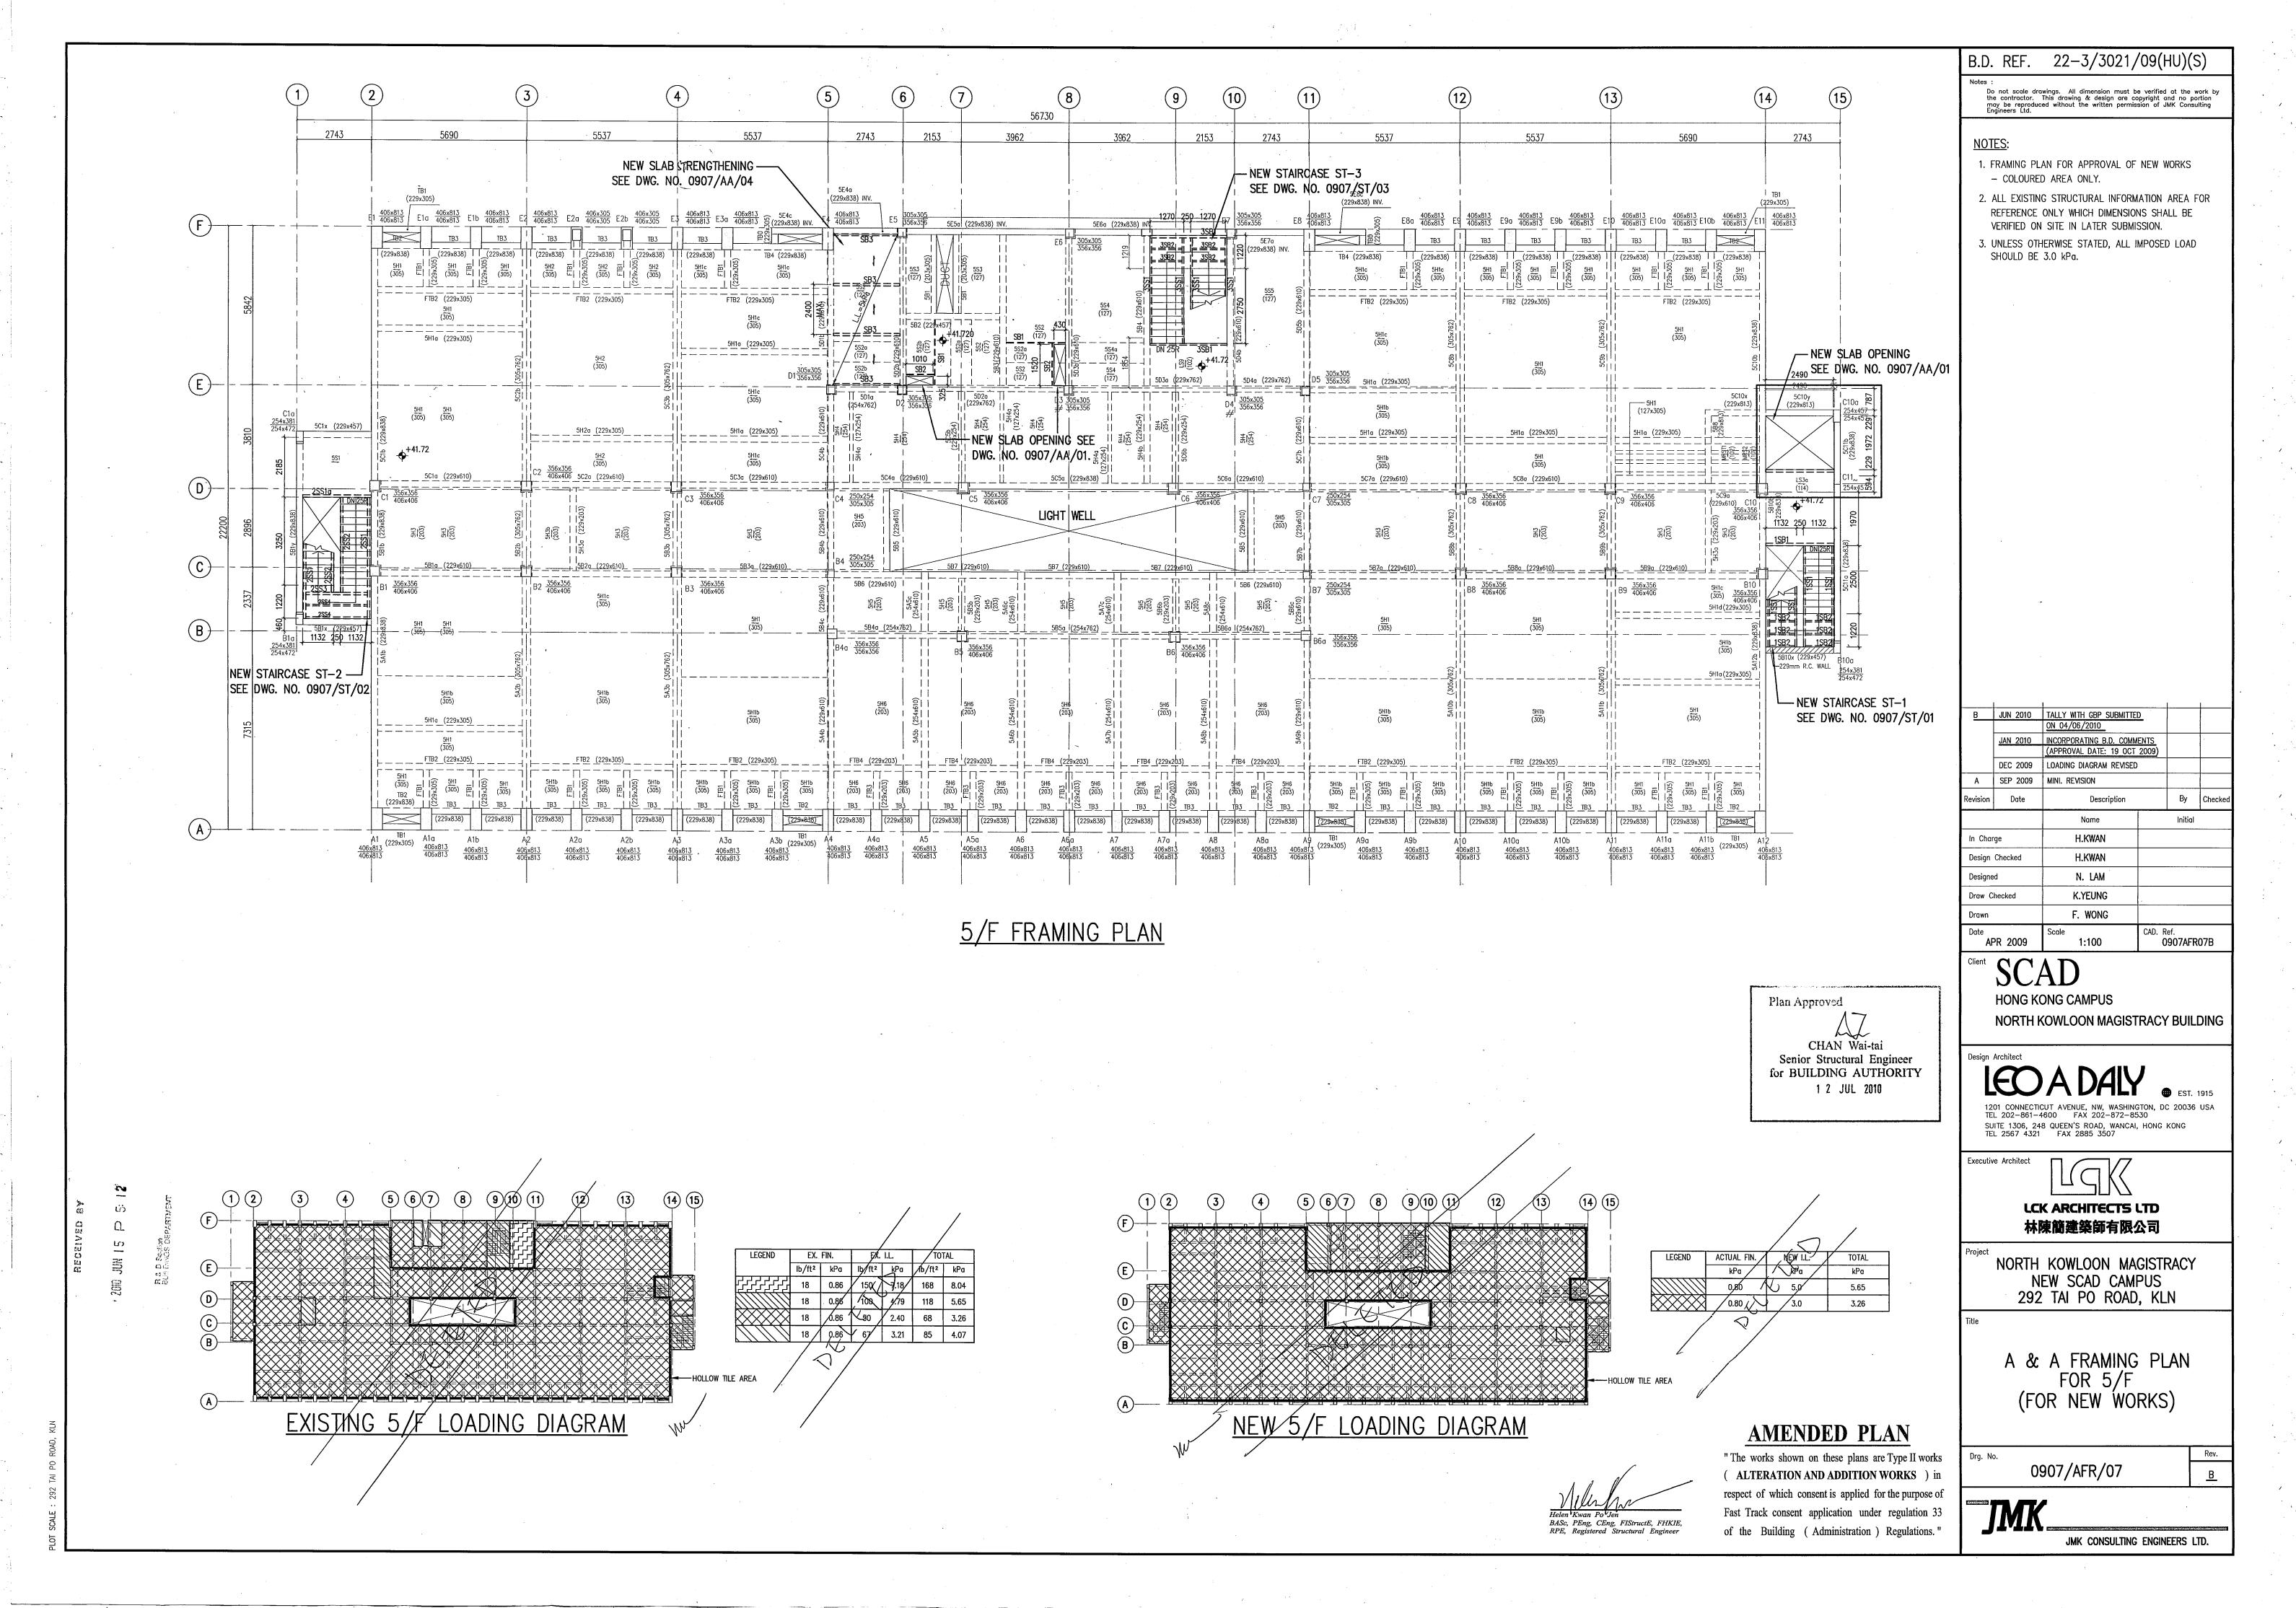

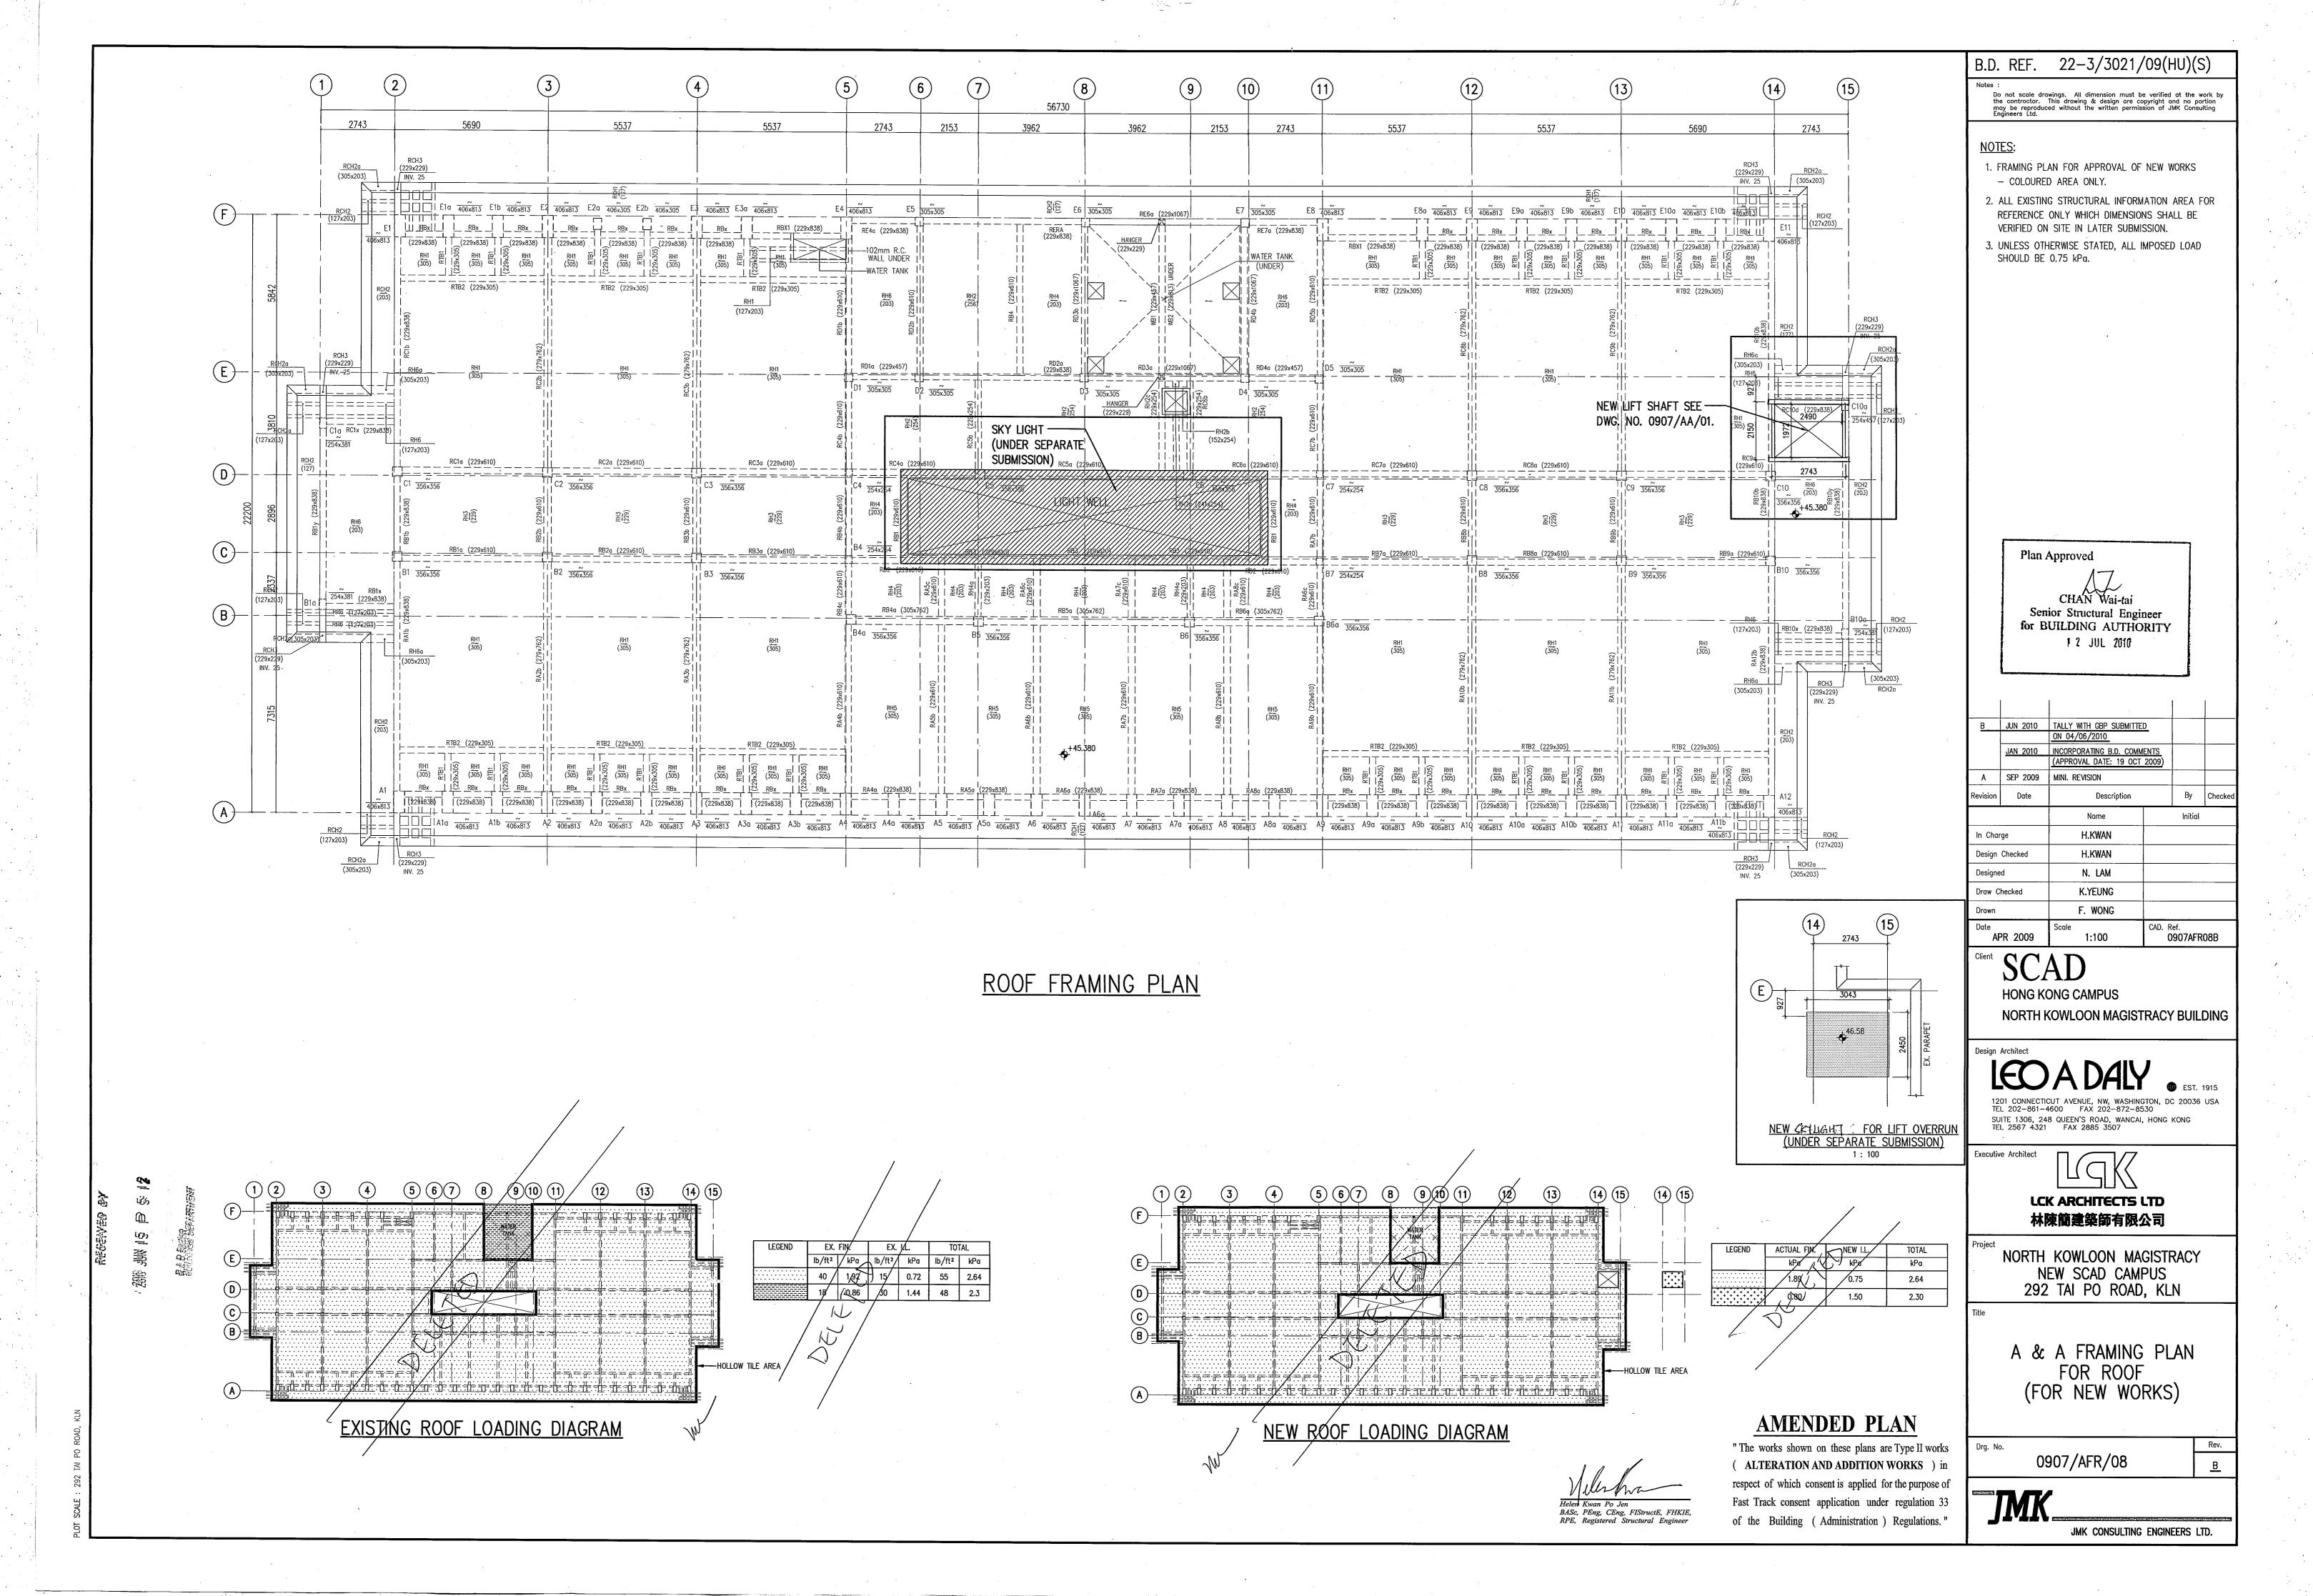



Appendix VI(D)


Topographic Survey Plan

Appendix VI(D) – Topographic Survey Drawings <u>Drawing List</u>

	Drawing No.	Drawing Title
1.	HC-15181/01	Topographical Survey Plan of Former North Kowloon
	Sheet 1	Magistracy, Tai Po Road, Kowloon
2.	HC-15181/01	Topographical Survey Plan of Former North Kowloon
	Sheet 2	Magistracy, Tai Po Road, Kowloon
3.	HC-15181/01	Topographical Survey Plan of Former North Kowloon
	Sheet 3	Magistracy, Tai Po Road, Kowloon
4.	HC-15181/02	Block Plan of Former North Kowloon Magistracy, Tai Po
		Road, Kowloon

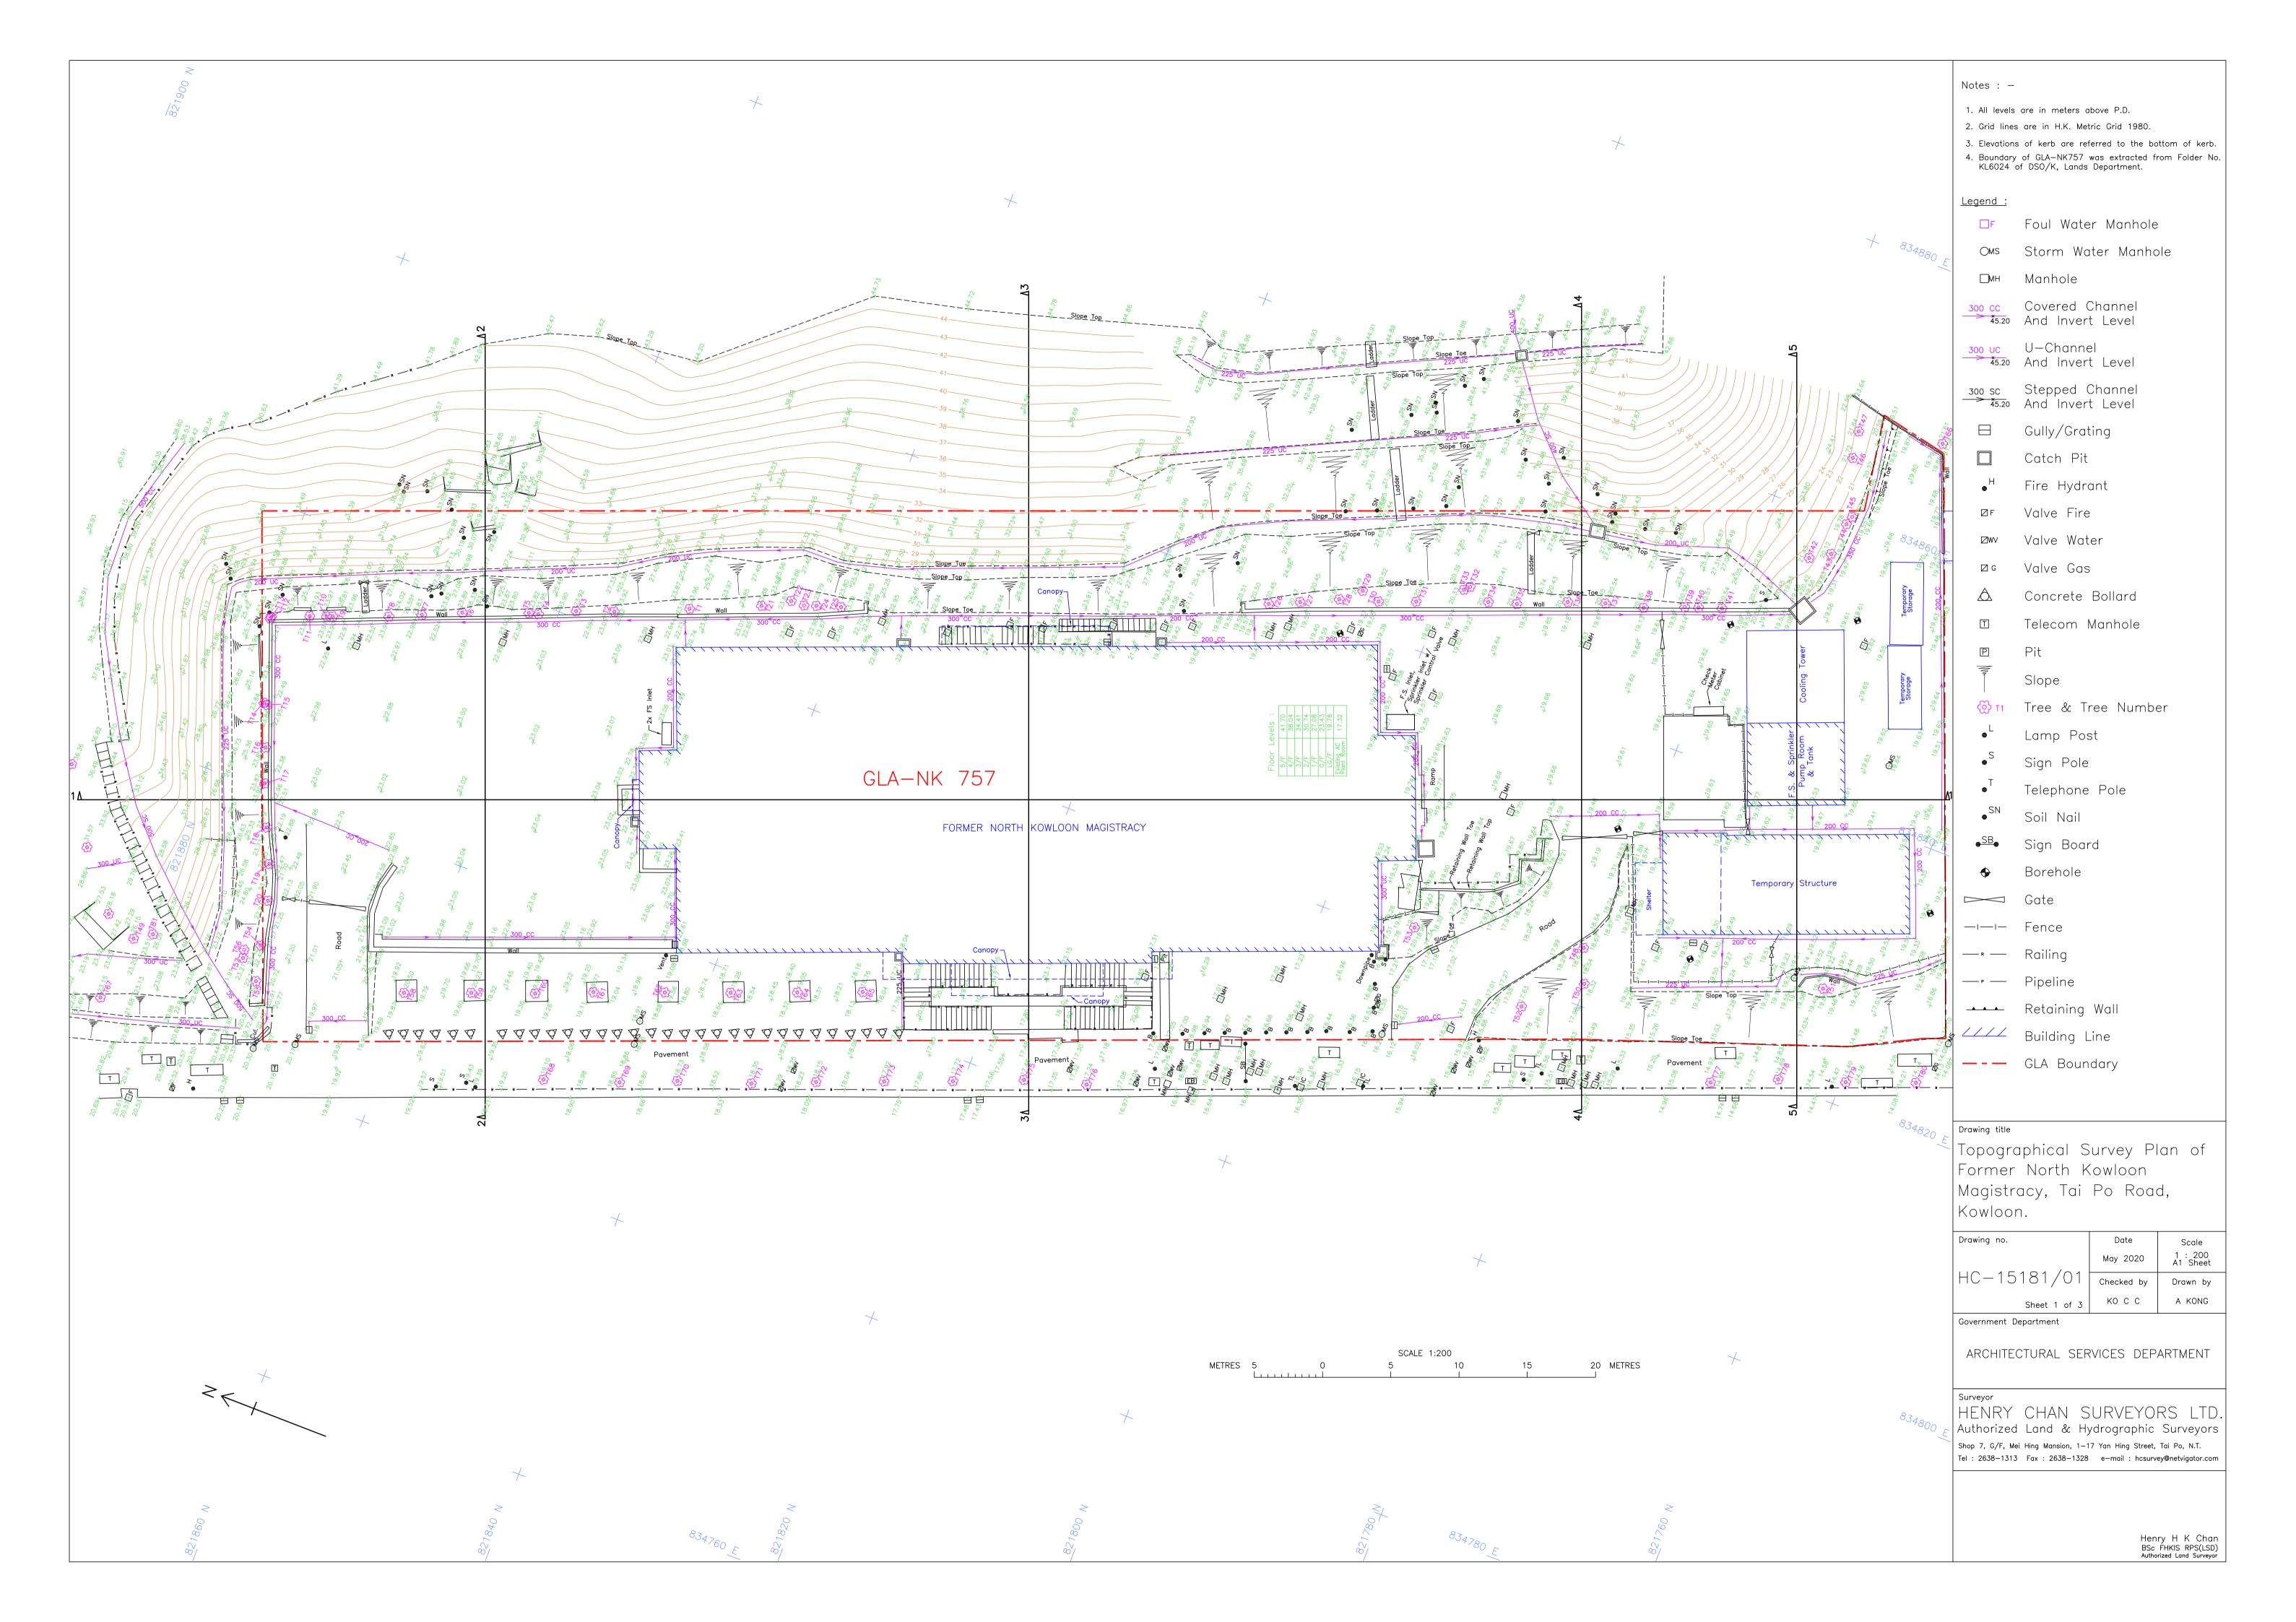

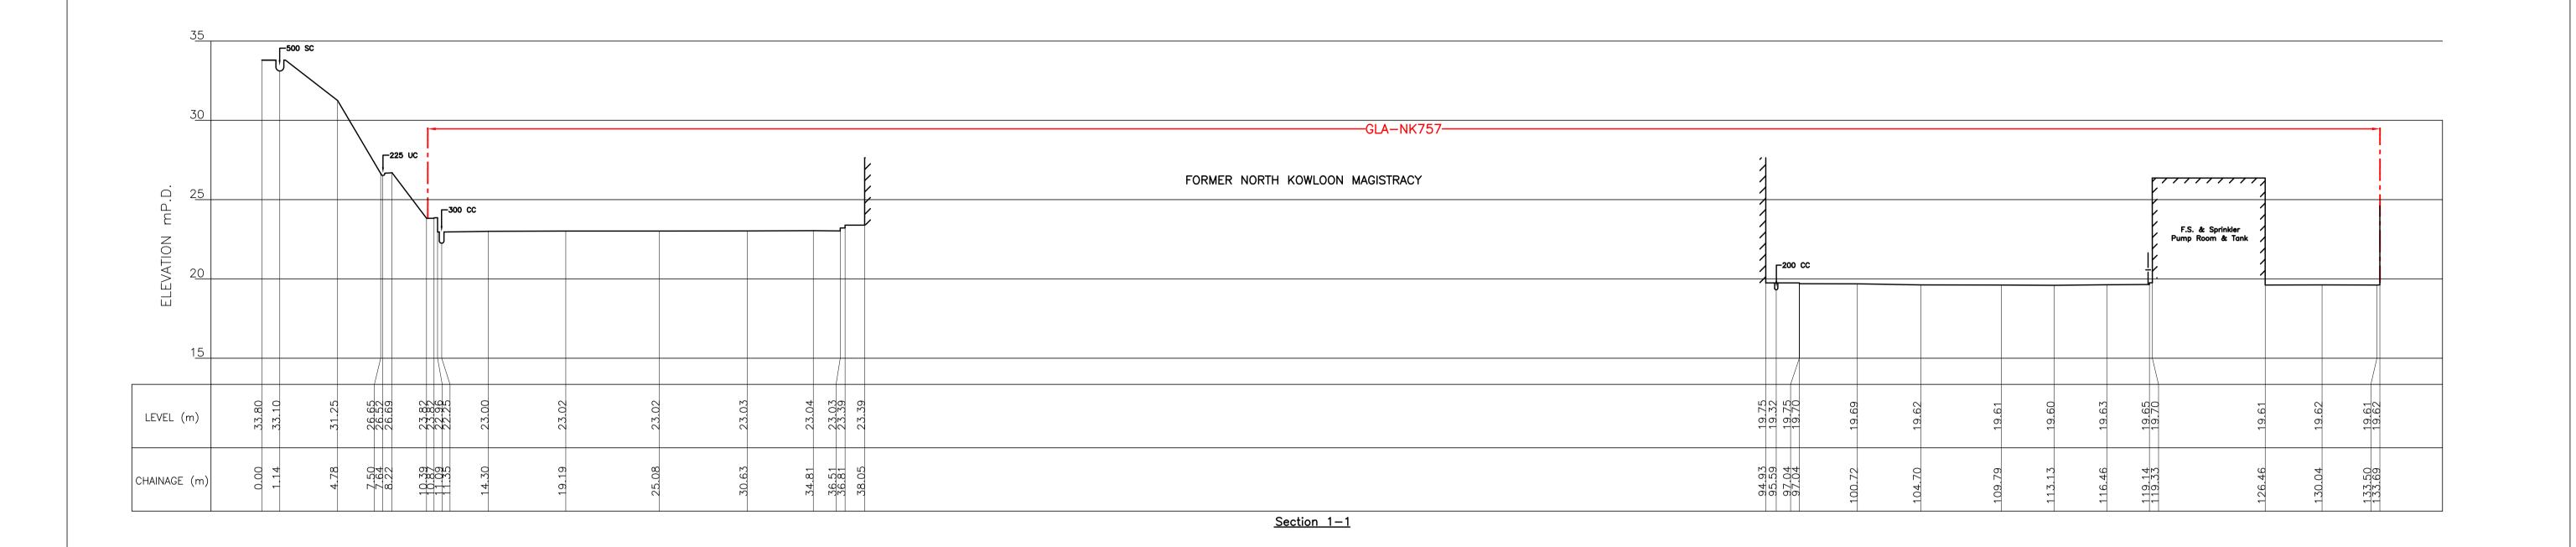

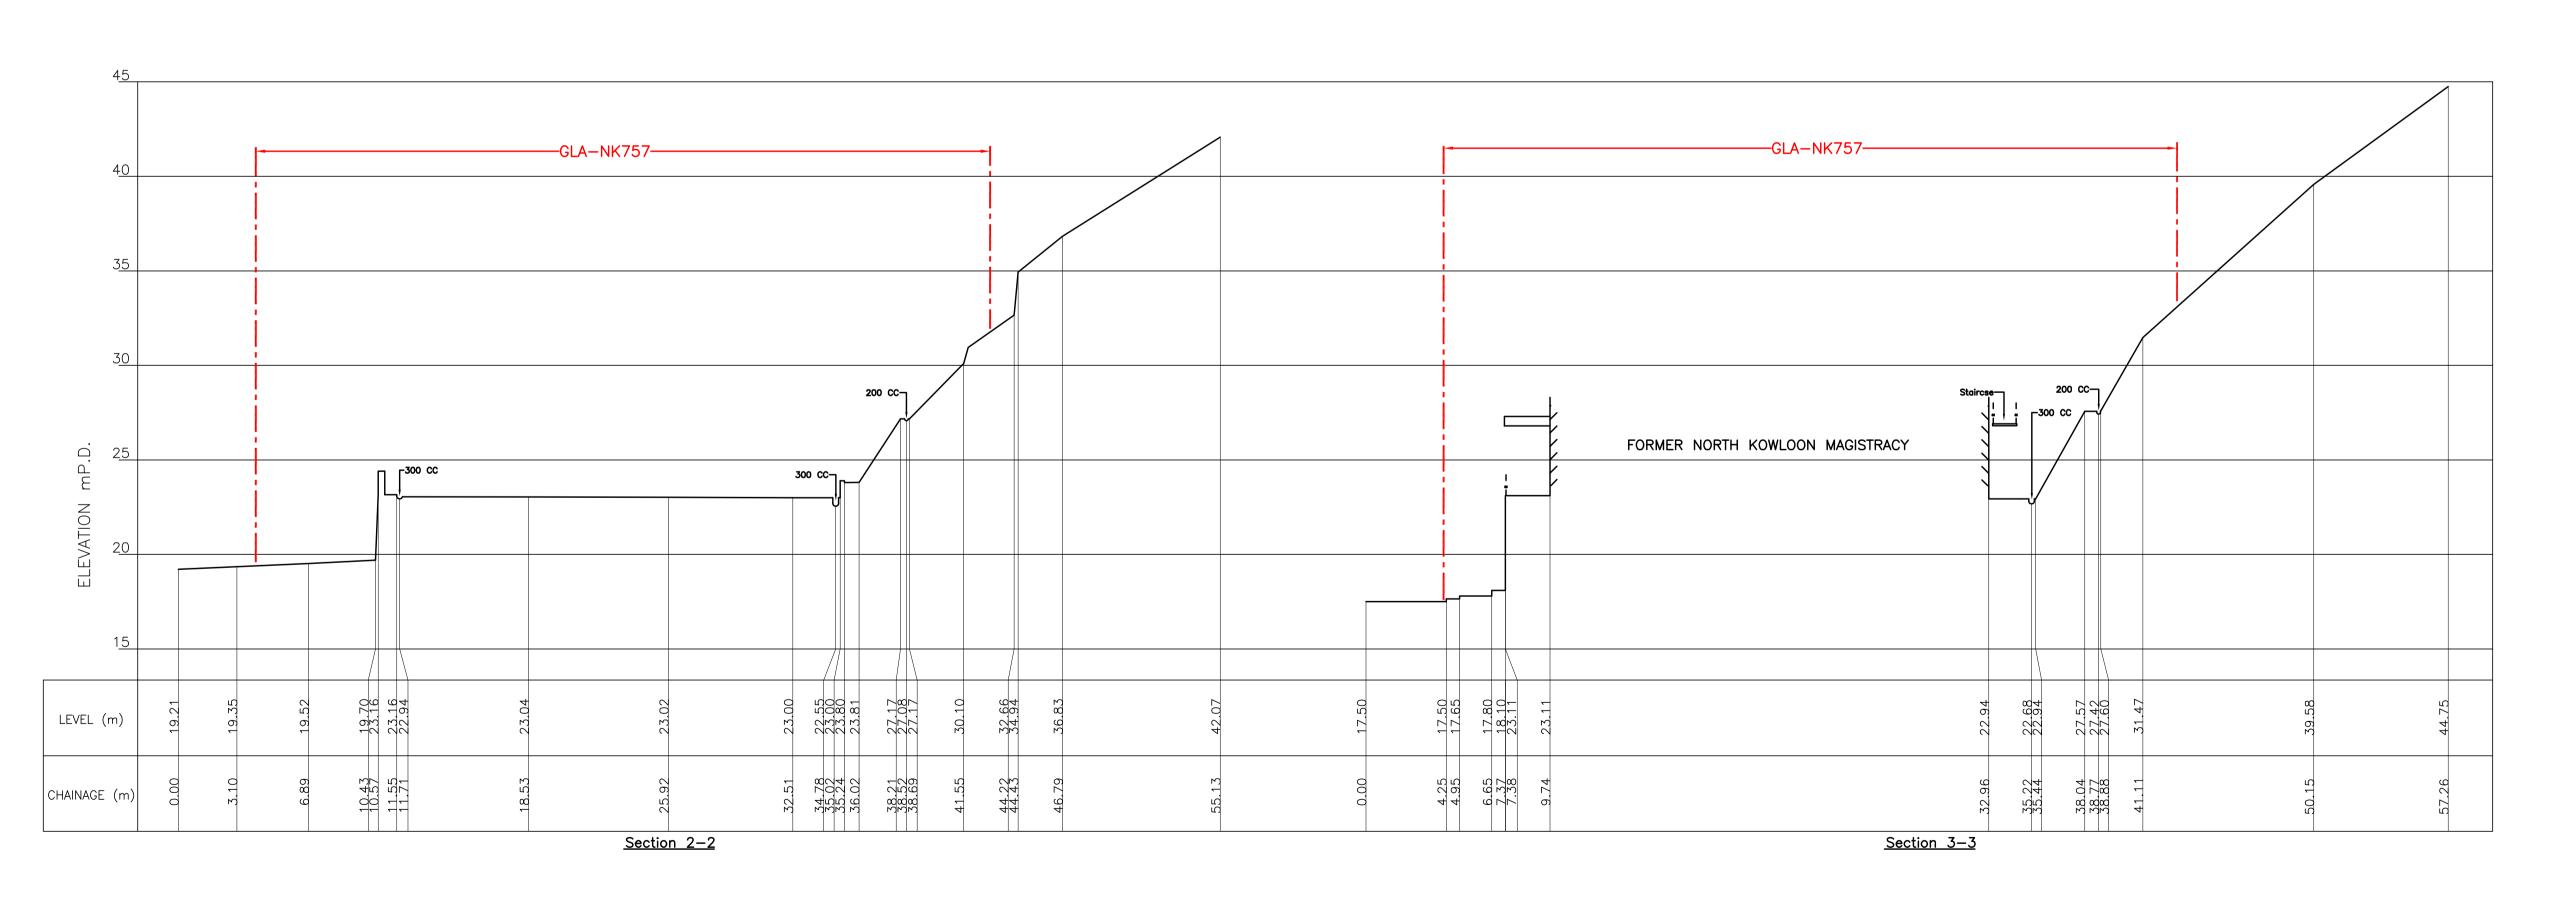



Notes : -

- 1. All levels are in meters above P.D.
- 2. Grid lines are in H.K. Metric Grid 1980.
- 3. Elevations of kerb are referred to the bottom of kerb.
- Boundary of GLA-NK757 was extracted from Folder No. KL6024 of DSO/K, Lands Department.

<u>Legend:</u>

— – — GLA Boundary

Drawing title

Topographical Survey Plan of Former North Kowloon Magistracy, Tai Po Road, Kowloon.


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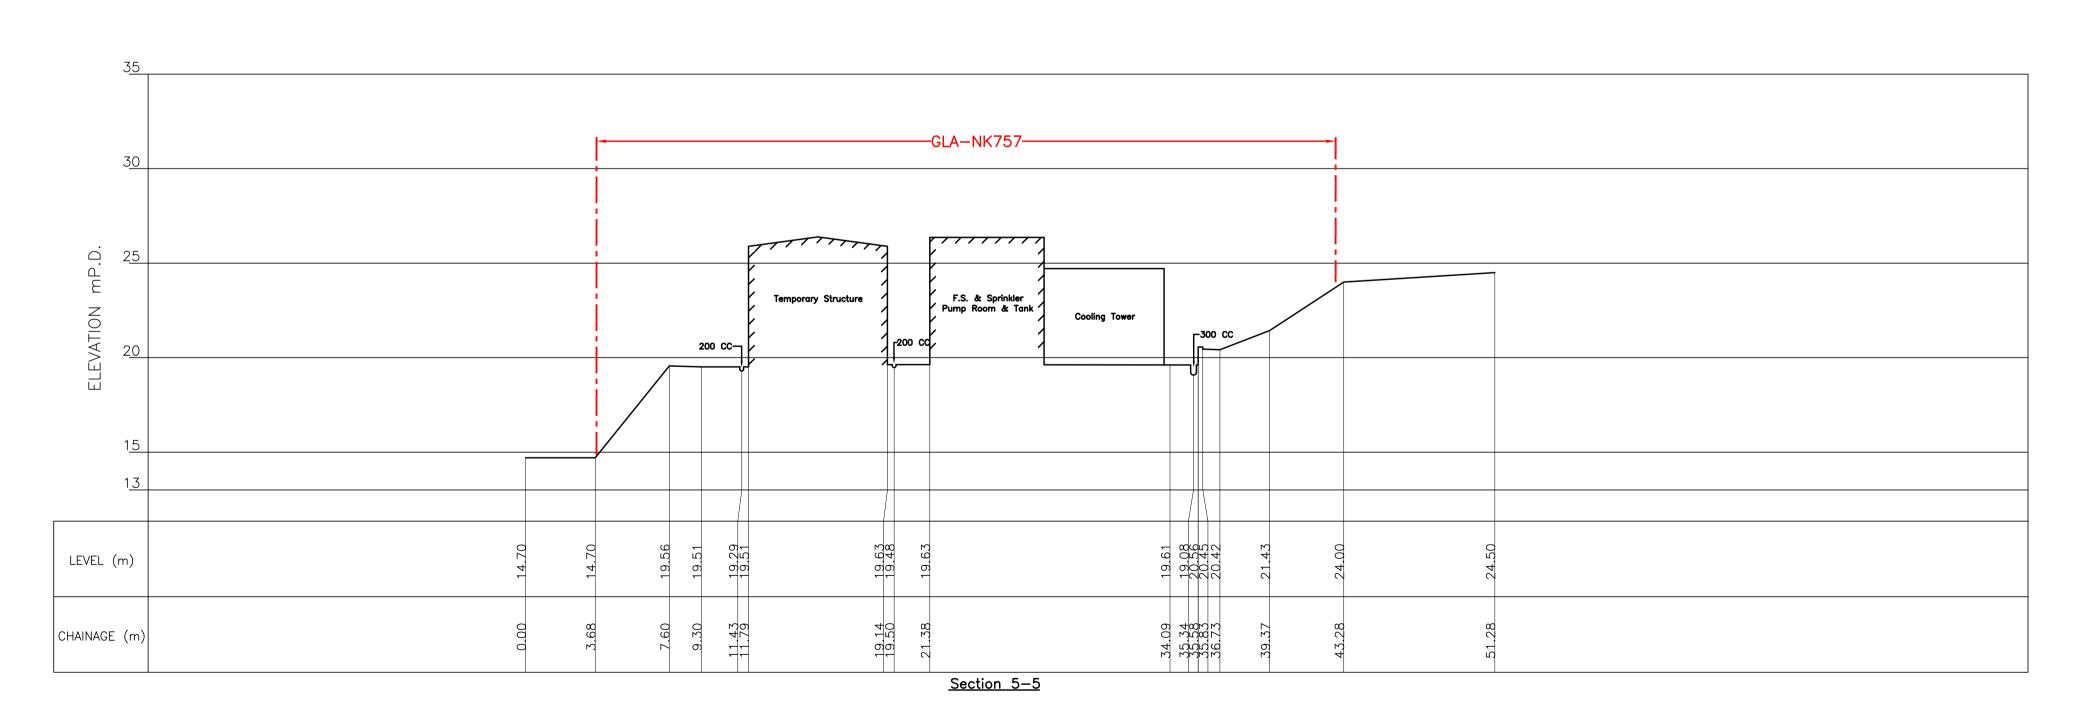
Government Department

ARCHITECTURAL SERVICES DEPARTMENT

HENRY CHAN SURVEYORS LTD. Authorized Land & Hydrographic Surveyors Shop 7, G/F, Mei Hing Mansion, 1—17 Yan Hing Street, Tai Po, N.T. Tel: 2638-1313 Fax: 2638-1328 e-mail: hcsurvey@netvigator.com

Henry H K Chan BSc FHKIS RPS(LSD) Authorized Land Surveyor



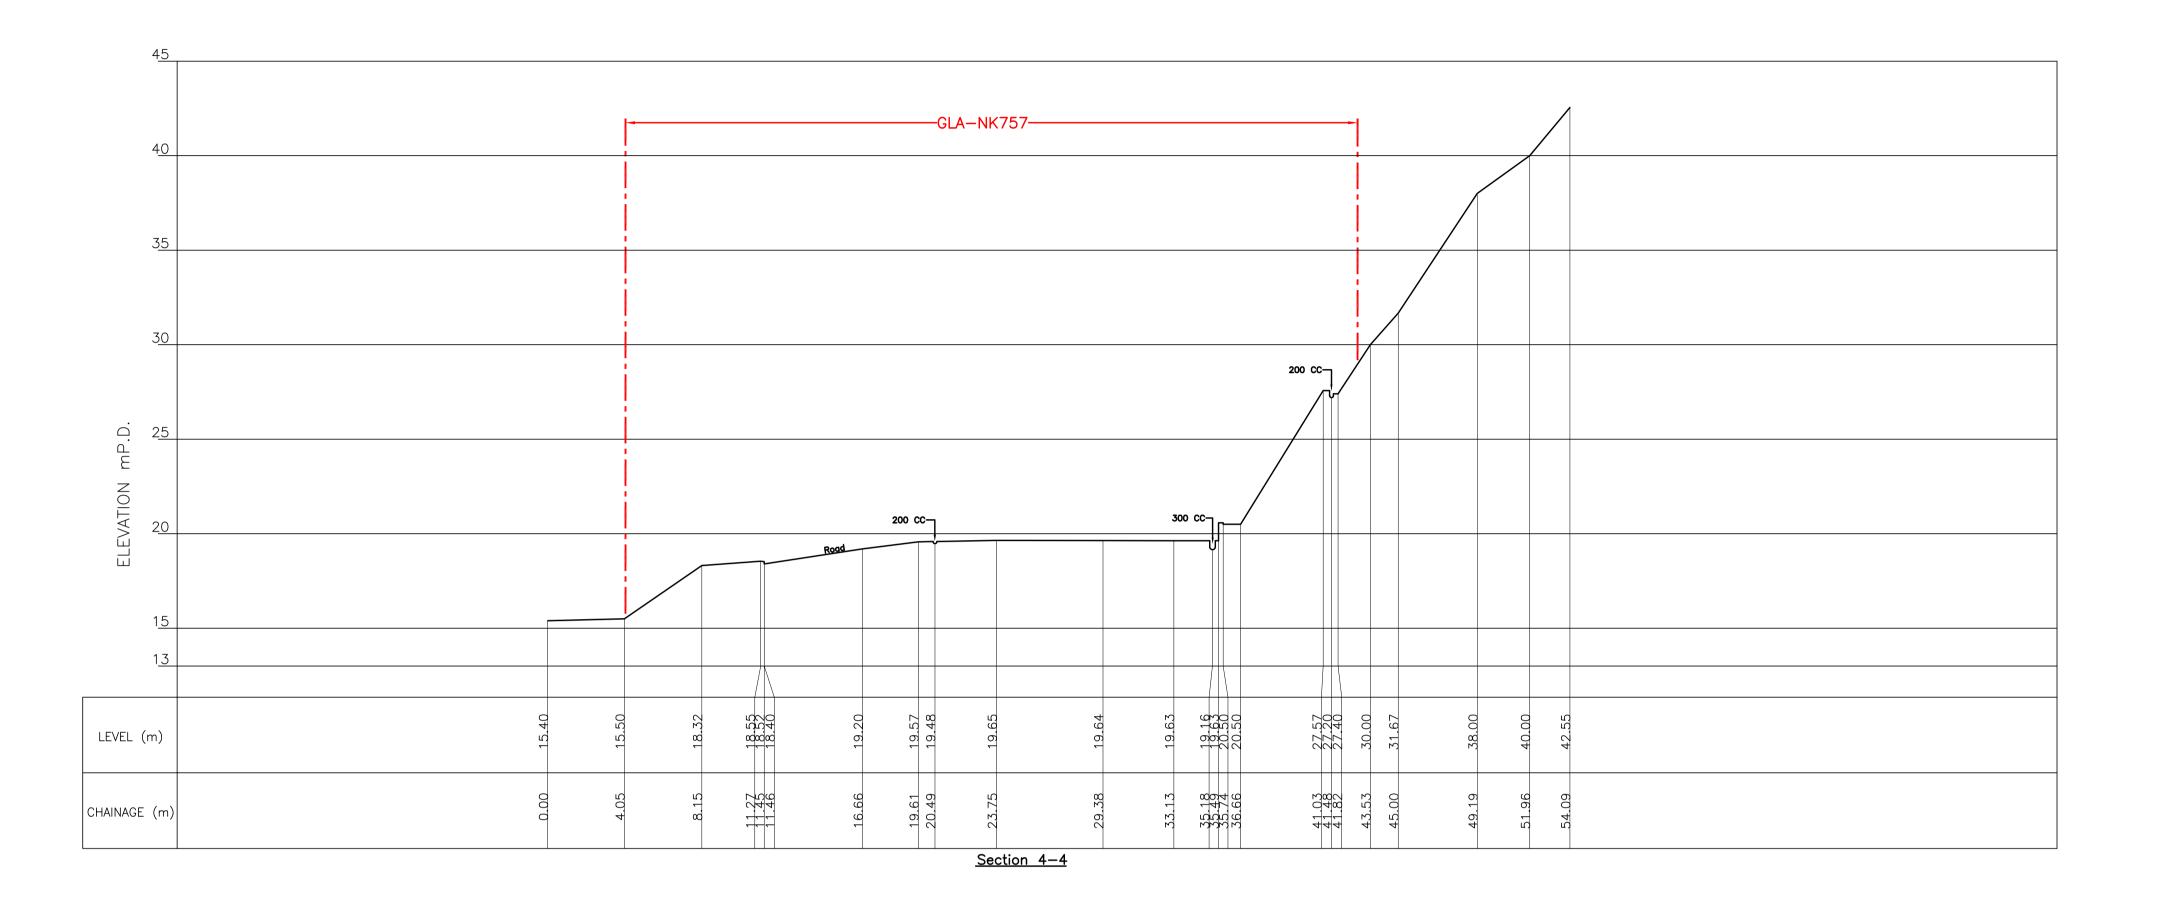



Notes : -

- 1. All levels are in meters above P.D.
- 2. Grid lines are in H.K. Metric Grid 1980.
- 3. Elevations of kerb are referred to the bottom of kerb. Boundary of GLA-NK757 was extracted from Folder No. KL6024 of DSO/K, Lands Department.

<u>Legend</u>:

— - — GLA Boundary

Drawing title

Topographical Survey Plan of Former North Kowloon Magistracy, Tai Po Road, Kowloon.


Drawing no.	Date	Scale
	May 2020	1 : 200 A1 Sheet
HC-15181/01	Checked by	Drawn by
Sheet 3 of 3	косс	A KONG

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Notes : -

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- 1. All levels are in meters above P.D.
- 2. Grid lines are in H.K. Metric Grid 1980.
- 3. Boundary of GLA-NK757 was extracted from Folder No. KL6024 of DSO/K, Lands Department.

<u>Legend</u>:

----- GLA Boundary

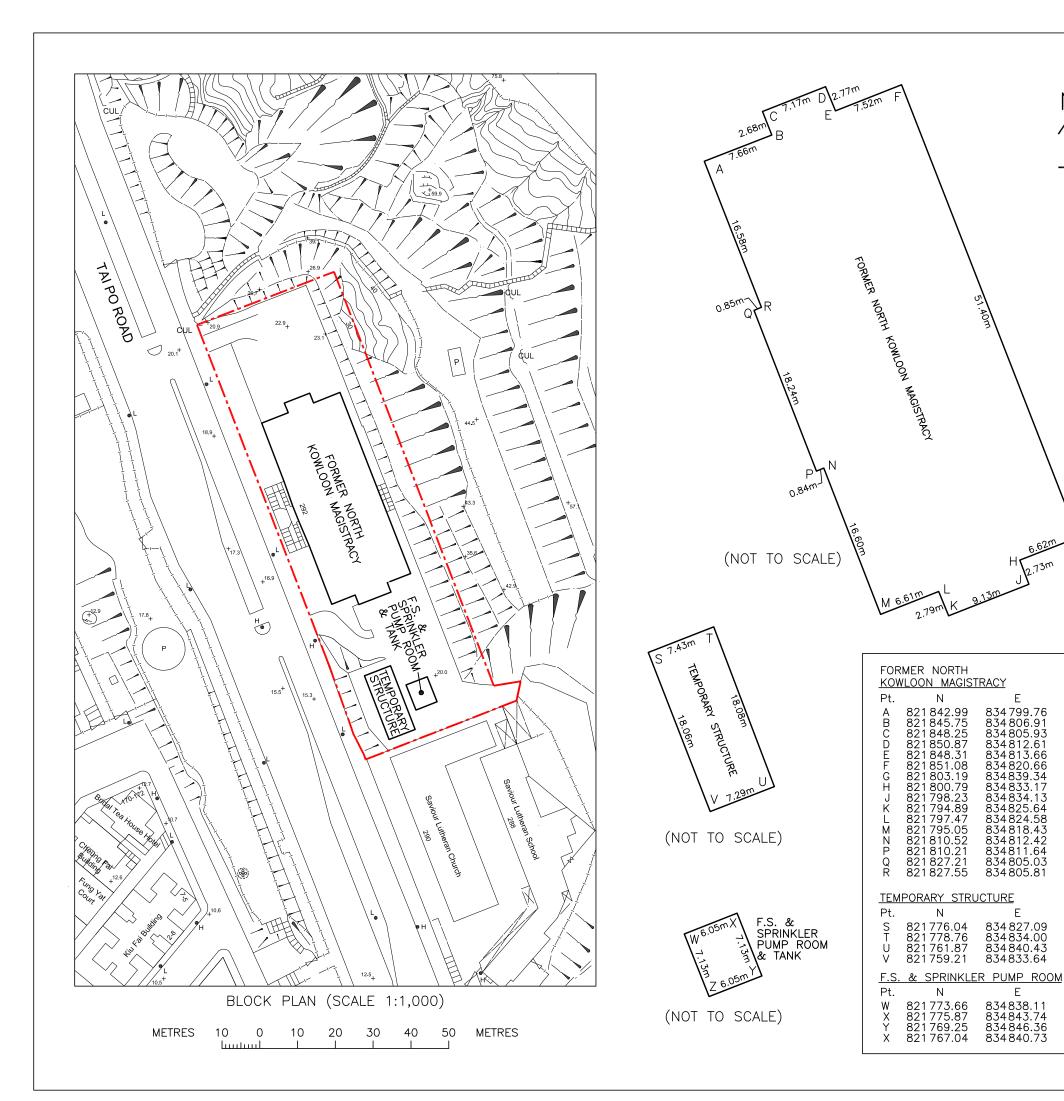Drawing title

Block Plan of
Former North Kowloon
Magistracy, Tai Po Road,
Kowloon.

Drawing no.	Date	Scale
	May 2020	As Shown (A3 Sheet)
HC-15181/02	Checked by	Drawn by
	ко с с	D POON

Government Department

ARCHITECTURAL SERVICES DEPARTMENT

Surveyor

HENRY CHAN SURVEYORS LTD.
Authorized Land & Hydrographic Surveyors
Shop 7, G/F, Mei Hing Mansion, 1-17 Yan Hing Street, Tai Po, N.T.
Tel: 2638-1313 Fax: 2638-1328 e-mail: hcsurvey@netvigator.com


Henry H K Chan BSc FHKIS RPS(LSD) Authorized Land Surveyor


Appendix VI(E)


Underground Utilities Survey Plans

Appendix VI(E) – Underground Utilities Survey Drawings <u>Drawing List</u>


	Drawing No.	Drawing Title
1.	FS/SPJ-168-	Underground Utilities Survey Drawing at Former North
	20/US001	Kowloon Magistracy
2.	FS/SPJ-168-	Underground Utilities Survey Drawing at Former North
	20/US002	Kowloon Magistracy
3.	FS/SPJ-168-	Underground Utilities Survey Drawing at Former North
	20/US003	Kowloon Magistracy
4	FS/SPJ-168-	Underground Utilities Survey Drawing at Former North
	20/US004	Kowloon Magistracy
5	FS/SPJ-168-	Underground Utilities Survey Drawing at Former North
	20/US005	Kowloon Magistracy
6	FS/SPJ-168-	Underground Utilities Survey Drawing at Former North
	20/US006	Kowloon Magistracy

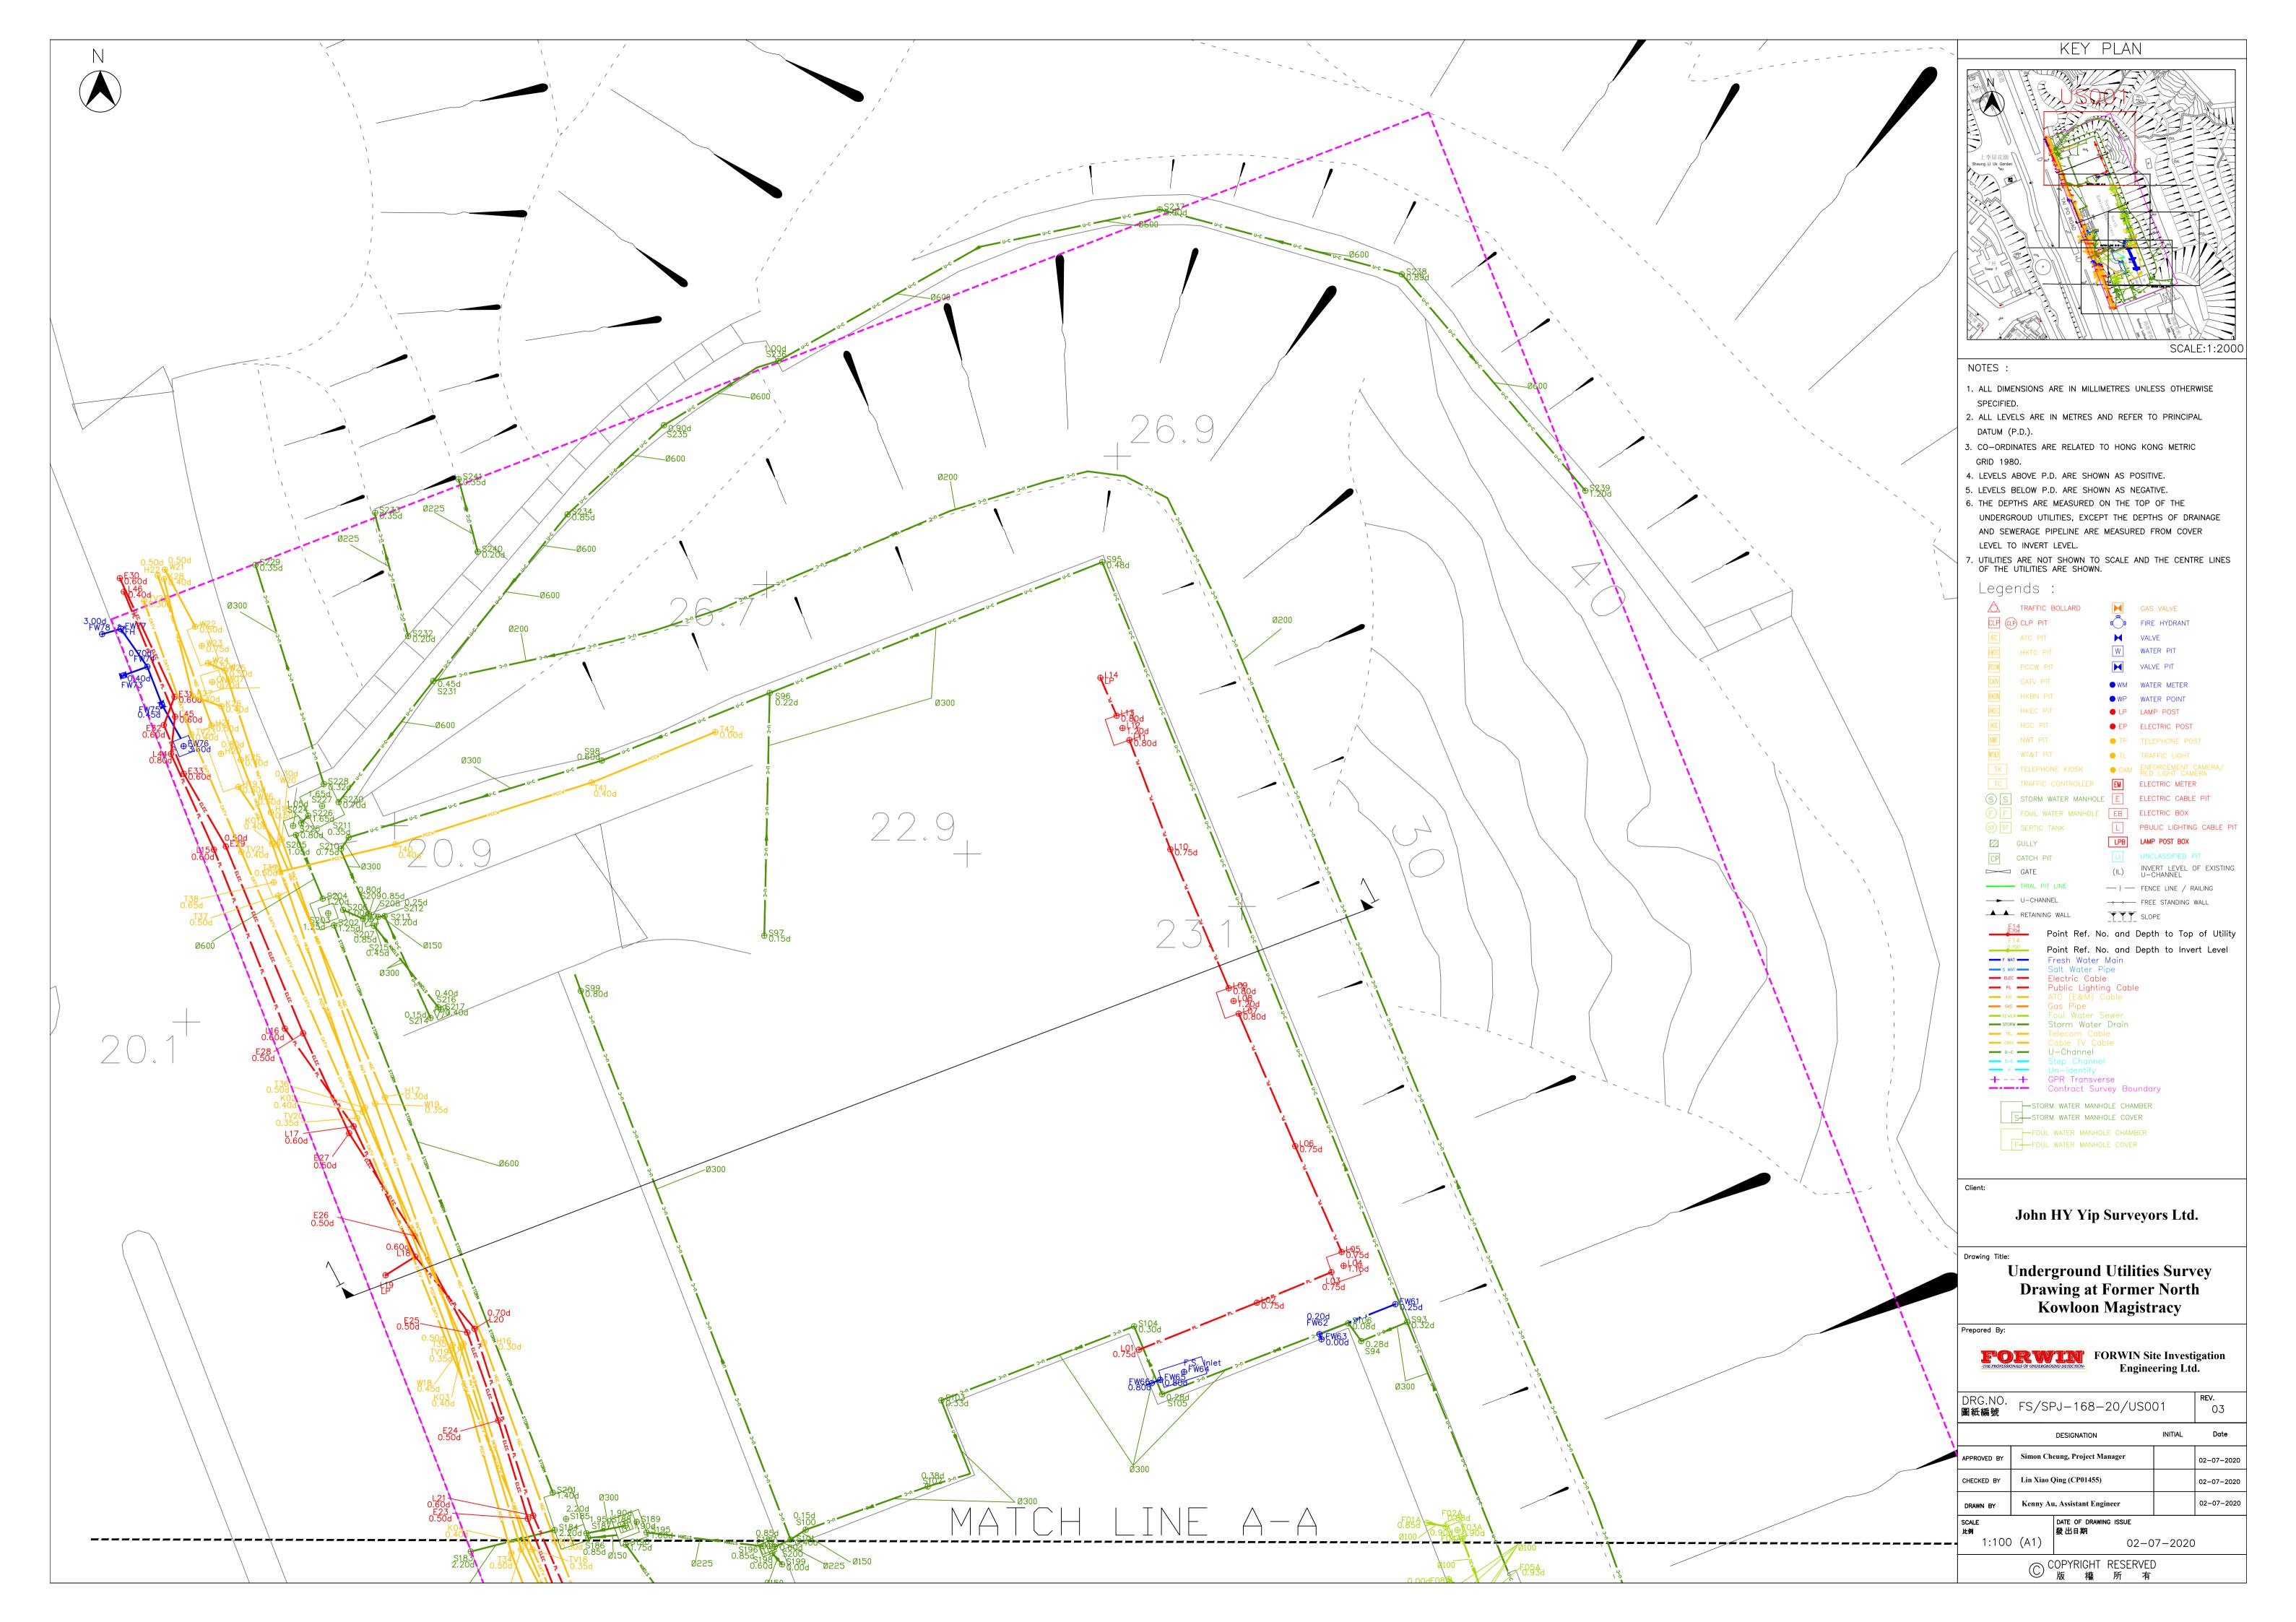


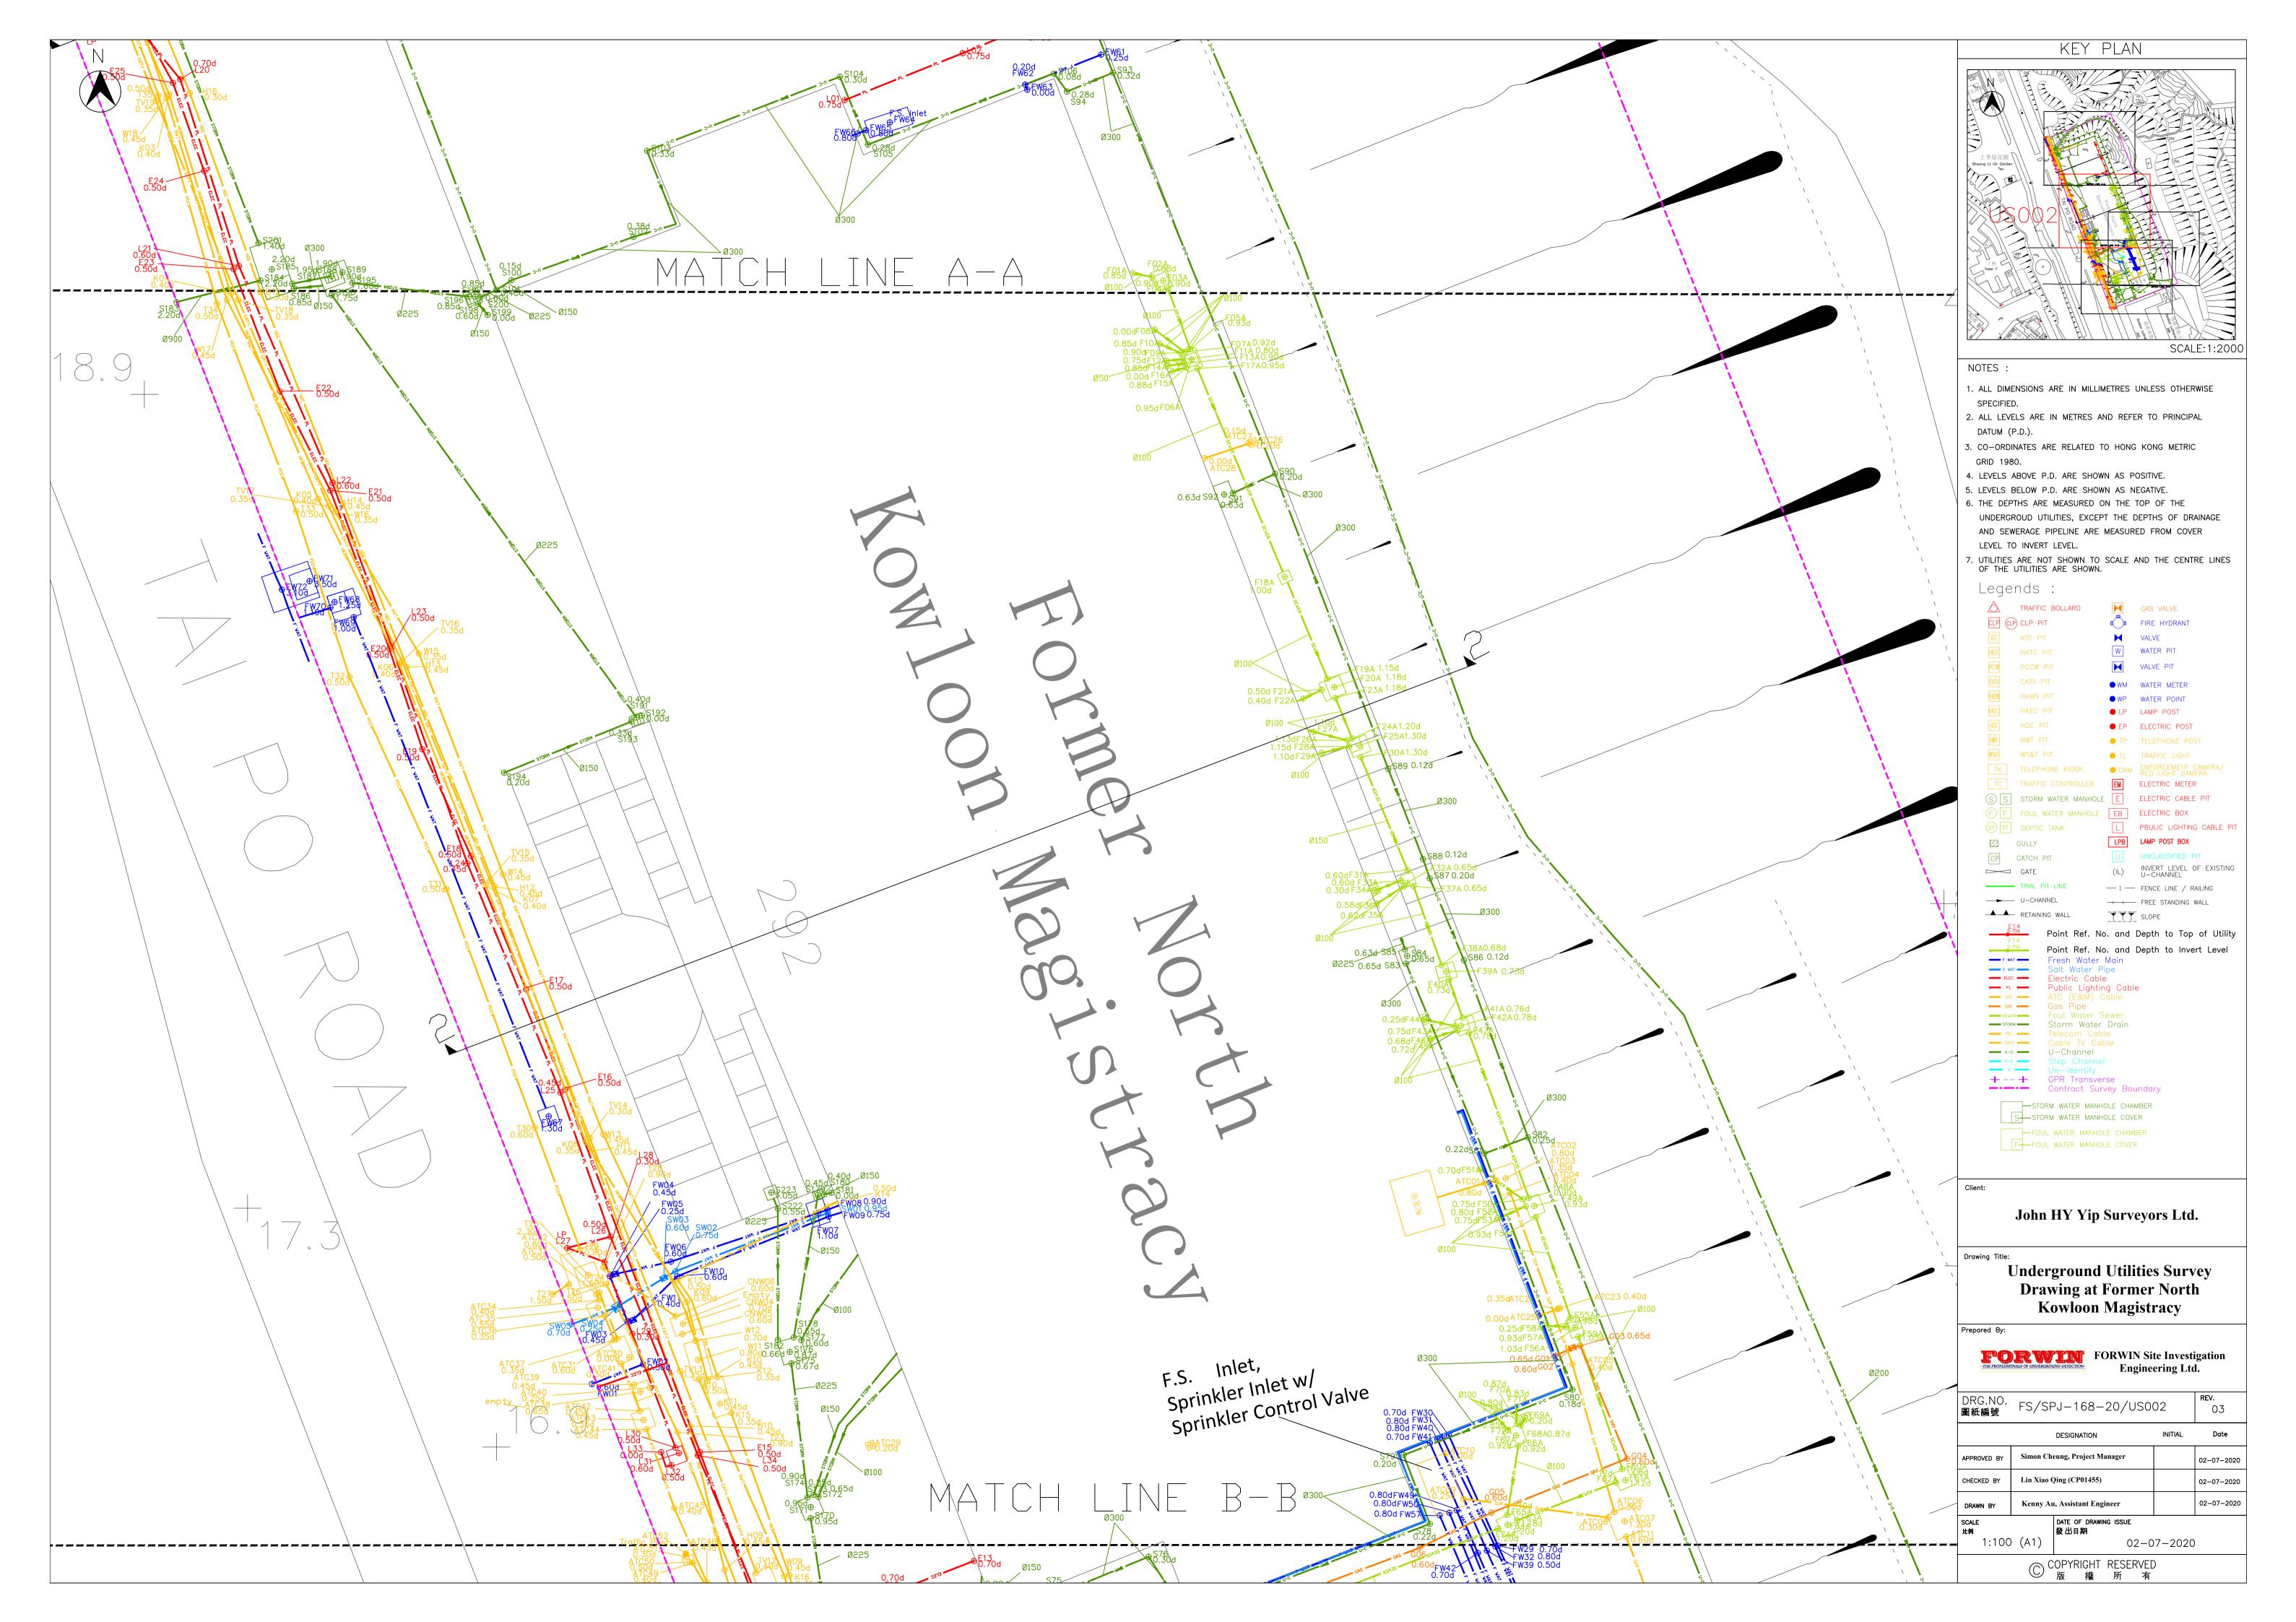

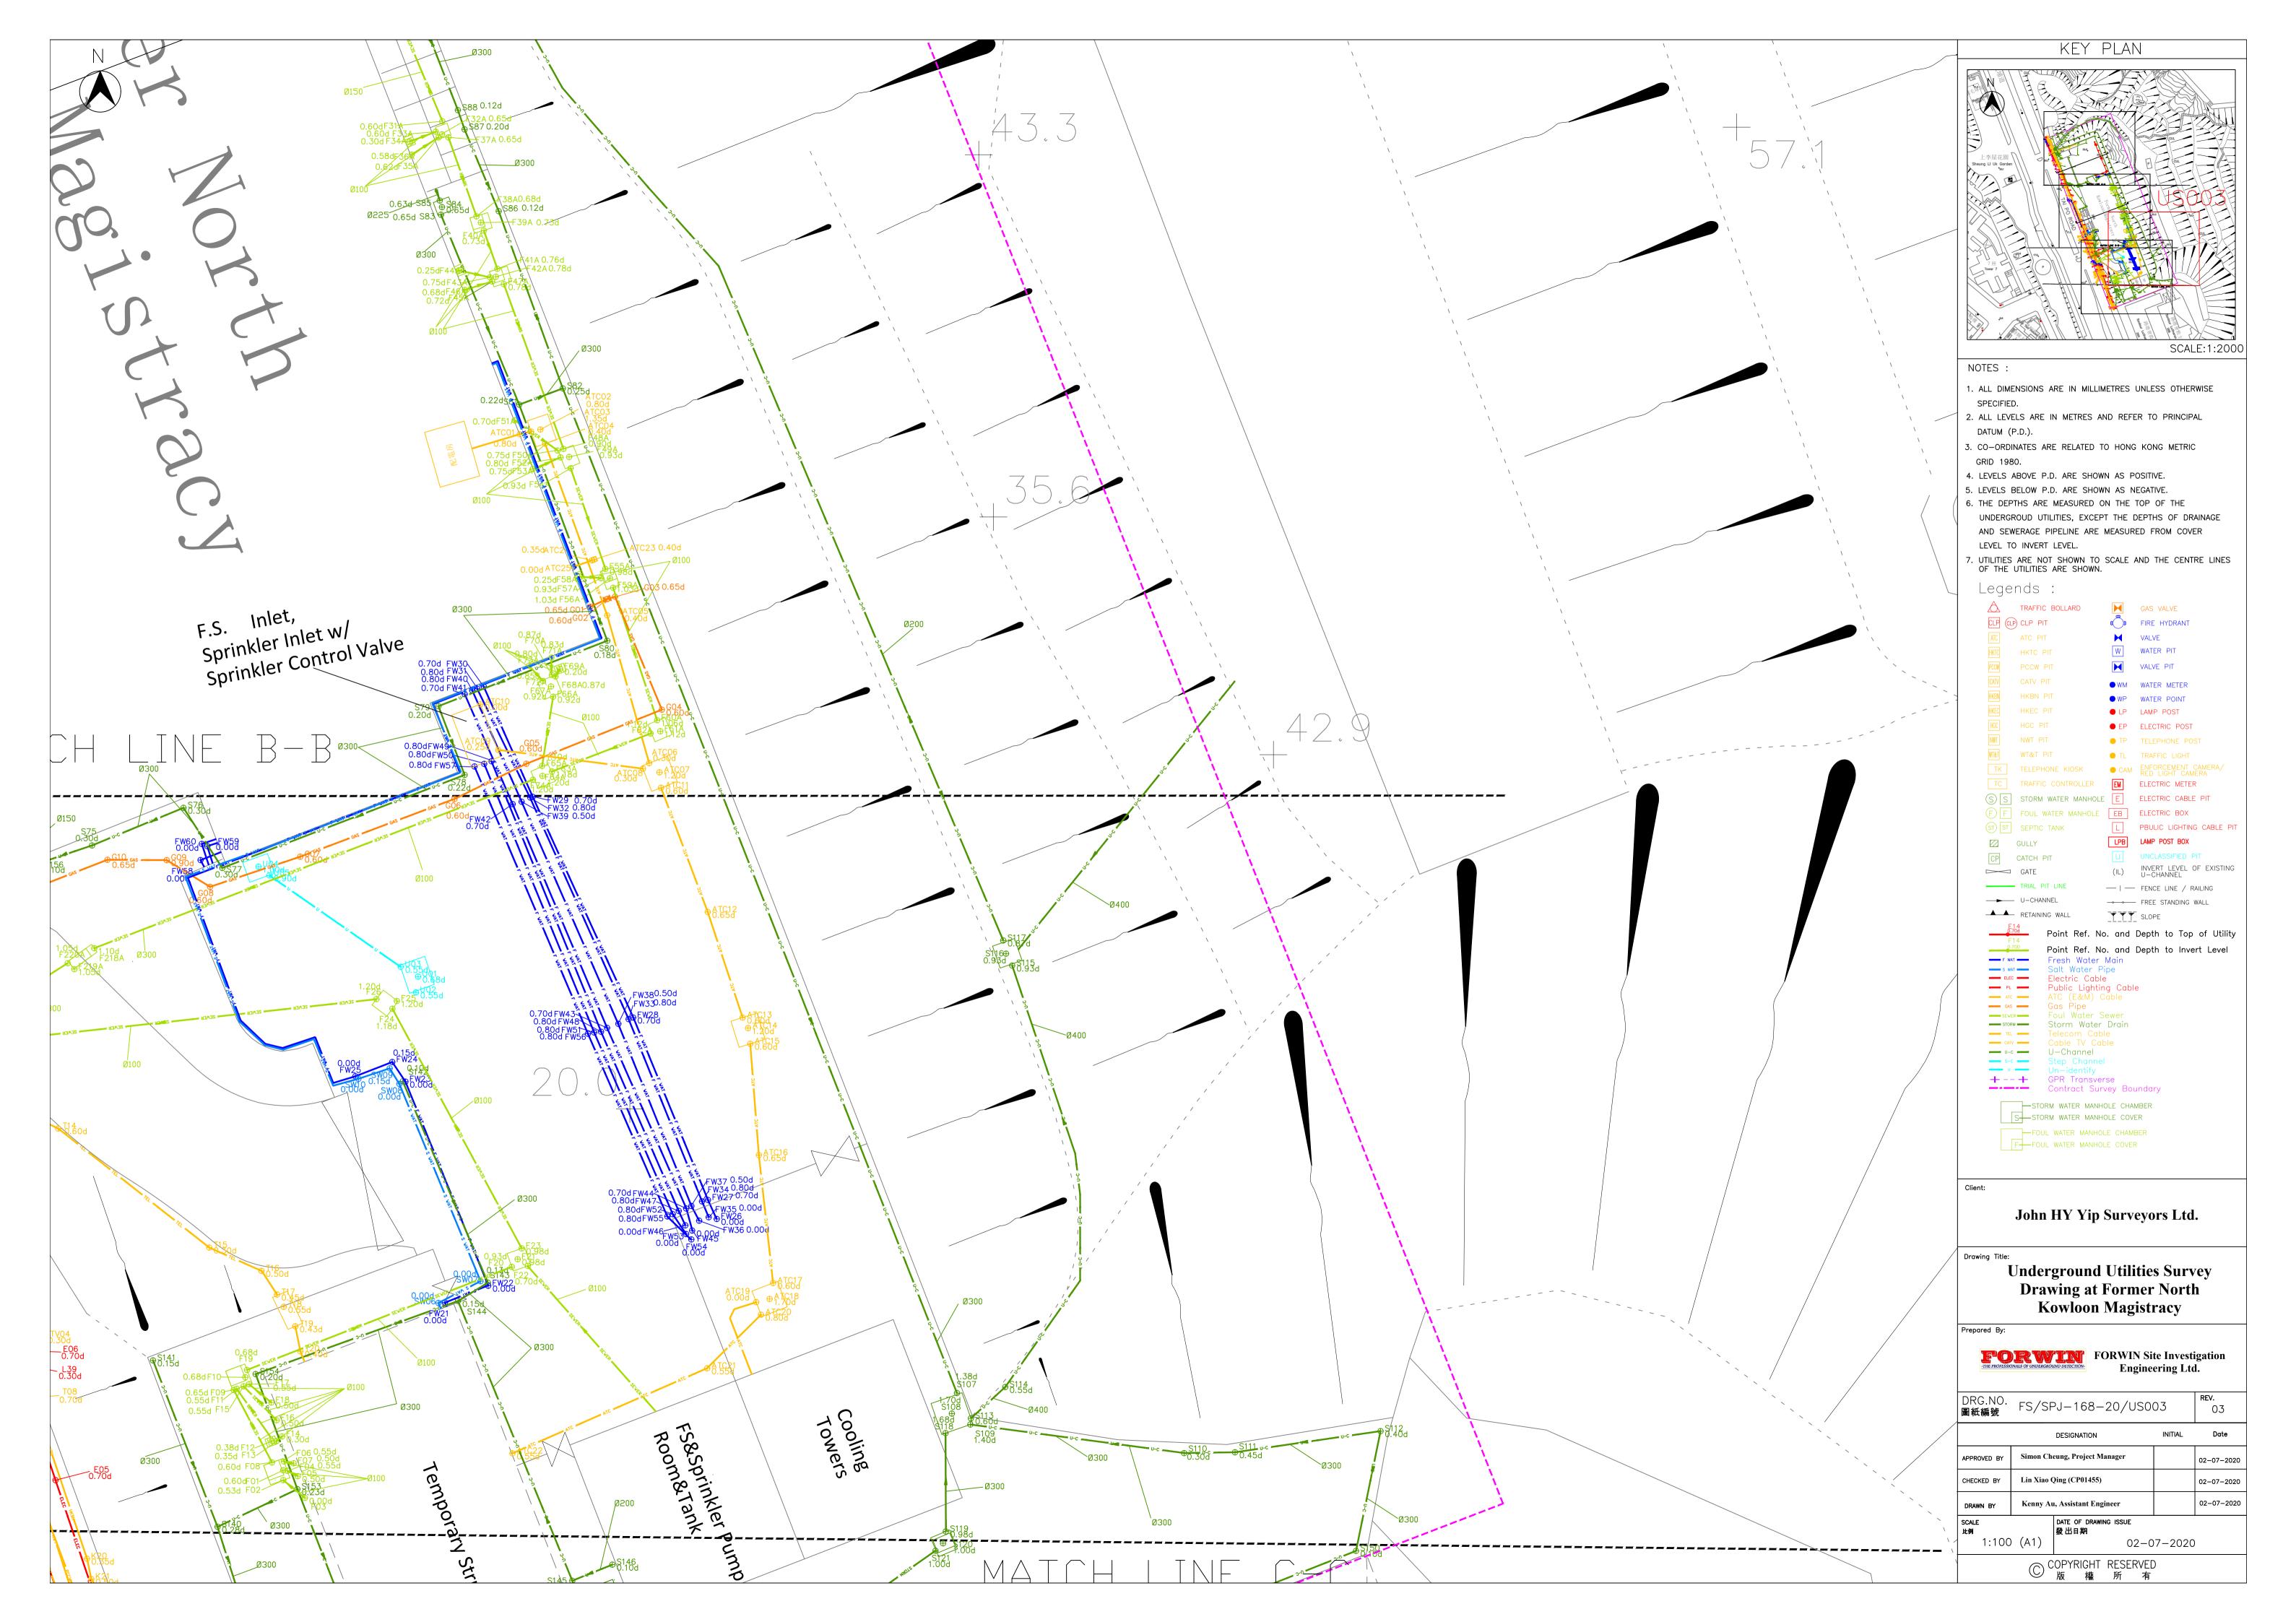



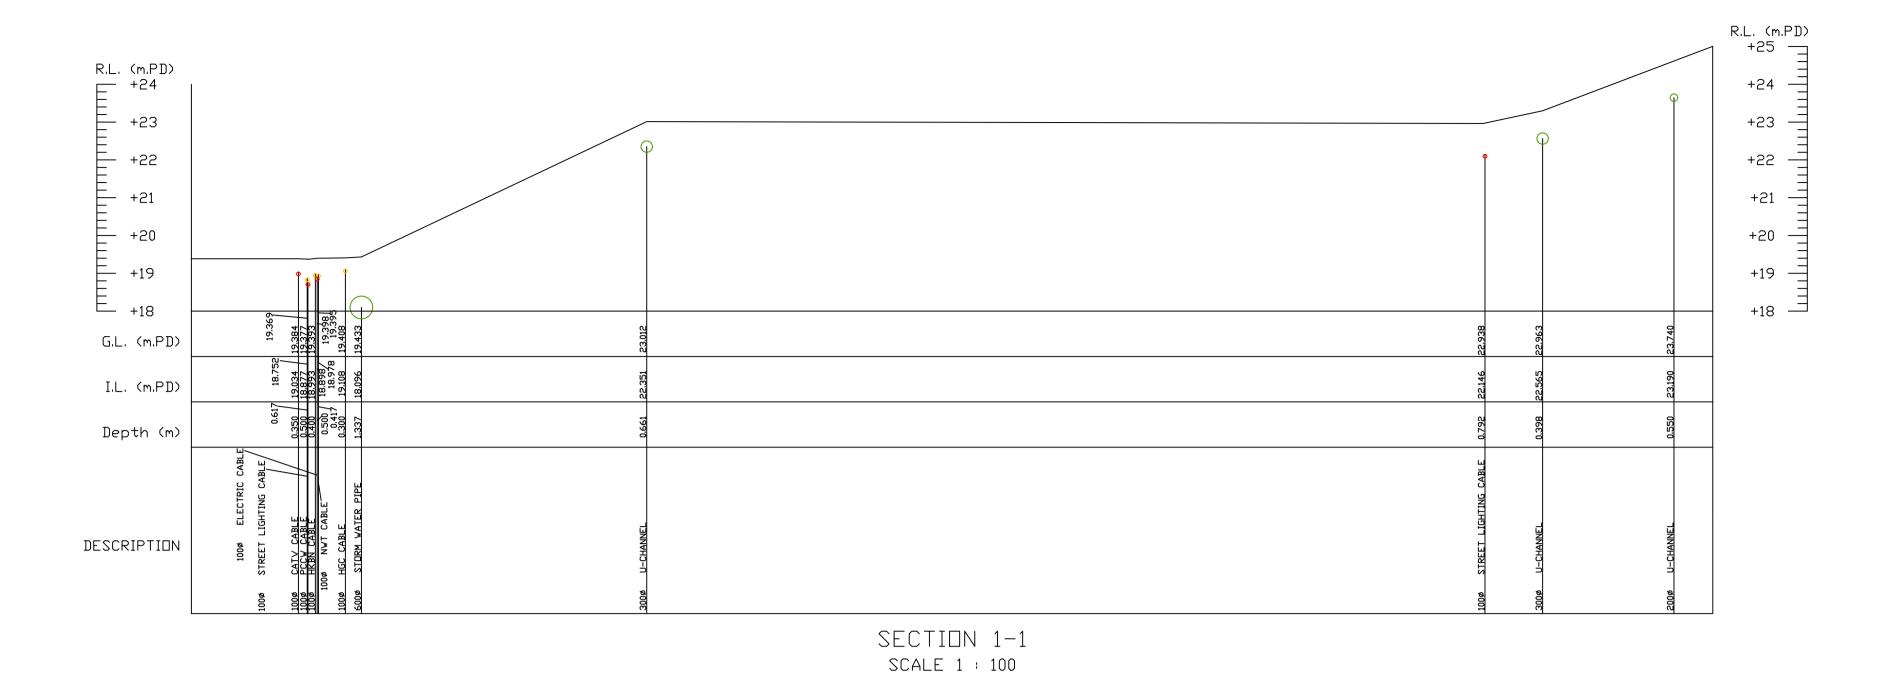

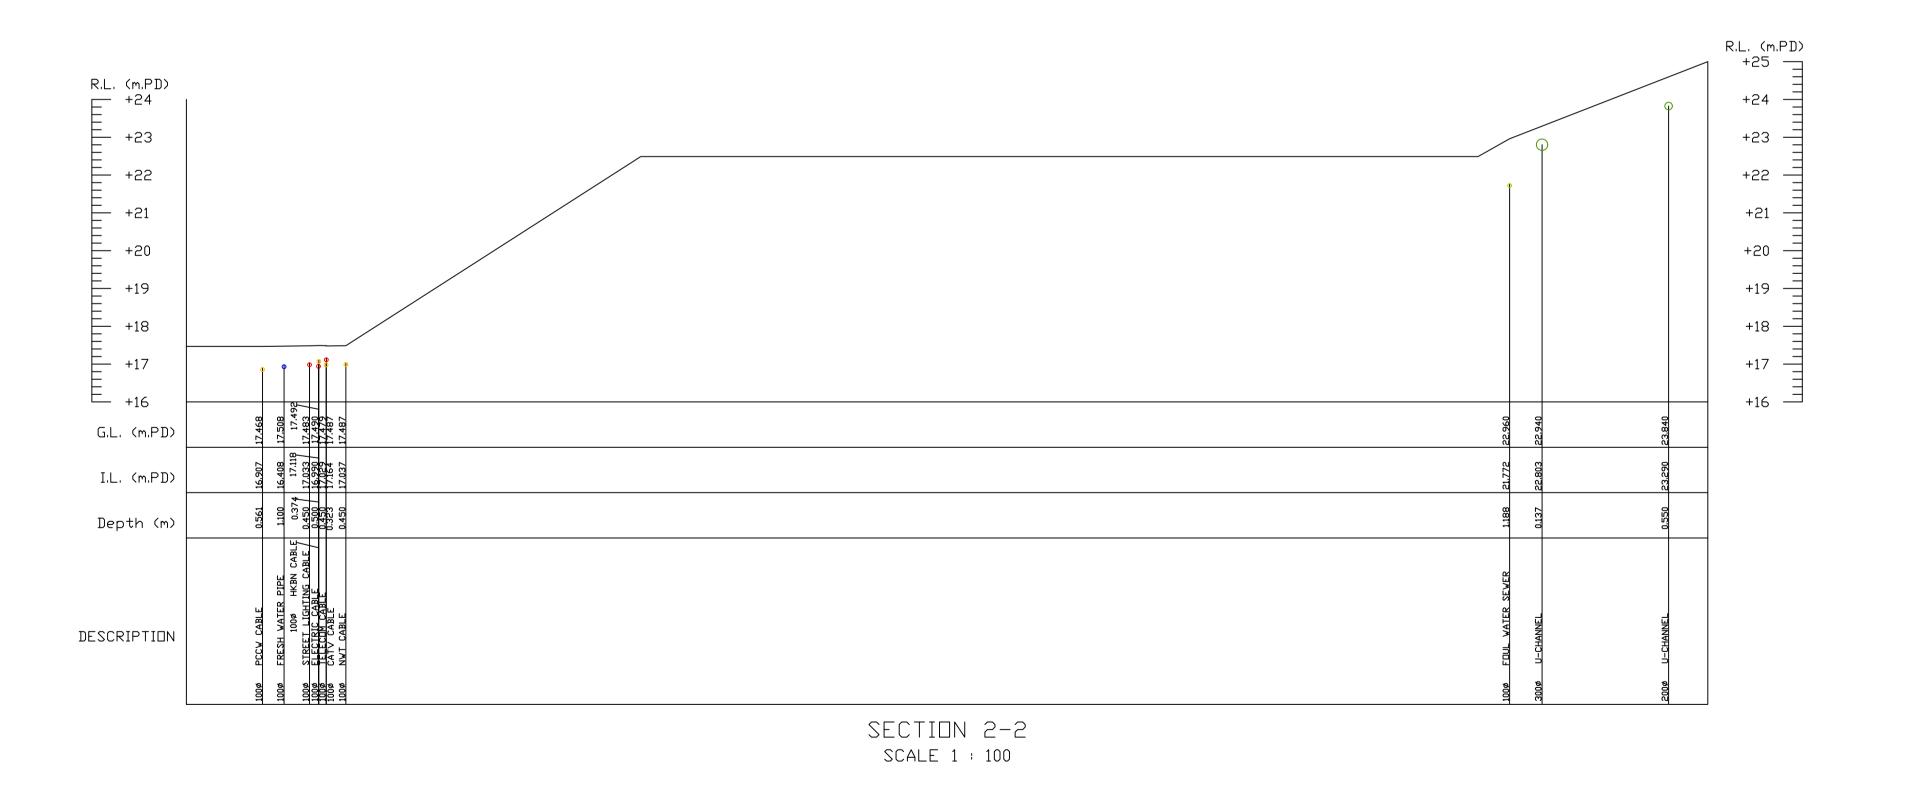

KEY PLAN NOTES: 1. ALL DIMENSIONS ARE IN MILLIMETRES UNLESS OTHERWISE 2. ALL LEVELS ARE IN METRES AND REFER TO PRINCIPAL DATUM (P.D.). 3. CO-ORDINATES ARE RELATED TO HONG KONG METRIC GRID 1980. 4. LEVELS ABOVE P.D. ARE SHOWN AS POSITIVE. 5. LEVELS BELOW P.D. ARE SHOWN AS NEGATIVE. 6. THE DEPTHS ARE MEASURED ON THE TOP OF THE UNDERGROUD UTILITIES, EXCEPT THE DEPTHS OF DRAINAGE AND SEWERAGE PIPELINE ARE MEASURED FROM COVER LEVEL TO INVERT LEVEL. 7. UTILITIES ARE NOT SHOWN TO SCALE AND THE CENTRE LINES OF THE UTILITIES ARE SHOWN. Legends : TRAFFIC BOLLARD GAS VALVE CLP (CLP) CLP PIT FIRE HYDRANT **∨** VALVE W WATER PIT HKTC PIT PCCW PIT VALVE PIT ● WM WATER METER HKBN HKBN PIT WP WATER POINT LP LAMP POST ● EP ELECTRIC POST NWT PIT TP TELEPHONE POST WT&T PIT S S STORM WATER MANHOLE E ELECTRIC CABLE PIT F F FOUL WATER MANHOLE EB ELECTRIC BOX ST SEPTIC TANK GULLY CP CATCH PIT GATE ----- TRIAL PIT LINE --- | --- FENCE LINE / RAILING —► U-CHANNEL ---- FREE STANDING WALL TTT SLOPE RETAINING WALL Point Ref. No. and Depth to Top of Utility Point Ref. No. and Depth to Invert Level S WAT ELEC -Electric Cable — Public Lighting Cable → ATC (E&M) Cable ─ GAS ─ Gas Pipe ´ ──storm ── Storm Water Drain TEL Telecom Cable
Cable TV Cable **—** ∪-c **—** U-Channel + -- + GPR Transverse Contract Survey Boundary STORM WATER MANHOLE CHAMBER S-STORM WATER MANHOLE COVER FOUL WATER MANHOLE CHAMBER
FFOUL WATER MANHOLE COVER John HY Yip Surveyors Ltd. Drawing Title: **Underground Utilities Survey Drawing at Former North** Kowloon Magistracy Prepared By: FORWIN Site Investigation Engineering Ltd. REV. 03 DRG.NO. FS/SPJ-168-20/US005 圖紙編號 Date DESIGNATION INITIAL APPROVED BY Simon Cheung, Project Manager 02-07-2020 CHECKED BY Lin Xiao Qing (CP01455) 02-07-2020 02-07-2020 Kenny Au, Assistant Engineer DRAWN BY SCALE 比例 DATE OF DRAWING ISSUE 發出日期 1:100 (A1) 02-07-2020

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		. 1		r Main (FW)		
	Point	Depth (m)	Diameter/ Dimension (mm)	Northing	Easting	G.L.(mPl
	FW01	0.60	100	821803.252	834803.714	16.71
	FW02	0.50	100	821803.975	834805.583	16.87
	FW03	0.45	100	821805.544	834805.016	16.95
	FW04	0.45	100	821807.197	834804.373	17.01
*	FW05	0.25	180X180	821807.278	834804.562	17.01
	FW06	0.60	100	821807.736	834806.606	17.05
#	FW07	1.10	650X900	821809.521	834811.994	17.24
	FW08	0.90	100	821809.631	834812.337	17.28
	FW09	0.75	100	821809.387	834812.378	17.28
*	FW10 FW11	0.60	100	821807.198	834806.835	17.05
	FW12	0.40	180X180 100	821805.590 821787.485	834805.204 834809.945	16.96 15.83
*	FW13	0.10	300X300	821787.604	834810.087	15.85
	FW14	0.70	100	821787.952	834811.746	15.89
*	FW15	0.50	300X300	821786.739	834812.307	15.81
	FW16	0.50	100	821786.277	834812.519	15.79
*	FW17	0.30	300X300	821785.859	834813.049	15.77
	FW18	0.40	80	821785.293	834813.387	15.77
*	FW19	0.15	280X200	821785.591	834814.343	15.81
@	FW20	exposed	-	821785.937	834815.002	15.87
	FW21	exposed	25	821778.804	834833.683	19.19
	FW22	exposed	25	821779.422	834835.267	19.60
	FW23	exposed	25	821786.897	834832.236	19.62
	FW24	0.15	25	821787.617	834831.753	19.67
	FW25	exposed	25	821787.094	834830.403	19.66
	FW26	exposed	50	821781.868	834843.639	19.61
	FW27	0.70	50 50	821782.563	834843.318 834840.576	19.62
	FW28 FW29	0.70	50	821789.245 821797.331	834836.896	19.66 19.63
	FW30	0.70	50	821801.361	834835.106	19.50
	FW31	0.80	300	821801.386	834834.865	19.49
	FW32	0.80	300	821797.304	834836.809	19.61
	FW33	0.80	300	821789.187	834840.411	19.65
	FW34	0.80	300	821782.512	834843.099	19.63
	FW35	exposed	300	821781.932	834843.344	19.61
	FW36	exposed	300	821781.805	834842.994	19.61
	FW37	0.50	300	821782.344	834842.711	19.62
	FW38	0.50	300	821789.016	834840.035	19.64
	FW39	0.50	300	821797.149	834836.492	19.63
	FW40	0.80	300	821801.230	834834.682	19.49
	FW41	0.70	300	821801.089	834834.408	19.47
	FW42	0.70	300	821797.062	834836.162	
	FW43	0.70	300	821788.867	834839.622	19.64
_	FW44	0.70	300	821782.252	834842.520	19.62
	FW45 FW46	exposed exposed	300 150	821781.443 821781.635	834842.738 834842.488	19.61 19.61
	FW47	0.80	150	821781.033	834842.246	19.62
	FW48	0.80	150	821788.726		19.65
	FW49	0.80	150	821798.632	834835.390	19.63
	FW50	0.80	100	821798.535	834835.121	19.66
	FW51	0.80	100	821788.699		18.65
	FW52	0.80	100	821782.044	834842.028	18.61
	FW53	exposed	100	821781.317	834842.517	19.62
	FW54	exposed	80	821781.119	834842.708	19.61
	FW55	0.80	80	821781.961	834841.831	19.61
	FW56	0.80	80	821788.654	834838.919	19.65
	FW57	0.80	80	821798.441	834834.765	19.58
	FW58	exposed	150	821795.012	834824.731	19.56
	FW59	exposed	100	821795.523		19.55
	FW60	exposed	80	821795.605		19.50
	FW61	0.25	25	821851.943	834822.365	23.01
	FW62	0.20	25 25	821850.843	834819.582	23.03
٨	FW63 FW64	exposed	25 1650X650	821850.658 821849.460	834819.659 834814.626	23.05
	FW65	exposed 0.80	100	821849.460 821849.171	834814.626	23.00
	FW66	0.80	100	821849.171	834813.444	23.00
#	FW67	1.30	650X650	821813.069		18.80
#	FW68	1.25	650X650	821831.890	834794.285	19.76
	FW69	1.00	100	821831.337	834794.987	19.73
	FW70	1.10	100	821831.690		19.74
#	FW71	3.50	600X300	821832.659		19.79
_	FW72	3.10	1200	821832.347	834792.357	19.68
*	FW73	0.40	300X300	821874.970	834775.766	20.49
	FW74	0.70	150	821875.289	834776.650	20.61
#	FW75	0.45	300X200	821873.899	834777.188	20.53
*	FW76	-	-	821872.380		20.47
	FW77	3.60	600X600	821876.676		20.65
Ψ.	FW78	3.00	1200	821876.484	834774.992	20.58
w.	Valve @ -	Fire Hydran	t, #-Manhol	e,^- FS Inlet		

			ATC C	able (ATC)		
	Point	Depth (m)	Diameter/ Dimension (mm)	Northing	Easting	G.L.(mPD)
	ATC01	0.80	100(2X2)	821810.611	834836.422	19.62
	ATC02	0.80	100(2X2)	821810.706	834836.840	19.62
#	ATC03	1.35	1000X780	821810.782	834837.181	19.62
	ATC04	0.40	100(1X4)	821810.266	834837.352	19.62
	ATC05	0.40	100(1X4)	821803.978	834839.626	19.61
	ATC06	0.30	100(1X1)	821798.564	834841.164	19.62
#	ATC07	1.20	1000X1000	821798.226	834841.542	19.62
	ATC08	0.30	100(1X1)	821798.360	834840.936	19.62
	ATC09	0.25	100(1X1)	821799.048	834835.633	19.82
#	ATC10	exposed	2050X1130	821800.843	834834.952	19.95
	ATC11	0.60	100(2X2)	821797.660	834841.599	19.63
	ATC12	0.65	100(2X2)	821793.112	834843.309	19.64
	ATC13	0.60	100(2X2)	821789.245	834844.587	19.64
#	ATC14	1.20	1000X1000	821788.858	834844.786	19.63
	ATC15	0.60	100(2X2)	821788.284	834844.866	19.63
	ATC16	0.65	100(2X2)	821784.207	834845.181	19.63
	ATC17	0.60	100(2X2)	821779.522	834845.703	19.64
#	ATC18	1.70	1000X1000	821778.938	834845.575	19.64
	ATC19	exposed	100(1X1)	821778.822	834845.084	19.70
	ATC20	0.80	100(1X1)	821778.362	834845.260	19.62
	ATC21	0.55	100(1X1)	821776.399	834843.287	19.71
	ATC22	0.55	100(1X1)	821773.284	834836.155	19.63
#	ATC23	0.40	180X180	821806.020	834839.148	19.61
	ATC24	0.35	30(1X1)	821805.990	834839.074	19.61
	ATC25	exposed	30(1X1)	821805.758	834838.400	19.60
#	ATC26	0.20	300X300	821837.734	834827.917	22.96
	ATC27	0.20	50(1X1)	821837.734	834827.771	22.96
_	ATC28	exposed	50(1X1)	821837.162	834826.159	23.26
#	ATC29	0.20	300X300	821801.006	834813.917	17.05
#	ATC30	exposed	900X600	821804.227	834805.076	16.89
	ATC31	0.60	100(2X1)	821804.227	834804.648	16.93
_	ATC32	0.80	100(2X1)	821804.914	834803.985	16.99
_	ATC32	0.50	100(2X1)	821806.557	834803.876	16.98
_	ATC34	0.40	1001X1)	821806.337	834803.964	16.96
#	ATC35	0.55	600X600	821806.050	834803.934	16.95
11:	ATC36	0.35	1001X1)	821805.763	834804.167	16.95
	ATC37	0.35	1001X1)	821803.765	834804.531	16.93
#	ATC38	0.65	600X600	821804.865	834805.491	16.83
17	ATC39	0.05	100(1X1)	821802.304	834805.263	16.84
	ATC40	0.45	100(1X1)	821803.123	834805.832	16.82
_	ATC40	0.30	100(1X1)	821803.123	834804.790	16.87
_		0.45				
#	ATC42		100(1X1)	821801.935	834805.474 834805.600	16.77 16.76
Ħ	ATC43 ATC44	0.55	700X700 100(2X1)	821801.594		16.74
_			100(2X1)		834805.714	16.58
_	ATC45	0.40		821798.702	834806.733	
#	ATC46	0.45	100(2X1)	821795.974	834807.929	16.39
T.	ATC47 ATC48	0.80	600X600	821795.619	834807.834	16.36
_		0.35	100(1X1)	821795.939	834807.835	16.38
Н	ATC49	0.40	100(1X1)	821796.701	834807.402	16.39
#	ATC50	0.50	400X300	821796.732	834807.280	16.40
٨	ATC51	0.30	100(1X1)	821796.929	834807.160	16.42
_	ATC52	exposed 0.70	- 100(2V1)	821797.041	834807.151	16.44
	ATC53	0.70	100(2X1)	821795.449	834807.577	16.32
_	ATC54	0.60	100(2X1)	821795.250	834806.971	16.28
_	ATC55	0.45	100(1X1)	821795.373	834808.033	16.34
_	ATC56	0.40	100(1X1)	821793.048	834808.934	16.20
٨	ATC59	0.50	400X300	821792.884	834808.939	16.20
#	ATC58	exposed	0507/550	821792.660	834808.969	16.18
#	ATC59	exposed	950X550	821779.064	834814.176	15.46
	ATC60	0.30	100(1X1)	821779.168	834814.487	15.49
4	ATC61	0.25	100(1X1)	821779.298	834814.847	15.51
#	ATC62	0.50	600X600	821779.421	834815.121	15.52
*	ATC63	0.40	100(1X1)	821779.696	834814.999	15.53
	ATC64	exposed	100/1771	821780.857	834814.346	15.59
*	ATC65	0.40	100(1X1)	821779.146	834815.241	15.49
_	ATC66	exposed	10077	821775.673	834816.613	15.33
#	ATC67	0.45	400X300	821778.387	834814.519	15.46
	ATC68	0.20	100(1X1)	821778.612	834814.179	15.48
12	ATC69	0.20	100(1X1)	821777.766	834814.477	15.41
#	ATC70	0.90	700X700	821777.484	834814.734	15.40
#	ATC71	0.90	700X700	821776.732	834814.893	15.35
	ATC72	0.50	100(1X1)	821776.390	834814.895	15.33
	ATC73	0.10	100(1X1)	821773.880	834815.208	15.11
_	ATC74	0.50	100(2X1)	821776.953	834814.555	15.37

			Public Ligh	hting Cable (I	.)	
	Point	Depth (m)		Northing	Easting	G.L.(mPD
	L01	0.75	(mm) 100(2X1)	821850.276	834812.971	23.02
	L02	0.75	100(2X1)		834817.293	23.04
	L03	0.75	100(2X1)	821853.114	834820.022	23.03
#	L04	1.15	1000X1000		834820.470	23.04
	L05	0.75	100(2X1)	821853.852	834820.396	23.03
	L06	0.75	100(2X1)	821857.729	834818.696	23.00
	L07	0.80	100(2X1)	821862.583	834816.627	22.94
#	L08	1.20	1000X1000		834816.437	22.93
	L09	0.80	100(2X1)	821863.516	834816.262	22.94
	L10	0.75	100(2X1)	821868.598	834814.122	22.93
	L11	0.80	100(2X1)	821872.601	834812.623	22.90
	L12	1.20	100(2X1)	821873.043	834812.371	22.91
	L13	0.80	100(2X1)	821873.498	834812.155	22.89
*	L14	exposed	100(2X1)	821874.884	834811.561	22.90
	L15	0.60	100(1X1)	821868.589	834779.091	20.20
	L16	0.60	100(1X1)	821862.035	834781.688	19.82
	L17	0.60	100(1X1)	821858.458	834784.204	19.66
	L18	0.60	100(1X1)	821853.685	834786.462	19.39
*	L19	exposed	100(1X1)	821853.003	834785.375	19.37
	L20	0.70	100(1X1)	821851.041	834788.634	19.26
	L21	0.60	100(1X1)	821844.199	834790.784	18.88
	L22	0.60	100(1X1)	821836.259	834794.205	18.47
	L23	0.50	100(1X1)	821830.250	834796.387	18.17
	L24	0.45	100(1X1)	821822.323	834799.148	17.79
	L25	0.45	100(1X1)	821813.930	834802.560	17.35
	L26	0.50	100(1X1)	821808.648	834804.397	17.07
*	L27	exposed	100(1X1)	821808.238	834802.808	17.05
	L28	0.30	100(1X1)	821807.721	834804.174	17.01
	L29	0.30	100(1X1)	821805.089	834805.191	16.92
	L30	0.50	100(1X1)	821800.920	834806.775	16.68
#	L31	0.60	600X600	821800.720	834806.901	16.69
	L32	0.50	100(1X1)	821800.280	834806.624	16.67
	L33	exposed	100(2X1)	821800.755	834806.248	16.69
	L34	0.50	100(1X1)	821800.639	834807.594	16.68
	L35	0.40	100(1X1)	821792.039	834811.191	16.15
	L36	0.35	100(1X1)	821785.175	834813.748	15.78
	L37	0.35	100(1X1)	821781.761	834815.688	15.69
	L38	0.35	100(1X1)	821780.460	834815.302	15.58
	L39	0.30	100(1X1)	821776.944	834816.456	15.38
	L40	0.30	100(1X1)	821767.822	834819.613	14.89
	L41	0.35	100(1X1)	821760.966	834822.005	14.53
*	L42	exposed	100(1X1)	821760.732	834821.265	14.50
	L43	0.40	100(1X1)	821752.780	834825.364	14.05
	L44	0.80	100(1X1)	821872.094	834777.516	20.44
_	L45	0.60	100(1X1)	821873.460	834777.667	20.54
_	L46	0.40	100(1X1)	821878.037	834775.791	20.75

	Electric Cable (E)							
Point	Depth (m)	Diameter/ Dimension (mm)	Northing	Easting	G.L.(mPD			
E01	0.70	11KV+LV	821752.953	834826.675	14.06			
E02	0.70	11KV+LV	821757.641	834824.898	14.35			
E03	0.70	11KV+LV	821761.763	834823.130	14.62			
E04	0.80	11KV+LV	821767.427	834821.059	14.88			
E05	0.70	11KV+LV	821772.302	834819.419	15.15			
E06	0.70	11KV+LV	821777.052	834817.833	15.40			
E07	0.70	11KV+LV	821781.401	834816.209	15.68			
E08	0.70	11KV+LV	821784.861	834814.865	15.83			
E09	0.70	11KV+LV	821784,727	834814.013	15.76			
E10	0.70	11KV+LV	821791.718	834812.170	16.13			
E11	0.70	11KV+LV	821794.357	834811.689	16.31			
E12	0.70	11KV+LV	821795.615	834814.722	16.76			
E13	0.70	11KV+LV	821796.771	834817.700	17.18			
E14	0.50	11KV+LV	821793.835	834810.214	16.24			
E15	0.50	11KV+LV	821800.759	834807.668	16.68			
E16	0.50	11KV+LV	821814.036	834802.734	17.36			
E17	0.50	11KV+LV	821817.707	834801.300	17.55			
E18	0.50	11KV+LV	821822.591	834799.281	17.79			
E19	0.50	11KV+LV	821826.504	834797.499	18.00			
E20	0.50	11KV+LV	821830.179	834796.291	18.16			
E21	0.50	11KV+LV	821835.981	834794.131	18.45			
E22	0.50	11KV+LV	821839.614	834792.282	18.67			
E23	0.50	11KV+LV	821844.085	834790.584	18.88			
E24	0.50	11KV+LV	821847.687	834789.503	19.07			
E25	0.50	11KV+LV	821850.904	834788.370	19.26			
E26	0.50	11KV+LV	821854.442	834786.446	19.46			
E27	0.50	11KV+LV	821858.204	834784.041	19.63			
E28	0.50	11KV+LV	821861.864	834782.356	19.84			
E29	0.50	11KV+LV	821868.706	834779.527	20.21			
E30	0.60	11KV+LV	821878.531	834775.642	20.77			
E31	0.60	11KV+LV	821874.188	834777.643	20.56			
E32	0.60	11KV+LV	821873.155	834777.255	20.50			
E33	0.60	11KV+LV	821871.368	834777.987	20.41			

_			Gas Diameter/	Pipe (G)		I
	Point	Depth (m)		Northing	Easting	G.L.(mPD)
	G01	0.65	63	821804.294	834839.006	19.62
*	G02	0.60	260x180	821804.575	834839.625	19.62
	G03	0.65	63	821804.659	834839.915	19.62
	G04	0.60	63	821800.521	834841.628	19.59
	G05	0.60	63	821798.540	834836.664	19.59
	G06	0.60	63	821797.254	834834.034	19.61
	G07	0.60	63	821795.137	834828.383	19.63
	G08	0.60	63	821794.034	834825.079	19.56
	G09	0.90	63	821795.010	834823.492	19.76
	G10	0.65	63	821795.024	834821.321	19.59
	G11	0.70	63	821793.577	834817.587	17.04
*	G12	0.70	260x180	821793.836	834815.082	16.65
*	G13	0.30	260x180	821793.675	834814.656	16.56
	G14	0.40	63	821793.512	834814.125	16.49
	G15	0.20	63	821792.193	834814.354	16.29
	G16	0.50	63	821791.358	834812.308	16.12
	G17	0.65	63	821790.384	834808.878	16.01
	G18	0.60	63	821753.104	834823.054	13.96
*	G19	0.50	260x180	821753.934	834825.055	14.11
	G20	0.50	63	821754.488	834827.182	14.15

			Un-ident	ify Utility (U)		
	Point	Depth (m)	Diameter/ Dimension (mm)	Northing	Easting	G.L.(mPD)
#	U01	0.68	1100X1100	821790.742	834832.700	19.70
	U02	0.55	100(2X1)	821790.165	834832.621	19.70
	U03	0.55	100(2X1)	821791.103	834832.066	19.70
#	U04	1.00	1100X1100	821794.772	834826.852	20.13
	U05	0.90	100(2X1)	821794.450	834827.256	20.13

			Salt Wate	er Main (SW)		
	Point	Depth (m)	Diameter/ Dimension (mm)	Northing	Easting	G.L.(mPD
	SW01	0.95	50	821809.521	834812.356	17.28
	SW02	0.75	50	821807.384	834806.773	17.06
*	SW03	0.6	180x180	821807.133	834806.344	17.04
*	SW04	0.25	300x300	821806.066	834804.625	16.98
	SW05	0.7	25	821805.445	834802.97	16.83
	SW06	exposed	25	821778.793	834833.444	19.19
	SW07	exposed	25	821779.59	834834.987	19.19
	SW08	exposed	25	821786.816	834832.012	19.63
	SW09	0.15	25	821787.384	834831.659	19.63
	SW10	exposed	25	821787.003	834830.514	19.67
* _	Valve,					

	Point	Company	Depth (m)	Diameter/Dim ension (mm)	Northing	Easting	G.L.(mF
_	T01 T02	PCCW PCCW	1.20 1.20	100(2x2) 100(2x2)	821753.248 821754.245	834825.739 834825.287	14.09 14.14
# '	T03 T04	PCCW PCCW	1.50	2500x880	821755.525 821754.806	834825.179 834825.900	14.21
	T05	PCCW	exposed	100(1X1) 100(1X1)	821754.198	834827.642	14.46
_	T06 T07	PCCW PCCW	0.80 0.70	100(2x2) 100(2x2)	821756.638 821767.265	834824.550 834820.486	14.27 14.88
_	T08 T09	PCCW PCCW	0.70 1.00	100(2x2) 100(2x2)	821775.218 821782.991	834817.507 834813.971	15.32 15.66
_	T10 T11	PCCW PCCW	1.15 0.50	1200x680 100(1X1)	821783.552 821784.137	834813.738 834813.797	15.69 15.72
	T12 T13	PCCW PCCW	0.50 0.30	100(1X1) 100(1X1)	821786.150 821786.505	834815.007 834816.708	15.89 16.92
	T14	PCCW	0.60	100(1X1)	821785.182	834819.517	17.64
	T15 T16	PCCW PCCW	0.30 0.50	100(1X1) 100(1X1)	821780.821 821779.968	834825.051 834826.962	18.69 19.01
$\overline{}$	T17 T18	PCCW PCCW	0.45 0.55	100(1X1) 1050x580	821779.100 821778.650	834827.532 834827.778	19.52 19.53
$\overline{}$	T19 T20	PCCW PCCW	0.43	100(1X1) 100(1X1)	821777.937 821777.023	834828.202 834828.387	19.14 19.15
-	T21 T22	PCCW PCCW	1.00 0.80	100(2x2) 100(2x2)	821784.044 821792.043	834813.510 834810.503	15.71 16.14
1	T23 T24	PCCW PCCW	0.90	100(2x2) 100(2x2)	821801.484 821806.907	834806.845 834804.241	16.72 16.98
# "	T25	PCCW	2.30	780x780	821807.239	834803.574	17.01
1	T26 T27	PCCW PCCW	1.50	100(2x2) 100(2x2)	821806.911 821806.537	834802.864 834802.289	16.97 16.88
_	T28 T29	PCCW PCCW	0.90 0.90	100(1X1) 100(1X1)	821807.515 821808.191	834804.131 834803.273	17.00 17.01
$\overline{}$	T30 T31	PCCW PCCW	0.60	100(1X1) 100(1X1)	821812.640 821821.381	834801.619 834798.385	17.29 17.75
-	T32 T33	PCCW PCCW	0.50 0.50	100(1X1) 100(1X1)	821829.152 821835.219	834794.831 834792.877	18.11 18.42
	T34 T35	PCCW	0.50 0.50	100(1X1)	821842.822	834789.980 834787.835	18.83
	T36	PCCW PCCW	0.50	100(1X1) 100(1X1)	821850.448 821859.136	834784.619	19.21
# 7	T37 T38	PCCW PCCW	0.50 0.65	100(1X1) 1050x580	821866.907 821867.393	834781.448 834781.280	20.16
	T39 T40	PCCW PCCW	0.50 0.40	100(2x1) 100(1X1)	821867.781 821868.786	834781.502 834785.729	20.20 20.77
$\overline{}$	T41 T42	PCCW PCCW	0.40 exposed	100(1X1)	821871.051 821872.898	834792.926 834797.459	21.98 22.84
	H01 H02	HGC HGC	0.50 0.45	100(2x2) 100(2x2)	821752.684 821756.422	834825.086 834823.248	14.05 14.26
#	H03 H04	HGC HGC	0.80	2500x800 100(2x2)	821757.517 821758.737	834822.644 834822.333	14.32 14.39
]	H05	HGC	0.50	100(2x2)	821767.081	834819.806	14.83
	H06 H07	HGC HGC	0.50 0.45	100(2x2) 100(2x2)	821776.917 821783.744	834815.676 834812.903	15.36 15.71
_	H08 H09	HGC HGC	0.45 0.45	100(2x2) 100(2x2)	821791.948 821796.443	834809.865 834808.568	16.14 16.43
$\overline{}$	H10 H11	HGC HGC	0.45	100(2x2) 100(2x2)	821801.713 821811.814	834807.303 834803.708	16.74 17.23
$\overline{}$	H12 H13	HGC HGC	0.45 0.45	100(2x2) 100(2x2)	821821.495 821829.511	834800.147 834796.935	17.73 18.13
1	H14 H15	HGC HGC	0.45	100(2x2) 100(2x2)	821835.512 821843.249	834794.600 834791.581	18.43 18.86
]	H16	HGC	0.30	100(2x2)	821850.533	834788.986	19.23
]	H17 H18	HGC HGC	0.30 0.50	100(2x2) 100(2x2)	821859.513 821868.768	834785.351 834781.410	19.75 20.26
_	H19 H20	HGC HGC	0.50 0.80	100(2X2) 2400X800	821870.889 821872.104	834779.985 834779.347	20.39 20.45
_	H21 H22	HGC HGC	0.50 0.50	100(2X2) 100(2X2)	821873.139 821878.625	834779.001 834777.030	20.51
_	W01 W02	NWT NWT	0.30 0.25	100(2x1) 100(2x1)	821753.088 821760.998	834825.022 834822.699	14.07 14.54
,	W03 W04	NWT NWT	0.20	100(2x1) 100(2x1)	821768.249 821779.236	834820.004 834816.474	14.93 15.52
# 1	W05 W06	NWT	0.50	1400x700	821779.876	834816.112	15.57
,	W07	NWT NWT	0.35	100(2x1) 100(2x1)	821780.543 821786.113	834815.963 834814.416	15.62 15.85
,	W08 W09	NWT NWT	0.30 0.45	100(2x1) 100(2x1)	821792.162 821796.213	834811.981 834810.761	16.14 16.41
-	W10 W11	NWT NWT	0.50	100(2x1) 1400x700	821803.416 821804.134	834807.629 834807.603	16.87 16.92
_	W12 W13	NWT NWT	0.70 0.45	100(2x1) 100(2x1)	821804.834 821812.394	834807.509 834804.130	16.96 17.26
	W14 W15	NWT NWT	0.45 0.35	100(2x1) 100(2x1)	821821.916 821829.999	834800.459 834797.380	17.75 18.16
	W16 W17	NWT NWT	0.35 0.45	100(2x1)	821835.205 821842.965	834794.307	18.41
,	W18	NWT	0.45	100(2x1) 100(2x1)	821850.351	834790.340 834788.130	18.83
,	W19 W20	NWT NWT	0.35	100(2x1) 100(2x1)	821859.286 821868.961	834784.993 834781.574	19.74 20.27
,	W21 W22	NWT NWT	0.50 0.50	100(1X1) 100(2X1)	821878.847 821876.758	834777.291 834778.401	20.82 20.70
_	W23 W24	NWT NWT	0.75 0.50	1400X700 100(2X1)	821876.053 821875.424	834778.646 834778.878	20.66
,	W25 W26	NWT NWT	0.50 0.50	100(1X1) 100(1X1)	821875.146 821869.954	834779.493 834781.174	20.61
	K01 K02	HKBN HKBN	0.40 0.40	100(1x1) 100(1x1) 100(1x1)	821868.801 821858.987	834781.224 834784.537	20.26 19.72
]	K03	HKBN	0.40	100(1x1)	821850.495	834788.229	19.23
]	K04 K05	HKBN HKBN	0.40	100(1x1) 100(1x1)	821843.184 821835.669		18.84
]	K06 K07	HKBN HKBN	0.40 0.40	100(1x1) 100(1x1)	821829.599 821821.537	834796.657 834799.822	18.15 17.74
	K08 K09	HKBN HKBN	0.35 0.60	100(1x1) 100(1x1)	821812.111 821806.260	834803.488 834807.191	17.27 17.01
$\overline{}$	K10 K11	HKBN HKBN	0.45 0.45	100(1x1) 1400x700	821803.391 821802.523	834807.940 834808.400	16.87 16.80
]	K12 K13	HKBN HKBN	0.35	50(2x1) 50(2x1)	821803.502 821807.066	834808.317 834806.849	16.88 17.05
]	K14 K15	HKBN HKBN	0.50 0.35	50(2x1) 50(2x1) 50(2x1)	821809.749 821802.190	834812.317 834808.820	17.28 16.78
]	K16	HKBN	0.35	50(2x1)	821796.254	834810.943	16.42
]	K17 K18	HKBN HKBN	0.30	50(2x1) 50(2x1)	821792.048 821786.145	834812.177 834814.657	16.13 15.85
]	K19 K20	HKBN HKBN	0.30 0.35	50(2x1) 50(2x1)	821779.897 821769.426	834817.064 834820.572	15.58 15.00
	K21 K22	HKBN HKBN	0.50 0.35	1400x700 50(2x1)	821768.679 821768.049	834820.730 834821.152	14.96 14.93
]	K23 K24	HKBN HKBN	0.30	50(2x1) 50(2x1)	821761.196 821753.593	834823.655 834826.600	14.57 14.09
]	K25 K26	HKBN	0.40	100(1X1)	821871.876	834780.073	20.44
]	K27	HKBN HKBN	0.40	100(1X1) 100(1X1)	821873.840 821874.209	834779.363 834778.312	20.55
# (K28 CNW01	HKBN HKCNW	0.40	100(1X1) 600X600	821878.500 821778.375	834777.259 834816.367	20.80 15.45
	CNW02 CNW03	HKCNW HKCNW	0.35 0.35	100(2X1) 100(2X1)	821777.992 821778.679	834816.402 834816.145	15.43 15.48
# (CNW04 CNW05	HKCNW HKCNW	0.70 0.60	600X600 100(2X1)	821805.457 821805.080	834807.045 834807.023	16.98 16.95
				100(2X1)	821805.735	834806.781	16.98

	n '	D	Diameter/	r Sewer (F)	m	G.L.(mPI
	Point	Depth (m)	Dimension (mm)	Northing	Easting)
#	F01 F02	0.60	580X580 100	821772.664 821772.302	834827.758 834827.762	19.53 19.53
	F03	exposed	100	821771.651	834828.552	19.55
	F04	0.55	100	821772.645	834827.909	19.54
	F05 F06	0.50	100	821772.448 821772.984	834828.294 834827.788	19.52 19.55
	F07	0.50	100	821772.921	834828.139	19.53
	F08 F09	0.60	100	821772.949 821775.606	834827.348 834825.946	19.53 19.54
#	F10	0.68	580X580	821776.069	834826.371	19.55
*	F11 F12	0.55	100 300X300	821775.646 821773.741	834826.058 834827.348	19.53 19.54
	F13	0.35	100	821773.736	834827.510	19.54
	F14 F15	0.30	100 100	821773.904 821775.740	834827.717 834826.309	19.54 19.54
	F16	0.50	100	821774.495	834827.518	19.53
	F17	0.55	100	821775.816	834826.509	19.54
_	F18 F19	0.50	100	821775.143 821776.338	834827.328 834826.433	19.52 19.55
	F20	0.93	100	821780.113	834836.131	19.61
#	F21 F22	0.98	680X680 100	821780.183 821780.150	834836.815 834836.720	19.62 19.62
	F23	0.98	100	821780.791	834836.494	19.61
#	F24	1.18	100	821789.567	834831.760	19.70
#	F25 F26	1.20	680X680 100	821789.851 821789.921	834831.921 834831.172	19.70 19.70
#	F27	UTR	680X680	821788.137	834814.969	16.33
	F28 F01A	1.20 0.85	150 100	821785.496 821843.934	834810.717 834823.527	15.71 23.04
	F02A	0.88	100	821843.805	834824.212	23.03
#	FO3A	0.90	450X450	821843.667	834824.638	23.02
_	F04A F05A	0.90	100	821843.354 821841.154	834824.818 834825.628	23.01
#	F06A	0.95	450X450	821840.782	834825.684	23.01
-	F07A F08A	0.92 exposed	100 100	821841.051 821841.872	834825.425 834824.321	23.01
	F09A	0.90	100	821841.024	834825.264	23.00
	F10A F11A	0.85 0.80	100 50	821841.351 821840.782	834824.515 834825.329	23.01 23.00
	F11A F12A	0.80	50	821840.782 821840.729	834825.329 834824.768	23.00
	F13A	0.90	100	821840.626	834825.425	23.00
	F14A F15A	0.85	100	821840.553 821840.480	834824.822 834825.476	23.01
	F16A	exposed	100	821840.352	834824.989	23.05
#	F17A F18A	0.95 1.00	100 450X400	821840.444 821832.815	834825.892 834829.093	23.00 22.98
	F19A	1.15	100	821829.084	834830.653	22.96
#	F20A F21A	1.18 0.50	700X580 100	821828.774 821828.676	834830.904 834830.443	22.96 22.97
	F21A F22A	0.40	100	821828.352	834829.772	23.28
	F23A	1.18	100	821828.374	834830.951	22.96
#	F24A F25A	1.20	100 450X450	821826.894 821826.640	834831.557 834831.812	22.96 22.95
	F26A	1.13	100	821826.829	834831.374	22.97
_	F27A F28A	1.10	100	821827.140 821826.600	834830.138 834831.448	22.94 22.96
	F29A	1.10	100	821826.362	834830.438	22.90
	F30A	1.30	150	821826.202	834831.874	22.95
#	F31A F32A	0.60	150 450X450	821822.073 821821.595	834833.587 834833.576	21.35 21.36
	F33A	0.60	100	821821.689	834833.345	21.35
*	F34A F35A	0.30	150X150 100	821821.329 821821.481	834832.395 834833.450	21.35 21.34
	F36A	0.58	100	821820.851	834832.463	21.40
_	F37A F38A	0.65	100 100	821821.485 821818.590	834833.810 834834.837	21.35 19.61
#	F39A	0.73	450X450	821818.361	834834.997	19.61
	F40A	0.73	100	821818.066	834835.109	19.62
#	F41A F42A	0.76	100 450X450	821816.671 821816.377	834835.602 834835.548	19.61 19.63
	F43A	0.75	100	821816.356	834835.334	19.63
*	F44A F45A	0.25	150X150 100	821816.608 821816.205	834834.198 834835.412	19.63 19.63
	F46A	0.68	100	821815.897	834834.416	19.64
_	F47A	0.78	100	821816.107	834835.841	19.63
#	F48A F49A	0.90	100 700X580	821810.073 821809.778	834838.022 834838.231	19.61 19.60
	F50A	0.75	100	821810.014	834837.805	19.61
-	F51A F52A	0.70	100	821811.118 821809.759	834836.236 834837.918	19.63 19.61
	F53A	0.75	100	821809.337	834836.903	19.61
_	F54A F55A	0.93	100 100	821809.365 821805.676	834838.287 834839.556	19.60 19.62
#	F56A	1.03	450X450	821805.333	834839.726	19.62
*	F57A	0.93	100	821805.341	834839.397	19.62
_	F58A F59A	0.25 1.03	150X150 100	821805.389 821804.986	834838.618 834839.844	19.61 19.61
#	F60A	1.06	100	821800.136	834841.455	19.60
	F61A F62A	1.12	680X680 100	821799.730 821799.648	834841.571 834841.216	19.61 19.60
#	F63A	1.18	100	821798.258	834837.606	19.61
_	F64A F65A	1.20 1.10	680X680 100	821798.094 821798.460	834837.256 834837.242	19.61 19.61
#	F65A F66A	0.92	100	821798.460 821800.995	834837.242 834837.645	19.60
*	F67A	0.92	680X680	821801.372	834837.568	19.59
well.	F68A F69A	0.87	100 100X100	821801.737 821802.017	834837.733 834837.897	19.58 19.57
	F70A	0.87	100	821801.794	834837.598	19.58
_	F71A	0.83	100	821802.428 821801.573	834837.583	19.60
_	F72A F73A	0.85	100	821801.573 821802.128	834837.274 834836.763	19.58 19.60
*	F74A	1.20	100	821797.957	834836.909	19.61
#	F218A F219A	1.10	100 800X350	821791.786 821791.017	834820.836 834820.108	17.59 17.22
	F220A	1.05	100	821791.235	834819.866	17.19
_ 7	F221A Manhole,*	1.05 -U-Gully	100	821788.318	834815.263	16.34
	-					
				Cable (TV)		
	Point	Depth (m)		Northing	Easting	G.L.(mPl
			(mm)		ı	

			CAIV	Cable (TV)		
	Point	Depth (m)	Diameter/ Dimension (mm)	Northing	Easting	G.L.(mPI
	TV01	0.30	100(2x1)	821753.042	834824.808	14.06
	TV02	0.30	100(2x1)	821760.920	834822.429	14.53
	TV03	0.30	100(2x1)	821768.072	834819.559	14.91
	TV04	0.30	100(2x1)	821777.384	834816.032	15.40
	TV05	0.35	100(2x1)	821781.367	834814.780	15.63
#	TV06	0.55	1400x700	821782.115	834814.817	15.66
	TV07	0.35	100(2x1)	821782.951	834814.720	15.69
	TV08	0.30	100(2x1)	821785.659	834813.665	15.78
	TV09	0.30	100(2x1)	821791.991	834811.578	16.13
	TV10	0.35	100(2x1)	821795.090	834810.333	16.33
	TV11	0.50	100(2x1)	821795.782	834810.179	16.39
	TV12	0.40	100(2x1)	821796.348	834809.727	16.43
	TV13	0.35	100(2x1)	821803.736	834806.935	16.87
	TV14	0.30	100(2x1)	821812.264	834803.634	17.26
	TV15	0.35	100(2x1)	821821.698	834799.980	17.75
	TV16	0.35	100(2x1)	821829.723	834796.752	18.15
	TV17	0.35	100(2x1)	821835.401	834794.069	18.42
	TV18	0.35	100(2x1)	821842.963	834790.756	18.84
	TV19	0.35	100(2x1)	821850.249	834787.751	19.22
	TV20	0.35	100(2x1)	821858.763	834784.335	19.70
	TV21	0.40	100(2x1)	821868.506	834780.096	20.25
	TV22	0.30	100(2X1)	821877.692	834776.526	20.76
	TV23	0.40	100(1X1)	821872.807	834778.257	20.51

	Point	Depth (m)	Diameter/ Dimension (mm)	Northing	Easting	G.L.(mPD)
	S75 S76	0.30	300 300	821795.549 821796.927	834820.757 834824.105	19.53 19.39
	S77 S78 S79	0.30 0.22 0.20	300 300 300	821794.725 821798.132 821800.651	834825.525 834834.404 834833.445	19.48 19.60 19.60
	S80 S81	0.20 0.18 0.22	300 300 300	821800.651 821803.046 821811.695	834833.445 834839.628 834836.403	19.60 19.60 19.64
_	S82 S83	0.25 0.65	300 300	821812.288 821817.797	834837.999 834833.837	19.59 19.85
#	S84 S85	0.65 0.63	600X500 225	821818.077 821818.318	834833.874 834833.793	20.07
	S86 S87	0.12	300 300	821818.778 821821.772	834835.652 834834.402	19.59
	S88 S89 S90	0.12 0.12 0.20	300 300 300	821822.479 821825.784 821836.587	834834.157 834832.879 834828.736	21.37 22.94 22.94
#	S91 S92	0.63	300 800X600	821835.883 821835.832	834827.191 834826.871	23.41
	S93 S94	0.32	300 300	821851.283 821850.590	834822.796 834821.115	23.08
	S95 S96	0.48 0.22	300 300	821879.122 821874.330	834811.629 834799.447	22.84 22.92
	S97 S98	0.15	300 300	821865.439 821871.853	834799.249 834793.300	22.93
	S99 S100 S101	0.80 0.15 0.40	300 300 150	821863.416 821843.681 821843.322	834792.526 834800.766 834800.211	23.05 23.00 22.94
	S102 S103	0.38	300 300	821845.265 821848.420	834805.235 834805.734	23.01
	S104 S105	0.30	300 300	821851.132 821848.646	834812.795 834813.819	23.01
	S106 S107	0.08 1.38	300 300	821851.242 821775.491	834820.636 834852.438	23.01 20.43
#	S108 S109	1.70	300 300 300	821774.740 821774.340	834852.251 834852.928	20.44
	S110 S111 S112	0.30 0.45 0.40	300 300	821773.291 821773.323 821774.098	834860.758 834862.623 834867.954	19.70 20.23 20.61
	S113 S114	0.60	400 400	821774.566 821775.713	834852.947 834854.207	20.42
#	S115 S116	0.93 0.93	400 850X850	821791.149 821791.585	834854.461 834854.235	28.09 28.08
_	S117 S118	0.87 1.68	400 300	821792.068 821774.024	834854.133 834852.019	28.08
#	S119 S120 S121	0.98 1.00 1.00	300 680X500 300	821770.424 821769.990 821769.717	834852.029 834851.929 834851.653	19.60 19.60 19.62
#	S121 S122 S123	1.00 1.08 1.10	300 300 680X680	821769.717 821765.149 821764.832	834851.653 834845.113 834844.716	19.62 19.65 19.66
	S124 S125	1.13	300 300	821764.731 821766.761	834844.300 834840.254	19.65 19.62
#	S126 S127	1.50 1.50	680X680 300	821768.305 821768.133	834839.707 834839.149	19.61 19.61
#	S128 S129	1.90 3.30	300 700X680	821765.905 821765.905	834827.682 834827.455	19.50 19.49
	S130 S131 S132	0.80 0.70 3.30	100 150 300	821765.889 821765.527 821765.565	834827.836 834827.516 834827.651	19.49 19.49 19.50
	S132 S133 S134	0.33 0.30	300 300 300	821765.565 821765.578 821763.841	834827.807 834828.782	19.50 19.49 19.52
	S135 S136	0.28 0.25	300 300	821761.384 821756.551	834829.187 834833.340	19.51 19.53
	S137 S138	0.55	150 150	821766.269 821766.690	834827.488 834827.270	19.49 19.48
	S139 S140	0.30	300 300	821766.966 821770.594	834826.493 834825.352	19.44
	S141 S142 S143	0.15 0.10 0.13	300 300 300	821776.688 821786.911 821779.533	834822.989 834832.141 834835.256	19.56 19.62 19.59
	S144 S145	0.15 0.10	300 200	821778.864 821768.618	834834.161 834838.347	19.59 19.63
	S146 S147	0.10 0.18	200 300	821769.207 821761.644	834839.815 834840.943	19.63 19.60
	S148 S149	0.17	80 80	821761.481 821759.748	834840.887 834841.782	19.60 19.61
	S150 S151	0.10	300 100	821769.711 821758.602	834867.055 834833.346	19.84 19.55
	S152 S153 S154	0.30 0.23 0.20	300 300	821766.810 821771.971 821776.187	834830.275 834828.278 834826.749	19.52 19.53 19.53
	S155 S156	0.70 1.10	300 300	821754.062 821794.894	834827.304 834818.801	14.12 18.13
#	S157 S158	1.65 1.58	730X730 150	821794.587 821794.926	834818.513 834818.281	18.21 18.24
	S159 S160	exposed 1.60	150 225	821795.593 821794.606	834817.926 834818.168	17.18 18.23
#	S161 S162	1.00 1.40 1.20	225 680X680	821792.687 821792.566	834813.172 834812.955	16.27 16.25
	S163 S164 S165	1.20 1.00 0.40	150 100 100	821792.227 821792.382 821792.036	834812.916 834813.153 834813.647	16.21 16.24 16.18
	S166 S167	0.20	300 225	821792.030 821786.793 821792.631	834816.502 834812.748	16.46 16.25
	S168 S169	0.55 1.35	100 225	821793.108 821792.990	834812.842 834812.543	16.30 16.26
#	S170 S171	0.95 0.95	225 750X750	821798.336 821798.743	834811.723 834811.726	16.60 16.64
	S172 S173	0.65	100 150	821799.119 821799.194	834812.009 834811.831	16.71 16.69
#	S174 S175 S176	0.90 0.67 0.67	225 225 870X870	821799.102 821804.009 821804.429	834811.612 834811.018 834810.958	16.66 16.99 17.04
	S177 S178	0.67 0.60 0.65	100 150	821804.429 821804.857 821804.955	834811.384 834811.107	17.04 17.07 17.07
*	S179 S180	0.45 0.40	400X300 150	821810.168 821810.195	834811.989 834812.218	17.27 17.28
	S181 S182	exposed 0.66	150 225	821810.258 821804.864	834812.487 834810.523	17.29 17.04
ц	S183 S184 S185	2.20	900 900 600X600	821842.881 821843.669 821844.076	834788.499 834791.569	18.72 18.87
#	S185 S186 S187	2.20 0.85 1.95	150 300	821844.076 821843.382 821843.550	834791.988 834792.801 834792.735	18.86 18.86 18.87
#	S188 S189	1.93 1.90 1.90	300 300 800X800	821843.829 821843.970	834794.159 834794.577	18.92 18.92
*	S190 S191	1.75 0.40	225 550X350	821843.139 821827.666	834794.176 834805.345	18.88 17.75
	S192 S193	exposed 0.33	150 150	821827.735 821827.527	834805.543 834805.159	18.03 17.72
	S194 S195	0.20 1.60	150 225	821825.642 821843.581 821843.080	834800.494 834794.940 834799.204	17.92 18.92
#	S196 S197 S198	0.85 0.85 0.60	225 550X550 150	821843.080 821843.080 821842.816	834799.204 834799.441 834799.544	18.94 18.97 18.94
	S198 S199 S200	exposed 0.60	150 150 225	821842.412 821843.061	834799.898 834799.631	18.94 18.91 18.94
	S201 S202	1.40 1.25	600 600	821845.040 821865.818	834791.500 834783.490	18.93 20.13
#	S203 S204	1.25 1.20	580X580 600	821866.259 821866.793	834783.274 834783.074	20.15 20.18
	S205 S206	1.05	300 300	821869.126 821866.383	834782.093 834783.820	20.28
٨	S207 S208 S209	0.85 0.85 0.80	300 400X300 300	821866.058 821866.044 821866.230	834784.554 834784.823 834784.765	20.17 20.18 20.19
_	S210 S211	0.80 0.75 0.35	300 300 300	821868.629 821869.037	834784.763 834783.750 834784.026	20.19
	S212 S213	0.25 0.20	150 300	821866.126 821866.158	834785.104 834785.343	20.21 20.28
	S214 S215	0.15 0.45	300 150	821862.428 821865.800	834787.020 834784.961	20.10 20.18
٨	S216 S217	0.40 0.40	150 400X300	821862.821 821862.738 821809.672	834787.408	20.12
#	S222 S223 S224	0.55 1.05 1.05	225 450X450 600X600	821809.672 821810.262 821869.462		17.21 20.85 20.30
rT	S224 S225 S226	1.05 0.80 1.65	450 450	821869.462 821869.565 821869.829	834782.287	20.30 20.32 21.28
#	S227 S228	1.65 0.32	1300X1200 300	821870.188 821870.990	834783.051	20.75
	S229 S230	0.35 0.70	300 600	821879.022 821870.332	834780.610 834783.656	21.75 20.78
	S231 S232	0.45	300 225	821874.768 821876.411	834787.125 834786.204	23.38
	S233 S234 S235	0.35 0.85 0.90	600 600	821880.926 821880.870 821884.136	834792.042	23.41 29.25 34.24
	S236 S237	1.00 0.90	600	821886.489 821892.038	834799.763	36.88 38.39
	S238 S239	0.89 1.20	600	821889.662 821881.736	834822.604	39.07 39.07
_	S240	0.20	225	821879.504		29.25



Appendix VI(F)

Building Record Plans from Buildings Department

Appendix VI(F) – Building Record Plans from Buildings Department <u>Drawing List</u>

	Drawing No.	Drawing Title
1.	G-1	Location Plan, Notes & Schedules
2.	G-2	Block Plan & E.V.A. Plan
3.	G-3	Lower Ground Floor Plan
4.	G-4	Ground Floor Plan
5.	G-5	First Floor Plan
6.	G-6	Second Floor Plan
7.	G-7	Third Floor Plan
8.	G-8	Fourth Floor Plan
9.	G-9	Fifth Floor Plan
10.	G-10	Roof Plan
11.	G-11	Section A-A
12.	G-12	Section B-B
13.	G-13	West Elevation
14.	G-14	South Elevation
15.	G-15	East Elevation
16.	G-16	North Elevation
17.	G-17	Calculations (Site Coverage, Plot Ratio &
		Compartmentation)

Remark:

The drawings provided in this appendix are the approval plans from Buildings Department under the Batch I Revitalisation Scheme in 2010. The drawings are for reference only and may not reflect the as-built arrangement.

DISCHARGE	VALUE CALCULATIONS	FOR STAIRCASES IN	N A SPRINKLERED BUILI	DING		
STAIR NO.	WIDTH OF EACH STAIR (mm)	STOREYS SERVED	NO. OF STOREYS SERVED	DISCHARGE VALUE	TOTAL DISCHARGE VALUE	NO. OF PERSONS TO BE DISCHARGED
1	1050	LG/F TO 5/F	6	580		
2	1050	G/F TO 5/F	5	548	1760	TOTAL = 1441 < 1760
3	1200	G/F TO 5/F	5	632		

1387 54

un ar nrnaau		NO. OF FITME	NTS REQUIRED			NC). OF FITMENTS PROVIDE	ID .	
NO. OF PERSON	W.C.	BASIN	URINAL	BATH/ SHOWER	FLOOR	W.C.	BASIN	URINAL	UNI-SEX ACCESSIB TOILET
					G/F	1	-	. 1	
					1/F, 2/F, 4/F, 5/F	5 (EACH) x 4	5 (EACH) x 4	10 (EACH) x 4	•
MALE STUDENT = 693	23	_	46	- [3/F	4 .	5	6	
·		-			TOTAL	25	25	47	1 NO. (MIN.)
					1/F	. 6	7	-	1 NO. (MIN.) ON EACH FLOOR (G/F - 5/F)
					2/F	8	6	-	TOTAL
FEMALE STUDENT = 694	35	-	· -	- [3/F	5	5	-	= 6 NOS.
					4/F	8	6	-	
					5/F	8	7	-	
					TOTAL	35	31		
MALE STAFF = 27 /	2	2	1	-	G/F	2	2	1	
FEMALE STAFF = 27	3	2	_	-	G/F	3	2	_	

1. TOTAL NOS. OF STUDENT = 1387 (M = 693 F = 694) TOTAL NOS. OF STAFF = 54 (M = 27 F = 27)

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2. SANITARY FITMENT PROVISION FOR STAFF, WILL ADOPT "OFFICE" PROVISION ACCORDING TO BUILDING (STANDARDS OF SANITARY FITMENTS, PLUMBING, DRAINAGE WORKS AND LATRINES) REGULATION, REG. 5

3. SANITARY FITMENT PROVISION FOR STUDENT WILL COMPLY WITH EDUCATION REGULATIONS - FIRST SCHEDULE PARA. 1 THE REQUIREMENTS FOR W.C. AND URINALS WILL BE:

a) FOR MALE STUDENT: 1 PAN (W.C.) AND 2 URINALS FOR EVERY 30 PUPILS b) FOR FEMALE STUDENT: 1 PAN (W.C.) FOR EVERY 20 PUPILS

4. UNI-SEX ACCESSIBLE TOILET TO BE PROVIDED ON EACH FLOOR FROM G/F -- 5/F TOTAL 6 NOS. OF UNI-SEX ACCESSIBLE TOILET ARE PROVIDED.

GENERAL NOTES:

unless otherwise stated.

1. All brick and masonry works shall be built in 1:3 cement mortar. 2. All R.C.C. works shall be built in designed mix to comply with B(C) R 1990

Structural plans and calculation will be submitted seperately.

4. Drainage plans and details to be submitted separately.

5. Clear height between structural floor level to the underside of beam shall be 2300mm minimum.

6. Clear height between structural floor level to the underside of slab (soffit) shall be 3000mm minimum for new classrooms and 2500mm minimum for other area unless otherwise denoted.

7. Clear height between finished floor level to the underside of beam in staircases and protected lobbies shall be 2000mm minimum.

8. All staircases of 1050mm wide or more shall be provided with handrails on both sides

9. All risers of staircases shall be not more than 150mm Treads not less than 250mm. 10. Building planning regulation 72 and design manual: barrier free access 2008

to be complied with. 11. All works to comply with current building (construction) regulation.

12. All dimensions shown on all drawings are measured from structural surface unless otherwise specified.

13. Water Authority requirements to be complied with.

14. Education Ordinance and regulations to be complied with.

15. All toilets shall be provided with cement or glazed tile dado to not less than 1200mm high and shall be paved with cement or mosaic file flooring.

16. The fire resisting walls to rooms which are classified as special hazards shall have an F.R.P. of 2hrs. or 4 hrs. where adjoining required staircase.

17. Artificial lighting and mechanical ventilation shall be provided for toilets without windows to the satisfaction of building authority, the mechanical ventilation being capable of supplying fresh air at a rate of not less than 10 changes of air per hour and comply with requirements in PNAP 30.

18. Every part of an exit route should be provided with artificial lighting providing a horizontal illuminance at floor level of not less than 30 lux and backed up by an emergencey lighting system providing a horizontal illuminance at floor level of not less than 2 lux. The design of the emergency lighting system should comply with

the Code of Practice for Minimum Fire Service Installations and Equipment. 19. All windows shall be upgraded to current standard. 20. All steel staircases having a minimun 1 HR. F.R.P. to comply with FRC 1996

FIRE SERVICES NOTES: (FOR MAGISTRACY BUILDING)

All existing F.S. systems to be renewed as stated below: -

A. FH/HR system

1. FH/HR system consisting of hydrants and hose reel at position indicated on plan will be installed in accordance with H.K.F.S.D. Code of Practice as effective from July 2005 to serve the entire

2. One no. of new 36,000 litres FH/HR tank will be provided as

indicated on plan to serve the FH/HR system. 3. Two fixed fire pumps (Duty / Standby) will be provided at F.S. and

sprinkler pump room as indicated on plan.

4. Three nos. of F.S. inlet shall be provided as indicated on LC/F plan.

5. Fire hydrant shall be single outlet type and provided at position as indicated on plan, the pressure at any fire hydrant outlet shall between 350kPa to 850kPa

6. Fire hose reel and hydrants will be installed at a position so that every part of premises except the F.S. and sprinkler pump room can be reached by length of not more than 30m of hose reel tubing or fire services hose.

B. Automatic sprinkler system

1. An automatic sprinkler system will be provided in accordance with the L.P.C. rules BS EN 12845 2003 and FSD C.L. 3/2006 to protect the entire building except all E/M plant rooms, lift shaft, pipe ducts and electrical ducts.

2. One no. of new 47,000 litre water tank will be provided to serve the automatic sprinkler system. The classification of occupancies to be Ordinary Hazard 1.

3. One no. of sprinkler control valve c/w one no. of sprinkler inlet will be provided as indicated on LG/F plan.

4, Direct line to FSCC shall be provided

C. Fire alarm and detection system 1. Manual fire alarm system will be provided in according to FSD circular letter no. 1/2002 and BS 5839 : Part 1 : 1988. Manual

call point will only be provided as follows :-At each hose reel point;

) Adjacent to storey exits (exit point to each staircase);

iii) Adjacent to all exits to open air (at G/F only). 2. Fire detection system will be provided in according to FSD circular letter no. 1/2002 and BS 5839 : Part 1 : 1988 to cover all area not covered by sprinkler, such as E/M plant rooms and I.T. Server Rooms (with sprinkler). Fire detection system will not be provided for

lift shaft, pipe ducts and electrical ducts. 3. Visual fire alarm system in accordance with COP: Design Manual for barrier free access 2008 will be provided.

4. Main manual fire alarm panel will be provided at the Fire Control Centre at LG/F. All fire alarm signals will be connected to FSCC/Chubb centre through direct telephone link.

D. Portable fire extinguishers 1. Portable fire extinguishers will be provided as indicated on plan. E. Other Requirement

1. Any intend storage of use of the dangerous goods as defined in Chapter 295 of the Laws of Hong Kong will be notified to the Director of Fire Services.

2. When a ventilation / air conditioning control system to a building is provided, it shall be stop mechanically induced air movement within a designated fire compartment.

SCHEDULE OF DRAWINGS

DRAWING TITLE

LOCATION PLAN, NOTES & SCHEDULES

BLOCK PLAN & E.V.A. PLAN

LOWER GROUND FLOOR PLAN

GROUND FLOOR PLAN

FIRST FLOOR PLAN

SECOND FLOOR PLAN

THIRD FLOOR PLAN

FOURTH FLOOR PLAN

FIFTH FLOOR PLAN

ROOF PLAN

SECTION A-A

SECTION B-B

SOUTH ELEVATION

NORTH ELEVATION

WEST ELEVATION (FRONT)

EAST ELEVATION (REAR)

& COMPARTMENTATION)

CALCULATIONS (SITE COVERAGE, PLOT RATIO

DRAWING NO.

G-1

G-2

G-4

G-5

G-6

G-7

G-9

G-10

G-11

G-12

G-13

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G-15

G-17

3. A secondary electrical supply from emergency generator of sufficient capacity will be provided to maintain all essential services such as operation of fire service system and fireman's lifts in the event of normal power failure.

4. Emergency Generator Room will be provided as indicated on plan and standard requirements shall be fully complied with.

5. All electrical circuits are to be protected by miniature circuit breakers in lieu of conventional re-wireable fuses.

6. Emergency lighting will be provided and complied with BS 5266: 7. Sufficient exit sign and direction signs to ensure that all exit routes from any floor within the buildings are clearly indicated

as required by the configuration of staircase serving the buildings. 8. Lift marked 'A' will be arranged as fireman's lift. Such lift is to be provided with suitable switch to enable the FSD personnel to obtain complete control in the event of emergency and to be

clearly indicated on the outside.

Audio / visual advisory system will not be provided. 10. All linings for acoustic and thermal insulation purposes in ductings and concealed locations shall be of Class 1 or 2 Rate of Surface Spread of Flame as per British Standard 476: Part 7 or its international equivalent, or be brought up to that standard by use of an Approved fire retardant product.

11. All linings for acoustic, thermal insulation and decorative purposes within protected means of escape shall be of Class 1 or 2 Rate of Surface Spread of Flame as per British Standard 476: part 7 or its international equivalent, or be brought up to that standard by use of an Approved fire retardant product.

12. A 12 kg NAFS - III-Sprayer to be provided in the IT Service Room on 3/F a 16 kg NAFS - III Sprayer to be provided in the IT Service Room on C/F 13. A 1500 KVA Dry type or Silicon fluid-filled type transformer to be used in

LG/F Transformer Room. 14. 1 HR FRP Fire Damper to be activated by signal from fire detection system.

F. F.S. Notes: (For F.S. & Sprinkler Pump Room and AC Plant Room) 1. Fire detection system will be provided in according to FSD circular letter

no. 1/2002 and BS 5839 : Part 1:1988. All fire alarm signals to be transmitted to the main manual fire alarm panel at the Fire Control Centre at LG/F of the main building and via the D.T.L. to FSCC/Chubb centre. 2. Portable fire extinguishers will be provided as indicated on the plan.

3. Emergency lighting to be provided.

4. When ventilation for conditioning control system is provided, it shall stop mechanically induced air movement wihin a designated fire compartment.

5. Any intemded storage or use of dangerous goods as defined in chapter 295 of the laws of Hong Kong should be notified to the director of fire services.

LEGEND / ABBREVIATION

上李屋花園 (

1/2 HR. F.R.P. SELF-CLOSING DOOR W/ W.G. VISION PANEL 1/2 HR. F.R.P. SELF-CLOSING DOOR

1 HR. F.R.P. SELF-CLOSING DOOR

LOCATION PLAN 1:1500

DOOR W/ PLAIN GLASS UPPER PANEL

DIRECTION OF ARROW ON ALL STAIRCASES TO SHOW 'UP' EXCEPT OTHERWISE SPECIFIED

EXISTING/PROPOSED FINISHED LEVEL

PROPOSED STRUCTURAL LEVEL FIREMAN'S LIFT (MIN. LIFT CAR SIZE = 1.35m² W/. MIN. RATED LOAD OF 680kg)

ACCESSIBLE LIFT (MIN. LIFT CAR SIZE = 1.2m x 1.1m W/. CLEAN DOOR WIDTH = 750mm) F.H: O FIRE HYDRANT

H.R. 🔼 HOSE REEL EXIT SIGN

4.5kg CO2 FIRE EXTINGUISHER

WATER CLOSET \triangle

ARTIFICIAL LIGHTING & MECHANICAL VENTILATION

CABLE DUCT C.D.

P.D. PIPE DUCT FIXED WIRED GLASS LOUVRE

METAL LOUVRE 1/2 HR. F.R.P. FIXED CLEAR GLASS WINDOW

WITH INSULATION UNI-SEX ACCESSIBLE TOILET COLOUR INDICATION

SOLID CONCRETE BLOCK GLASS WORK METAL WORK

TILE WORK CEMENT RENDERING HARDCORE

SANITARY FITTING

mmm YIM Yuen-ling Senior Building Surveyor for BUILDING AUTHORITY

Plan Approved

1 6 AUG 2010

Plan Approved

YIM Yuen-ling Senior Building Surveyor for BUILDING AUTHORITY 1 2 AUG 2010

3021

22-3

B.D.

FPB

F.S.D. REF.

W.W.O. REF.

CONTRACTOR.

DO NOT SCALE DRAWINGS.

THE COMPLETION OF THE WORK.

BD 7TH AMENDMENT

BD 5TH AMENDMENT

BD 4TH AMENDMENT

BD 3RD AMENDMENT

BD 2ND AMENDMENT

BD 1ST AMENDMENT

FOR B.D. USE ONLY

SUBMISSION APPROVED

BD 5TH AMENDMENT APPROVAL

BD 4TH AMENDMENT APPROVED

BD 3RD AMENDMENT APPROVED

BD 2ND AMENDMENT APPROVED

BD 1ST AMENDMENT APPROVED

REVISIONS

ALL DIMENSIONS MUST BE VERIFIED AT THE WORK BY THE

ALL PRINTS, SPECIFICATIONS AND THEIR COPYRIGHT ARE THE

PROPERTY OF THE ARCHITECTS AND SHALL BE RETURNED AT

/09(HU)PT

16.7.10 R.M. W.1

12.04.10 R.M. W.T.

15.01.10 KAN W.T.

20.10.09 KAN W.T

04.9.09 KAN W.T.

17.7.09 KAN W.1

DATE DRAWN CHEC

10.5.10

10.02.10

16.11.09

30.9.09

13.8.09

6.6.09

NORTH KOWLOON MAGISTRACY NEW SCAD CAMPUS 292 TAI PO ROAD, KLN

LOCATION PLAN, NOTES & SCHEDULES

CHECKED APPROVED DATE 4 MAY 09 SCALE 1:100 (A1) JOB NO. DRAWING NO.

09002 G-1

LCK ARCHITECTS LTD 林陳簡建築師有限公司

VICTOR CHAN
陳麒仁建築師
B ARCH(HK) FHKIA RIBA FRAIM
REGISTERED ARCHITECT AP


SCHEDULE OF FIRE RESISTANCE PERIOD FOR ELEMENT OF CONSTRUCTION - BUILDING (CONSTRUCTION) (AMENDMENT) REGULATIONS 1996 LOCATION CLASS COMPARTMENT OF BUILDING R.C. COLUMN/HANGER MIN. SIZE COVER TO STEEL MIN. SIZE COVER TO STEEL THICKNESS COVER TO STEEL THICKNESS COVER TO STEEL LG/F PLANT ROOMS SLAB SEPARATION BETWEEN 75 30 200 G/F - 5/F SCHOOL < 28000m² 100 20 200 125 200 ELECTRICAL ROOM, PAU ROOM

SEPARATION BETWEEN REQUIRED STAIRCASE AND ADJOINING SPECIAL HAZARD TO HAVE 4HR FRP


REMARK: * NOT LESS THAN 1% OF VERTICAL REINFORCEMENT


CARPARKING PROVISION BUS / LOADING UNLOADING LGV LOADING UNLOADING 0 PRIVATE C.P. 22 8 MOTORCYCLE C.P. ACCESSIBLE C.P.

The works shown on these plans are Type II works in respect of which consent is applied for the purpose of Fast Track consent application under regulation 33 of the Building (Administration) Regulations

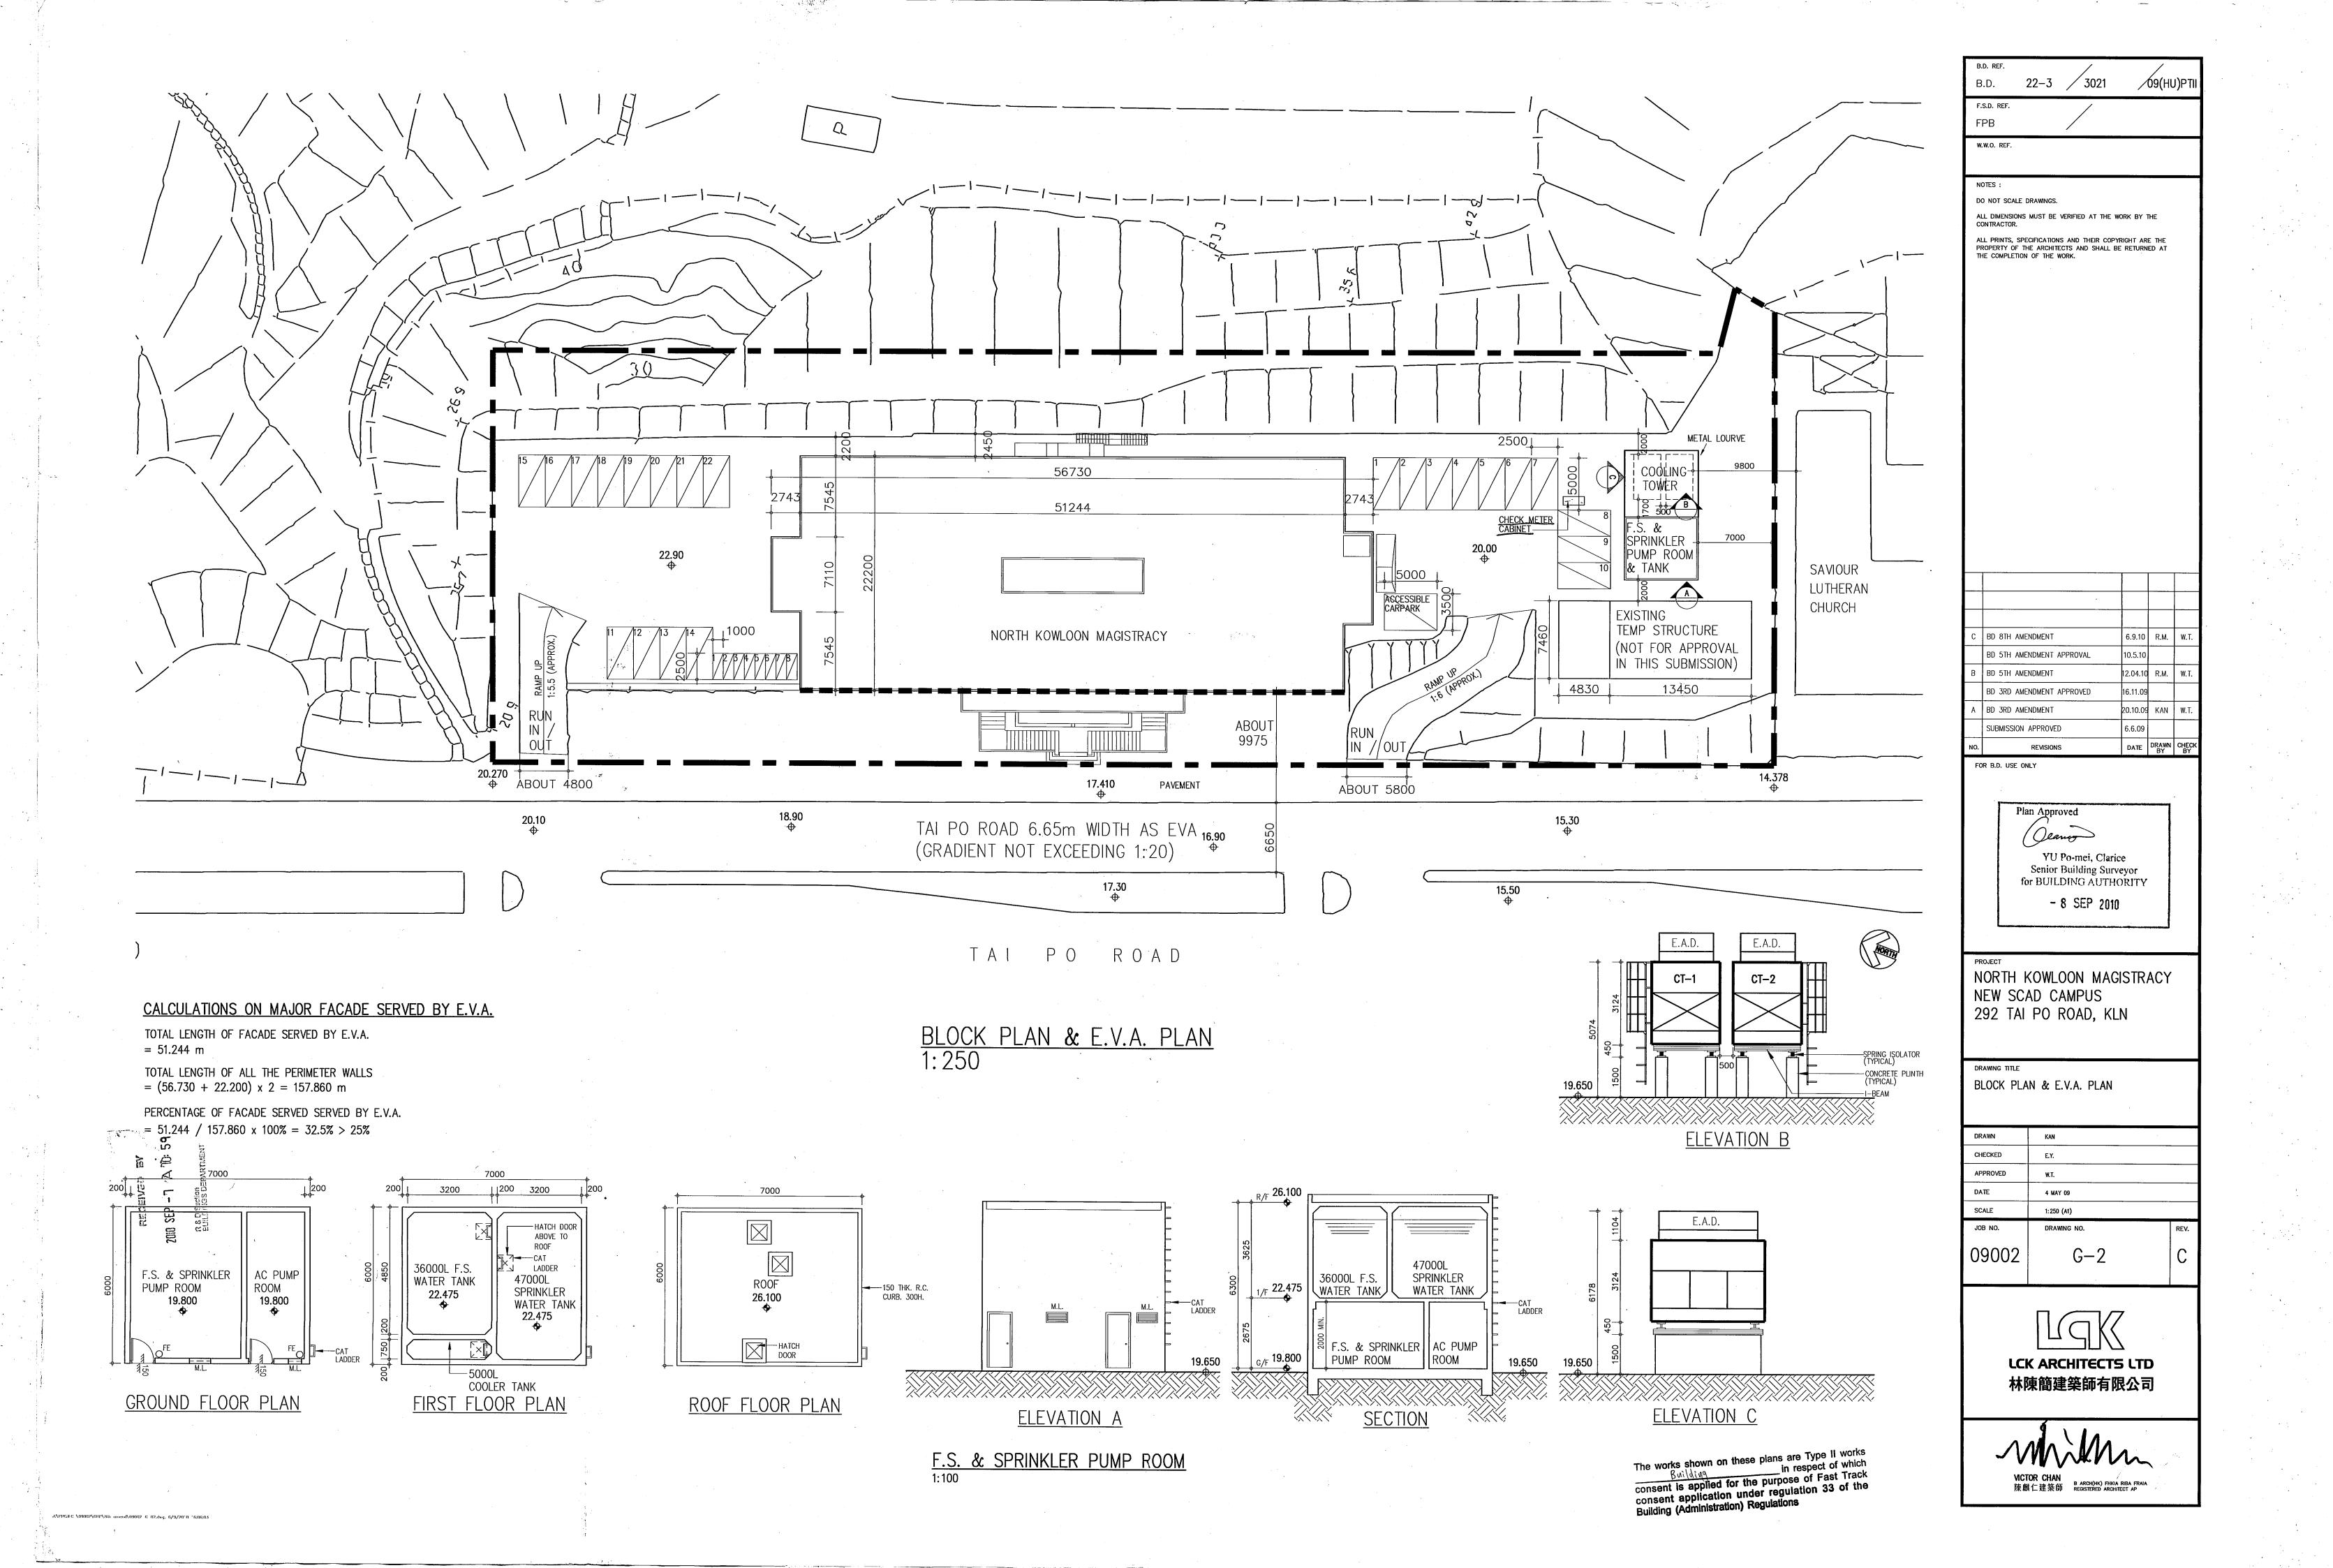



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Permit No. & Issue Date	Description	Granted Condition						B.D. 22-3 3021 09(HU)
HK 336/2009(MOD) (A) 26 June 2009	exemption from payment of	- N/A						FPB
	pians.	The said works to be carried out in accordance with Plans approved on 26 Jun 09 under BP ref: 22+3/302/09(file	J) F					W.W.O. REF.
(B)	reduction/omission in standard of natural lighting	(i) Artificial lighting and mechanical ventilation on fresh air supply at a rate of not less than 1.1L/s/m² or 10L/s/person for all ancillary office and 10 air	G-1;	5 B			. }	NOTES : DO NOT SCALE DRAWNGS.
	offices.	satisfaction of the Building Authority. (ii) The fresh air intake should be placed where the air is		6-12	· · · · · · · · · · · · · · · · · · ·			ALL DIMENSIONS MUST BE VERIFIED AT THE WORK BY THE CONTRACTOR.
(C)	B(P)R 36 to permit the reduction/omission in standard of natural lighting	free from contamination or odour. The location of fresh air intake should meet the following requirements: 1. it should not be located within 5m from other		SITE BOUNDARY				ALL PRINTS, SPECIFICATIONS AND THEIR COPYRIGHT ARE THE PROPERTY OF THE ARCHITECTS AND SHALL BE RETURNED AT THE COMPLETION OF THE WORK.
	and ventilation in all toilets.	sources of contamination such as exhaust outlets of the building or adjacent buildings, traffic, carparks, unloading bays, refuse chutes/refuse				$ \left(\begin{array}{c} (13) \end{array}\right) $	$ \overbrace{14}) \qquad \overbrace{15}) $	LEGEND:
* *		rooms, evaporative cooling towers, emergency generators, plumbing vents, kitchens, and toilets. 2. It should not be located below ground level or						==== EXISTING WORK TO BE REMOVED
		close to cooling towers. 3. It should face away from potential pollution sources.		1 2743	5537	5537 5690	1 2743 1	
		It should be protected from rain entrainment, and covered by a screen to prevent the entry of birds, rodents, and extraneous articles.	1					EXISTING WALL & DO
(D)	omission of natural lighting	Liii) The said works to be carried out in accordance with Permanent artificial lighting system with 30 lux min. approxighting level backed up by an emergency lighting 20 J	u a d	T T T T T T T T T T T T T T T T T T T	ISTING			NEW WALL & DOOR
	/	evel of not less than 2 lux. The design of the hander every lighting system should comply with the			MODIFY EXISTING EXISTING WINDOW TO LOUVER LOUVER	EXHAUST AIR	MODIFY EXISTING WINDOW TO, LOUVER	
		COP for minimum FS installation & equipment. The said works to be carried out in accordance with plans ap	inraved	F		LOUVER		
HK 481/2009(MOD) 17 September 2009	Sanitary Fitments, Plumbing, Drainage Works & Latrines)	on 26	Jun of	FF FF	5341 100 5623 RESH WATER 및 19.760	1100 3773		
	cleaning access to be other	with Plans approved on 17 Sep 09 under BD ref. 22-3/3021/09 (HU).	3021/01(10)	242 282 883 884 1985 1985 1985	JMP ROOM FE S	OPENING TO BE TO B	MODIFY EXISTING	F BD 8TH AMENDMENT 3.9.10 R.M.
(b)	than cleaning eyes. Building (Standard of	exemply many capability and a second capability and a		28	(D3) 680 (S7) (G) (G) (G) (G) (G) (G) (G) (G) (G) (G	2HR F.R.P / GENERATOI ROOM 19:760	T MANDOW TO AID / /	BD 7TH AMENDMENT APPROVAL
	Sanitary Fitments, Plumbing, Drainage Works & Latrines) Regulation 44(4) to permit	Significant in the second seco			FLUSHING WATER	FE TBE ROOM 8	F.S. INLET & SPRINKLER INLET	BD 6TH AMENDMENT 16.7.10 R.M. BD 6TH AMENDMENT APPROVAL
	protection of cast iron pipes to be other than asphaltic coating.	Fig. P. L. de Salakian A.	E	E UNEXCAVATED	PUMP ROOM 4292	5295 1922 1613	w/ sprinkler control valve 19.610	D BD 6TH AMENDMENT 4.6.10 R.M. N BD 5TH AMENDMENT APPROVAL 10.5.10
(c)	Building (Standard of Sanitary Fitments, Plumbing,					02	UFT 2514 229 1 1 21	C BD 5TH AMENDMENT 12.04.10 R.M. BD 3RD AMENDMENT APPROVED 16.11.09
	Drainage Works & Latrines) Regulation 50(2) to permit jointing of cast iron pipes to be other than lead caulking.	Company of the Control of the Contro		381		F.S. LIFT CONTROL LOB ROOM TO 19.7	BY LIT-1	B BD 3RD AMENDMENT 20.10.09 KAN
and the second s	be other than lead caulking.			D + +			19.610 FEATURE ABOVE	BD 1ST AMENDMENT APPROVED 13.8.09 A BD 1ST AMENDMENT 17.7.09 KAN
				200 396 396	19.760	\$ CARETAKER GLA	HR FRPM 150 SS PANEL 100 119,760 18	SUBMISSION APPROVED 6.6.09 NO. REVISIONS DATE DRAWN C
							tounty 25R FALL 122	FOR B.D. USE ONLY
HK 291/2010(MOD) 28 May 2010	B(A)R 33(1) for prior approval and consent to minor				CAT	255	90 1500 300 ACCES CARPA	
	amendments of Building, Structure and Drainage Works to the following	(b) AP/RSE should ensure that the minor amendments comply with the building regulations and the		23.	LADDER	3500 1000 5473	12	Pian Approved
(i)	Dullding (A&A)	proval Dene requirements of concerned government		B — — — — — — — — — — — — — — — — — — —	EXISTING AC PLANT	MAIN SWITCH TRANSFORMER ROOM	ST-1	YU Po-mei, Clarice Senior Building Surveyor
(iii (iv	i) Building (A&A) Amendment y) Building (A&A) Amendment	30.9.2009 (c) The amendments are regulated to be			ROOM	17.348	250 C-11	for BUILDING AUTHORITY
(vi (vi - (vi	i) Building (A&A) Amendment ii) (except skylight) iii) Drainage (A&A)	10.5.2000 clearly dacumented and deposited 17.9.2009			7274	2061 1439 5393		- 8 SEP 2010
(ix	and External Water Tank	14.10,2009		731	O _{FF} SHUTTER	100	F.L.	PROJECT
375/2010(MOD) (A	Amendment (a) B(C)R 8(2)(b) to permit the	This modification is given in recognition of the undertaking from the applicant dated 28 June			WATER METER	FE C	F.L.	NORTH KOWLOON MAGISTRACY
30 June 2010	protective barriers along the flights of the internal staircases at Entrance Hall &	2010. The internal staircases and adjoining Entrance Hall and Lobby/Student Resting Areas			ROOM	03 03 1 FE 0 9 4 45		NEW SCAD CAMPUS 292 TAI PO ROAD, KLN
	from G/F to 2/F be maintained at their existing	should be used in a manner as indicated on the approved plans and the said undertaking letter. The said works to be Carried out in accordance		A	NEW S.S.		RAMP	UP
(B)	height of not less than 0.9m. B(C)R 8(2)(c) to permit the	with plans approved on 30 June 2010 under BD ref. no. BD 22-3/3021/09 (HU)			Water Meter to	150H C.C. NEW S.S. DOOR	SIGN TO SHOW LOCATION OF F.S. LIFT	DRAWING TITLE LOWER GROUND FLOOR PLAN
	existing construction of the above-said protective barriers as to inhibit the	110 Br 22 7 7 3 - 1 (U10)			pe umbrid.	17.048 Ф		
	passage of articles more than 130mm in their smallest dimension.	The control of the co					RUN	DRAWN HO
481/2010(MOD) 16 August 2010	B(C)R 8(2)(b) to permit the protective barriers along the	This modification is given in recognition of the undertaking from the applicant dated 9 August 2010 & 12 August 2010. The external staircases	1 1 1 1 UP	UP	LOWER GRO	OUND FLOOR PLAN	IN // OUT	CHECKED E.Y. APPROVED W.T.
	Road be maintained at their	2010 & 12 August 2010. The external staircases adjacent Tai Po Road should be used in a manner as indicated on the approved plans and the said undertaking letter.						DATE 4 MAY 09 SCALE 1:100 (A1)
,	existing height of not less than 0.9m.	The said works to be carried out in accordance				16.860		JOB NO. DRAWING NO. RI
(B)	B(C)R 8(2)(c) to permit the existing construction of the above-said protective	With plans approved on 16 August 2010 under BD ref. no. BD 22-3/3021/09 (HU)				Ф PAVEMENT	Ψ	09002 G-3 <u>F</u>
	barriers as to inhibit the passage of articles more than 150mm in their smallest	THE STATE OF THE S						
(C)	B(C)R 8(3) to permit the	The state of the s				Т	he works shown on these plans are Type II works in respect of which	
	lowermost 150mm of protective barriers at the outer edges of landings at the above-said staircases not		R				onsent is applied for the purpose of Fast Track onsent application under regulation 33 of the building (Administration) Regulations	I CV ADCUITECTE I TO
(D)	the above-said staircases not built solid.		G-1	2			uilding (Administration) Regulations	LCK ARCHITECTS LTD 林陳簡建築師有限公司
(U)	Area & Library at G/F less (i	i) Provision of additional drainage channels, each with at least 2 no. of drainage outlets. ii) Provision of a fall, not less than 1:80 on the flat roof			\ 16.900 	TAI PO	ROAD	
The state of the s	than 150mm above the level of the external ground.	or external ground sloping away from the adjoining internal/usable floor area. The said to be carried out in accordance with plans						not - Inn
	ı	approved on 16 Aug lo under BD ref no. BD 22-313021/09 (HU)	G-1	3				VICTOR CHAN DE ONL OF THE ATT OF THE B ARCH(HK) FHKIA RIBA FRAIA
								陳麒仁建築師 B ARCH(HK) FHKIA RIBA FRAIA REGISTERED ARCHITECT AP

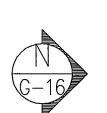


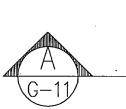


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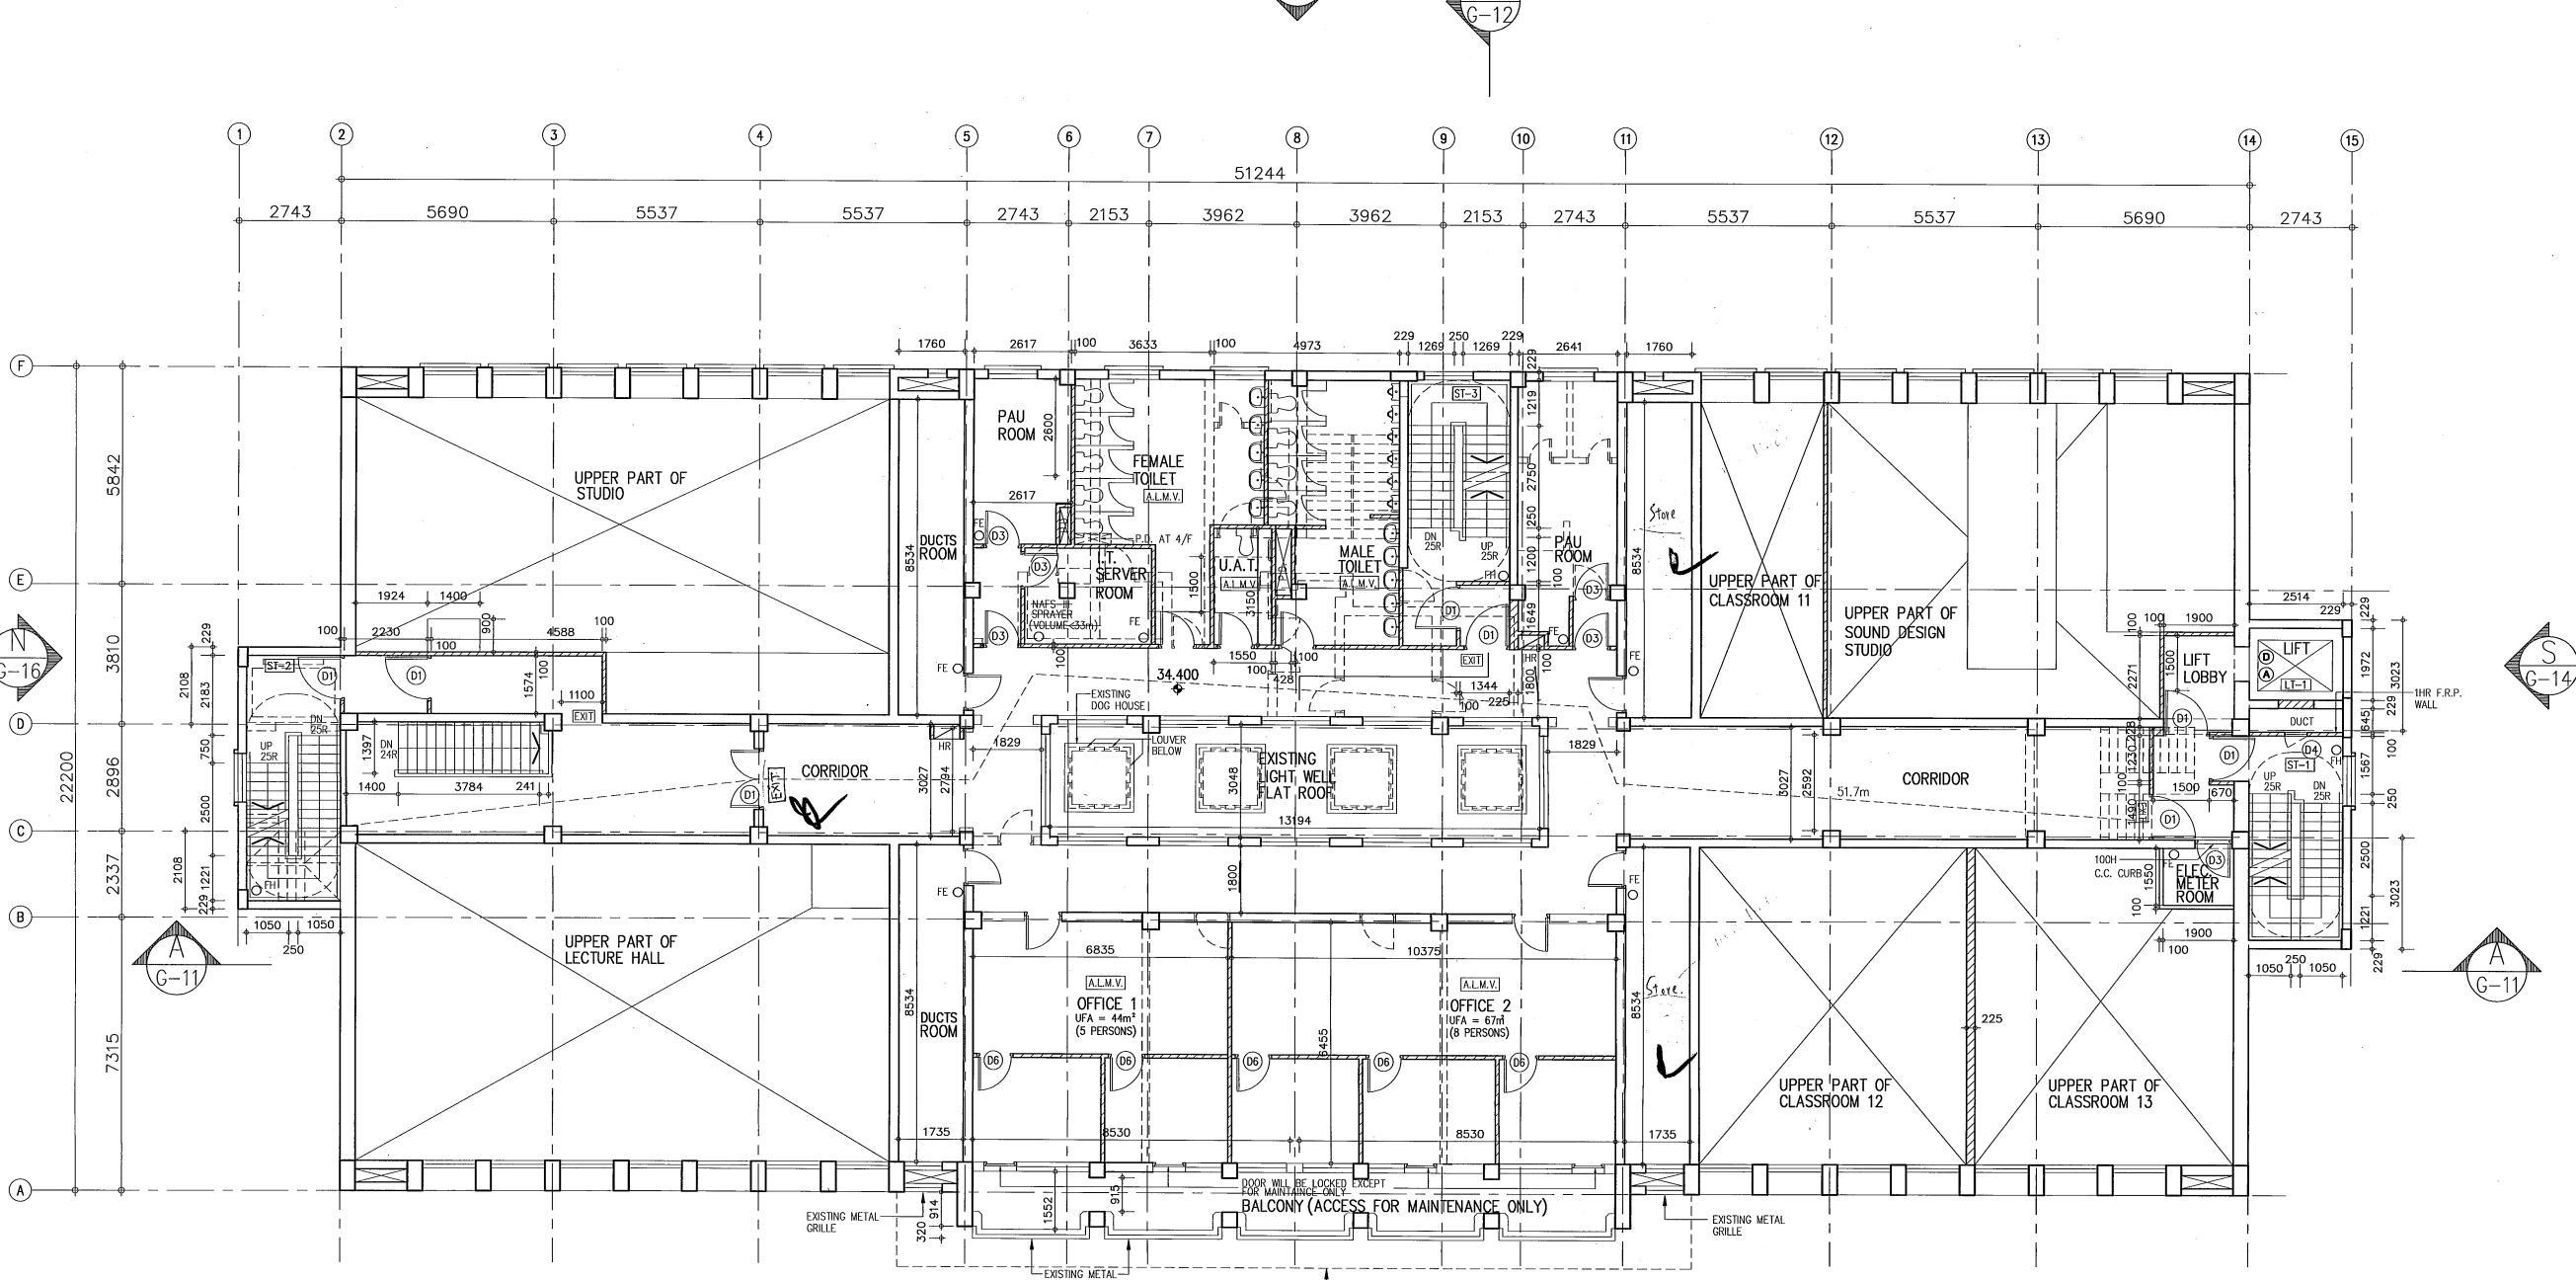
SECOND FLOOR PLAN

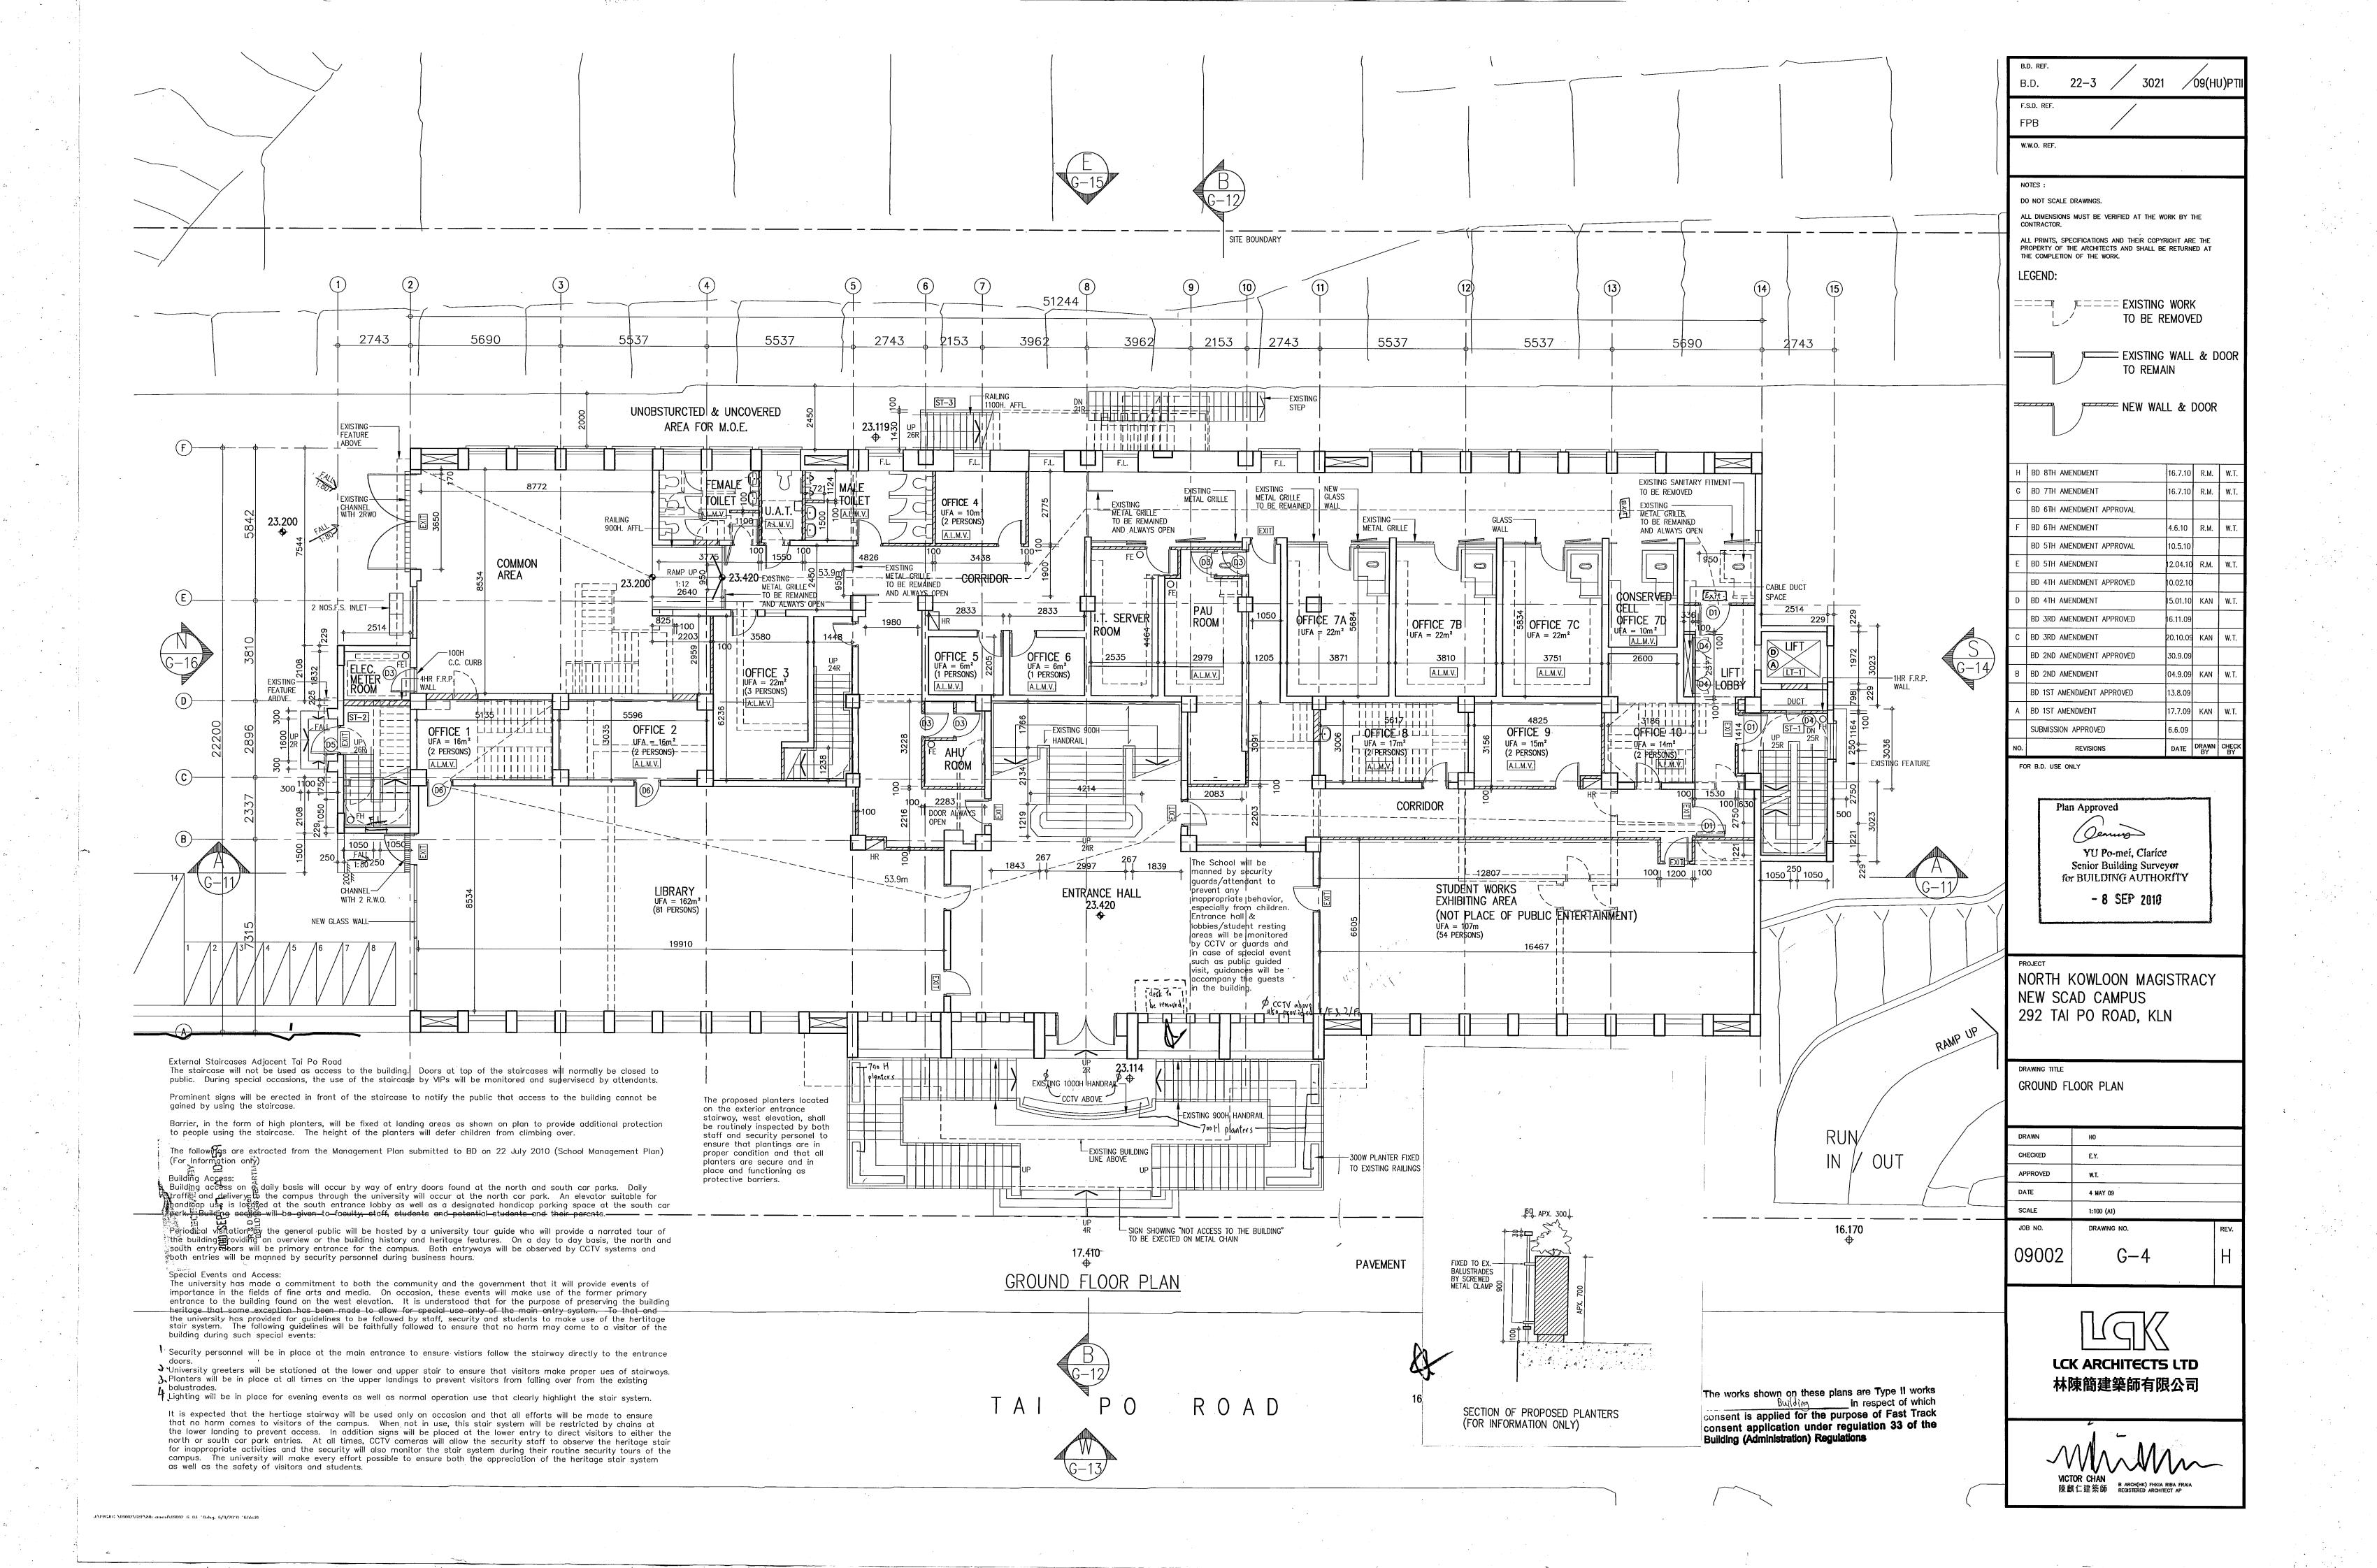

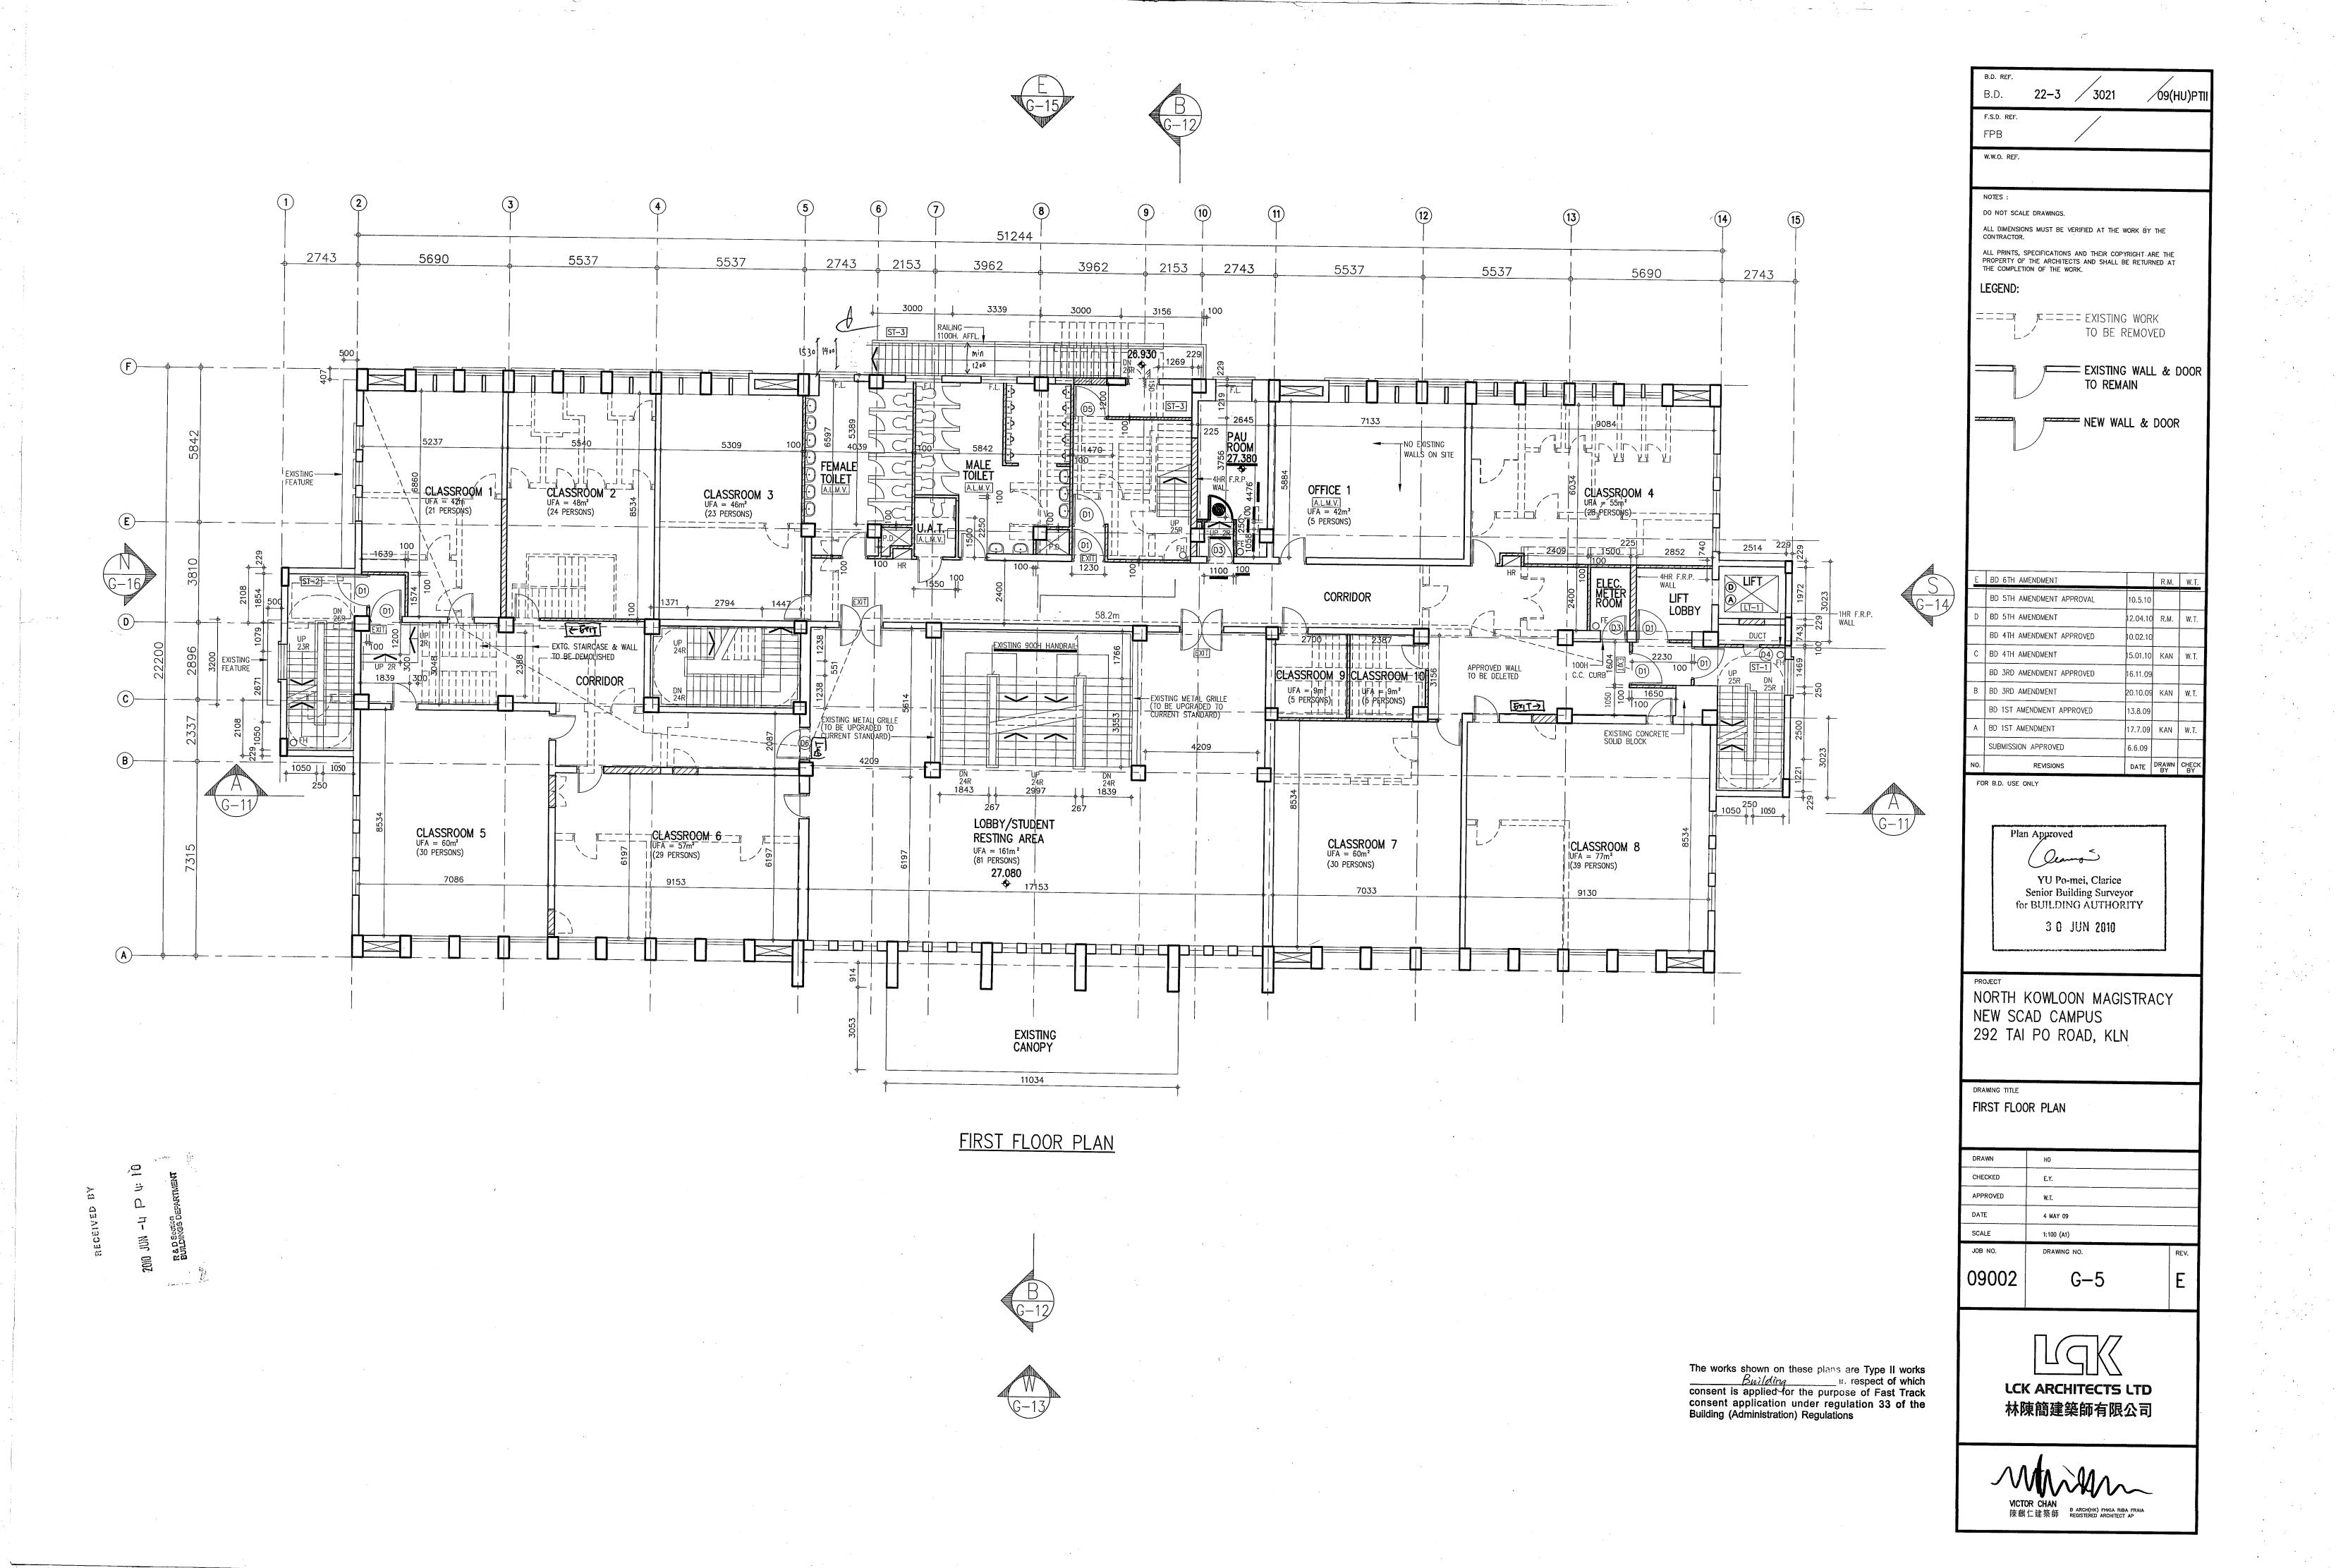

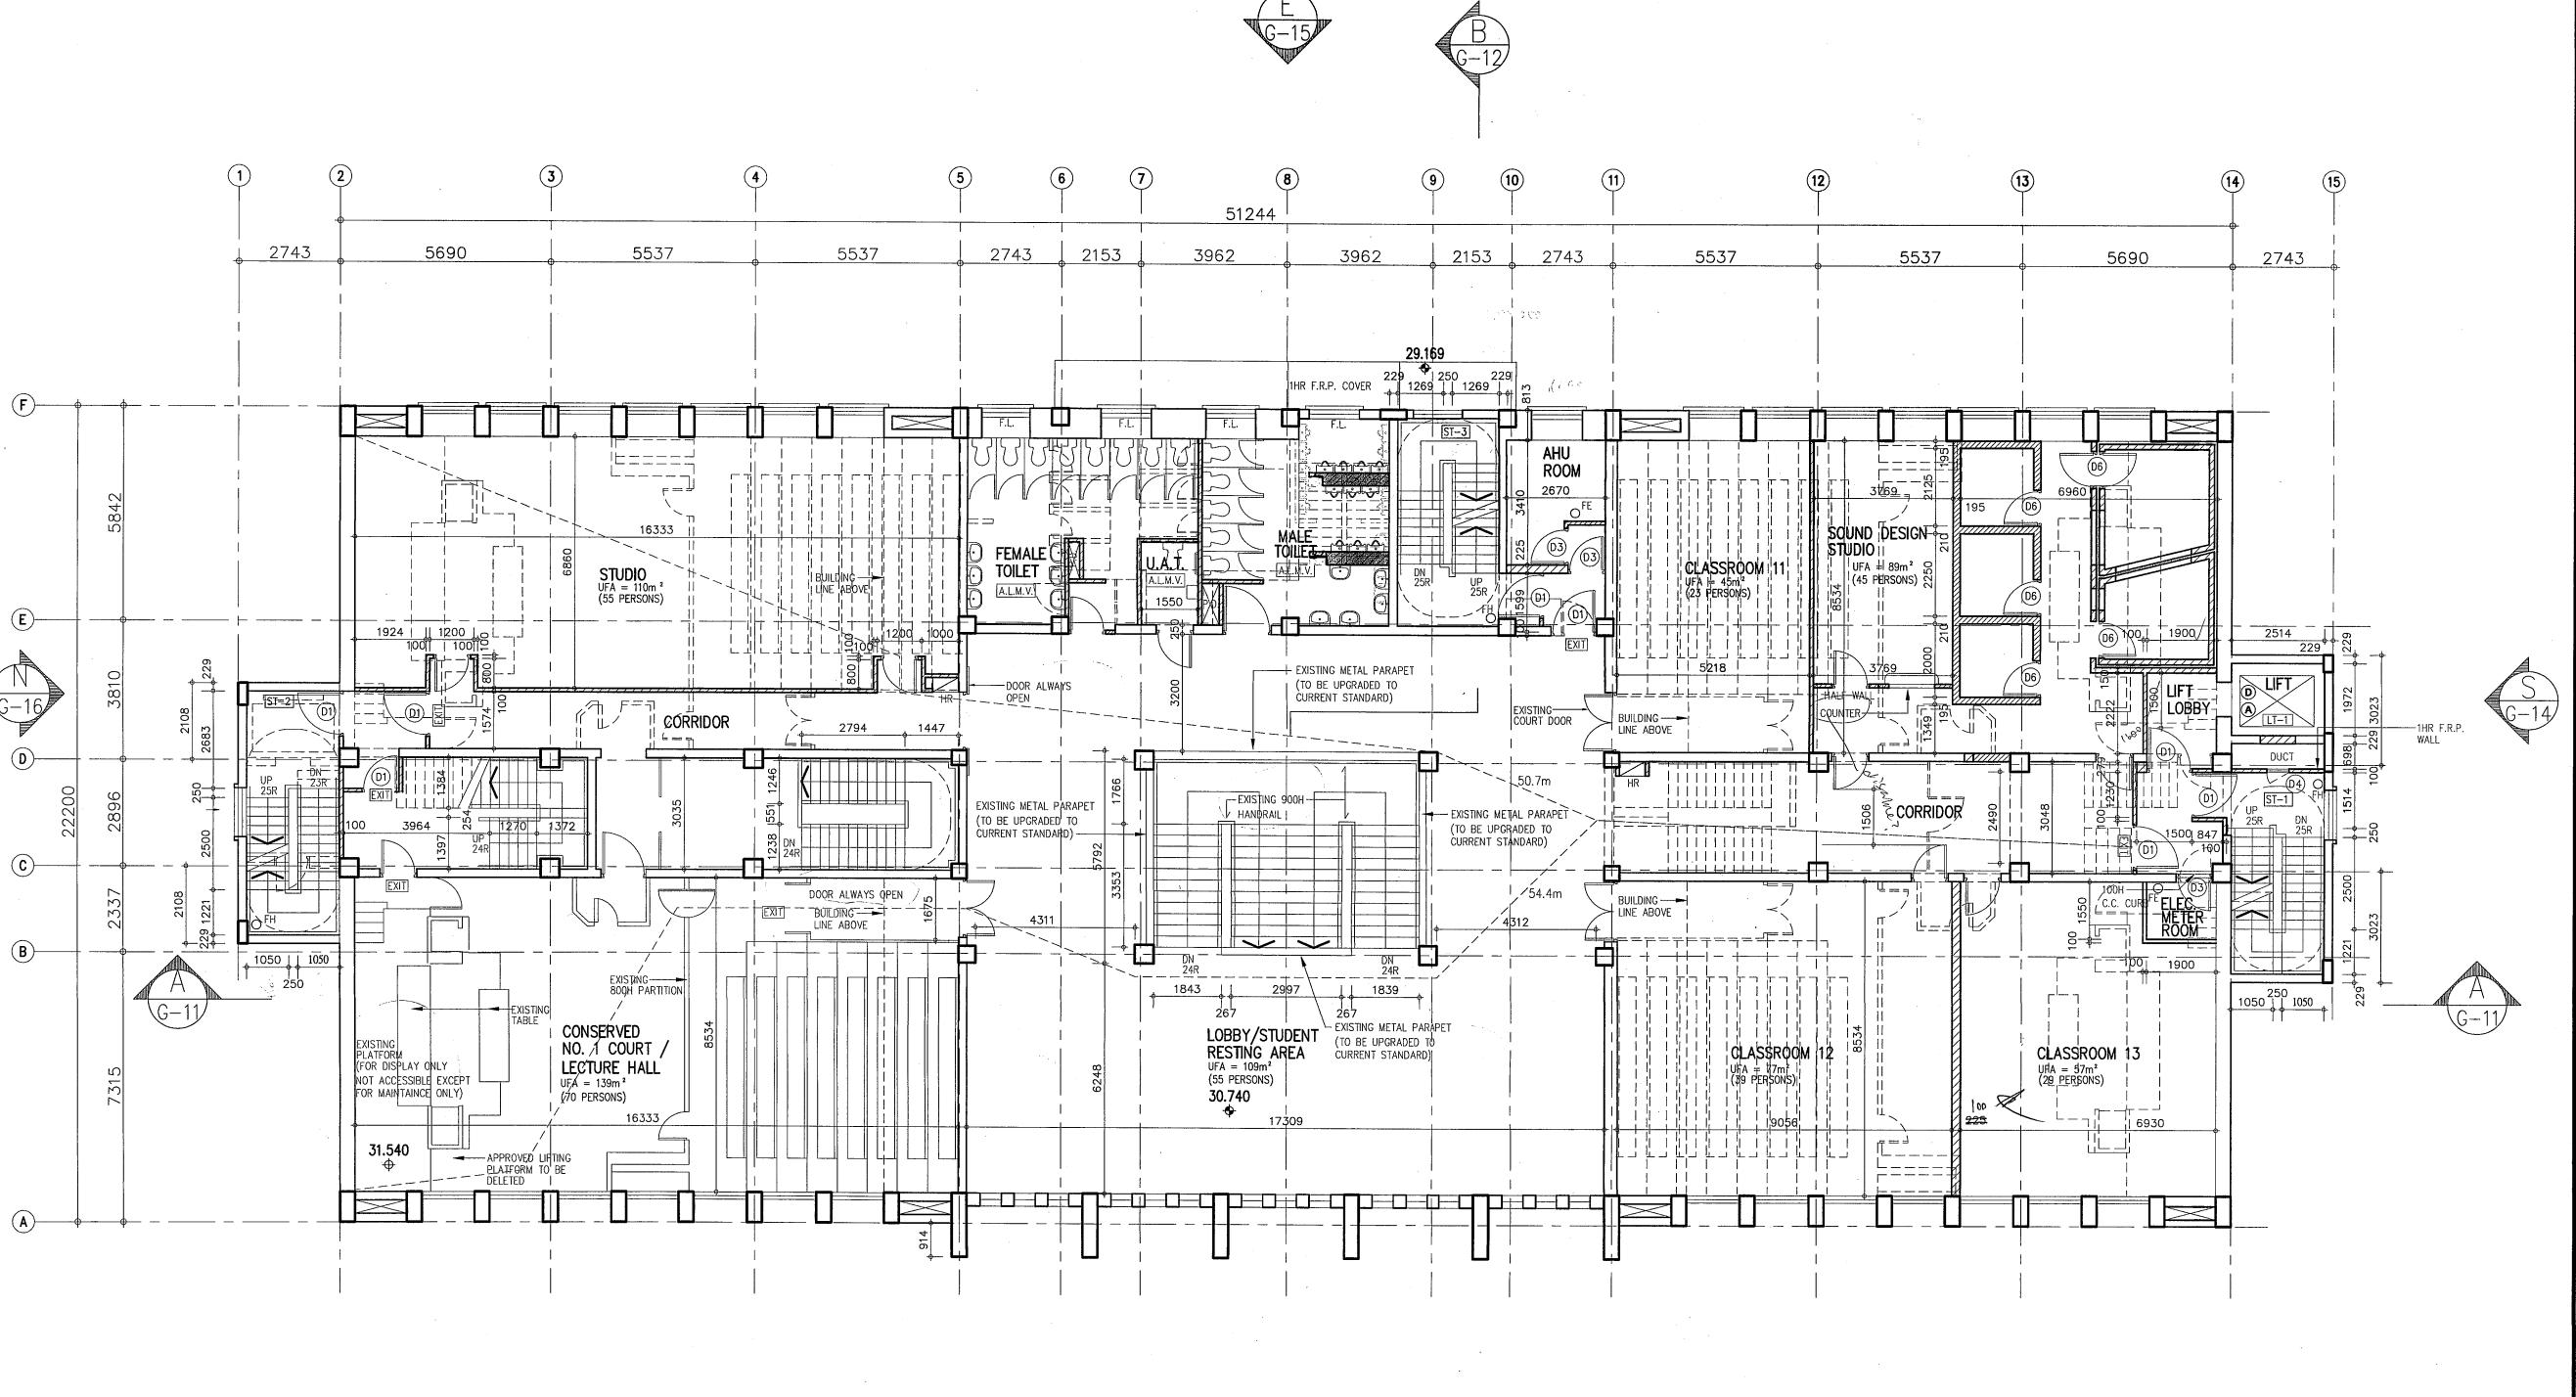
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С		MENDMENT		15.01.10		W.T.
		MENDMENT A	APPROVED	16.11.09		
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Α		MENDMENT		17.7.09	KAN	W.T.
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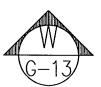
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THIRD FLOOR PLAN

17310 EXISTING CANOPY ABOVE

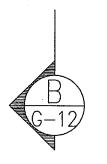



The works shown on these plans are Type II works in respect of which consent is applied for the purpose of Fast Track consent application under regulation 33 of the Building (Administration) Regulations
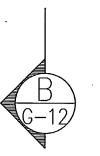
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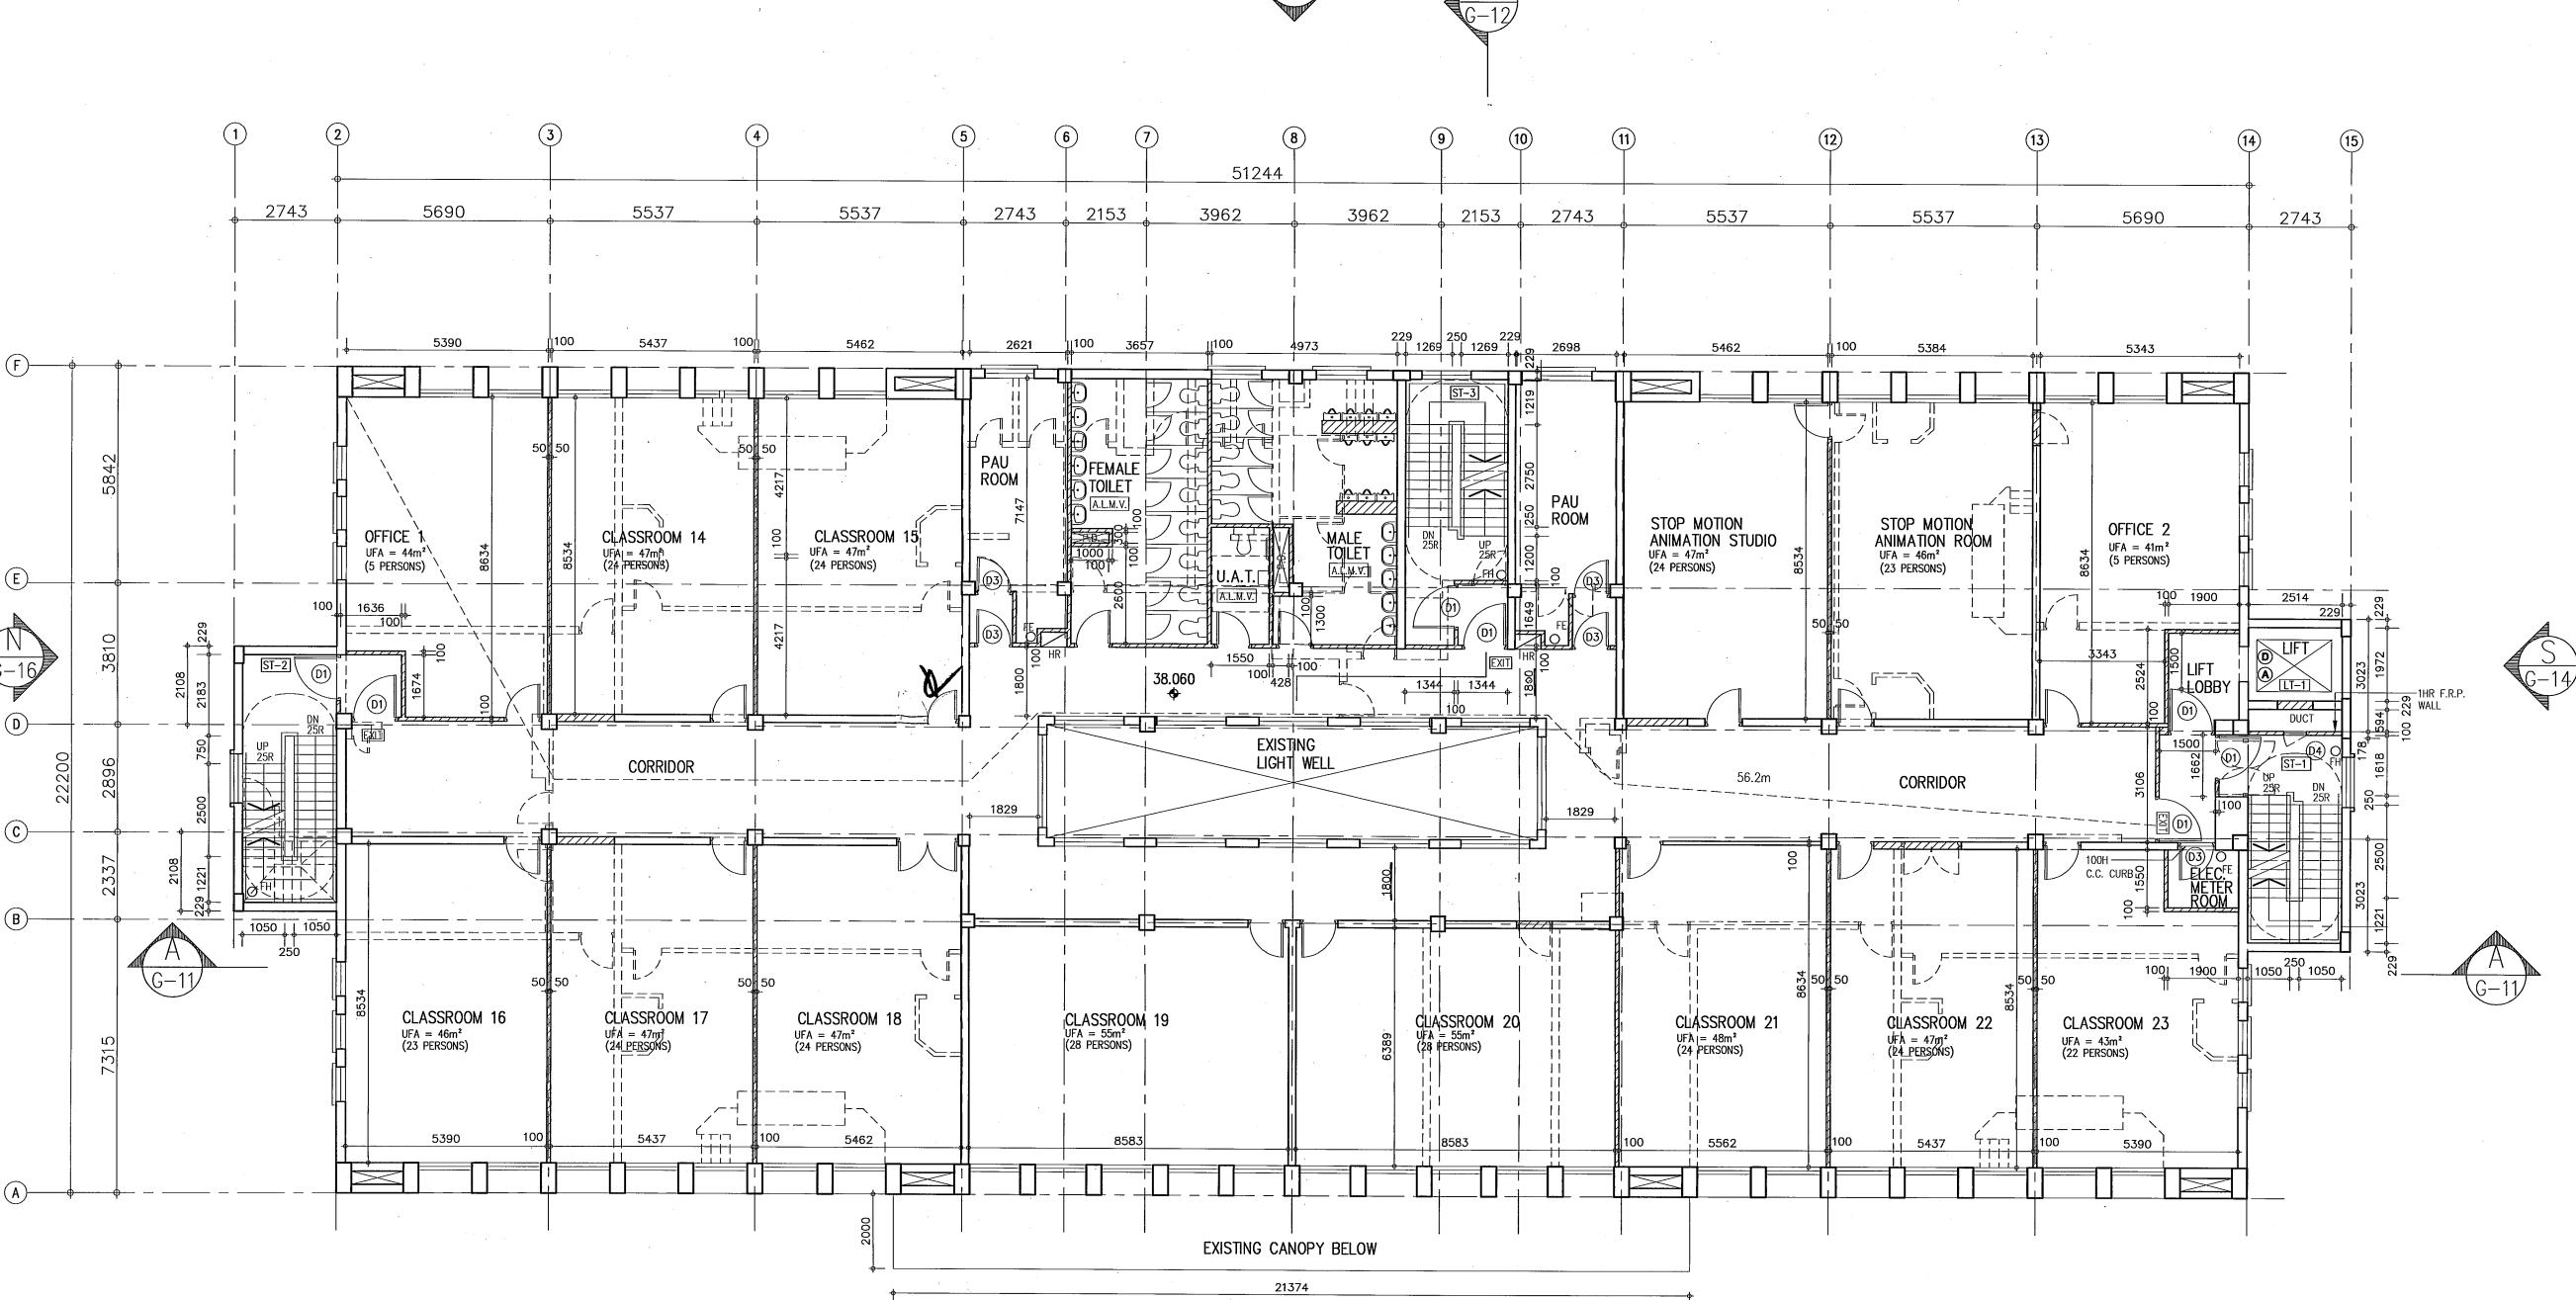
WCTOR CHAN

陳麒仁建築師


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FOURTH FLOOR PLAN






The works shown on these plans are Type II works in respect of which consent is applied for the purpose of Fast Track consent application under regulation 33 of the Building (Administration) Regulations

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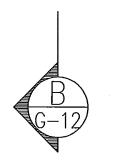
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FIFTH FLOOR PLAN
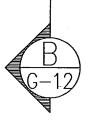
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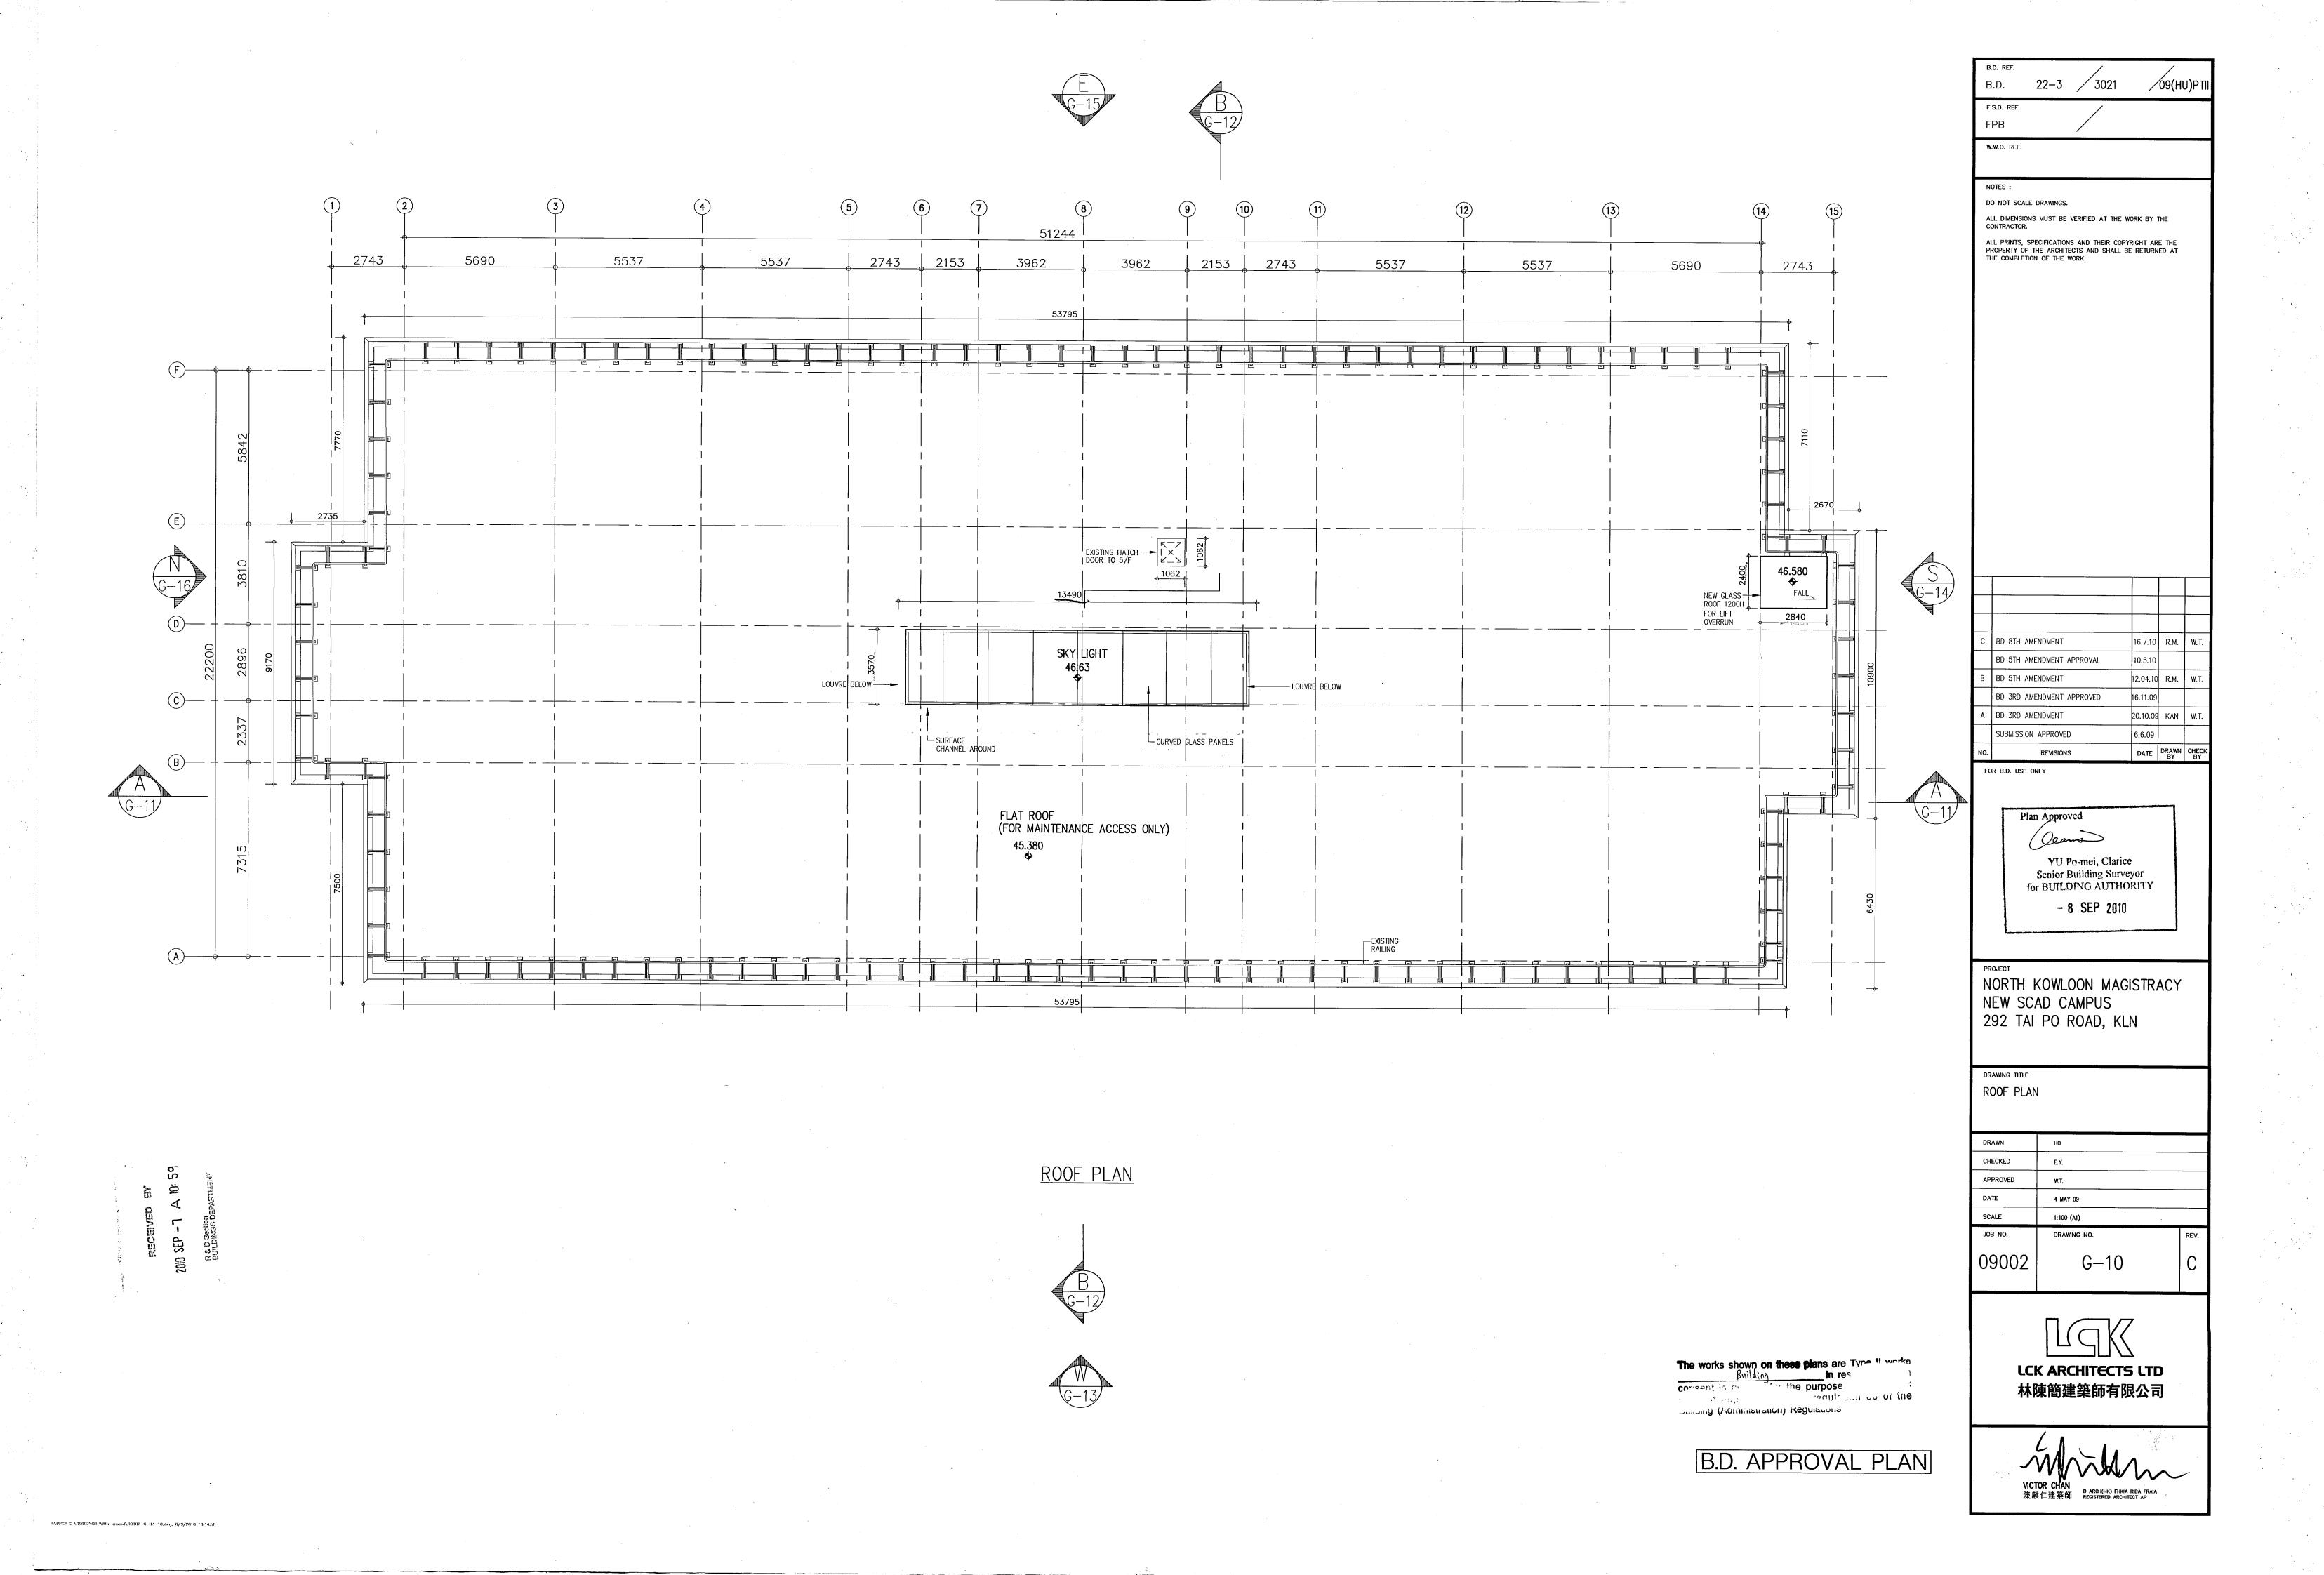





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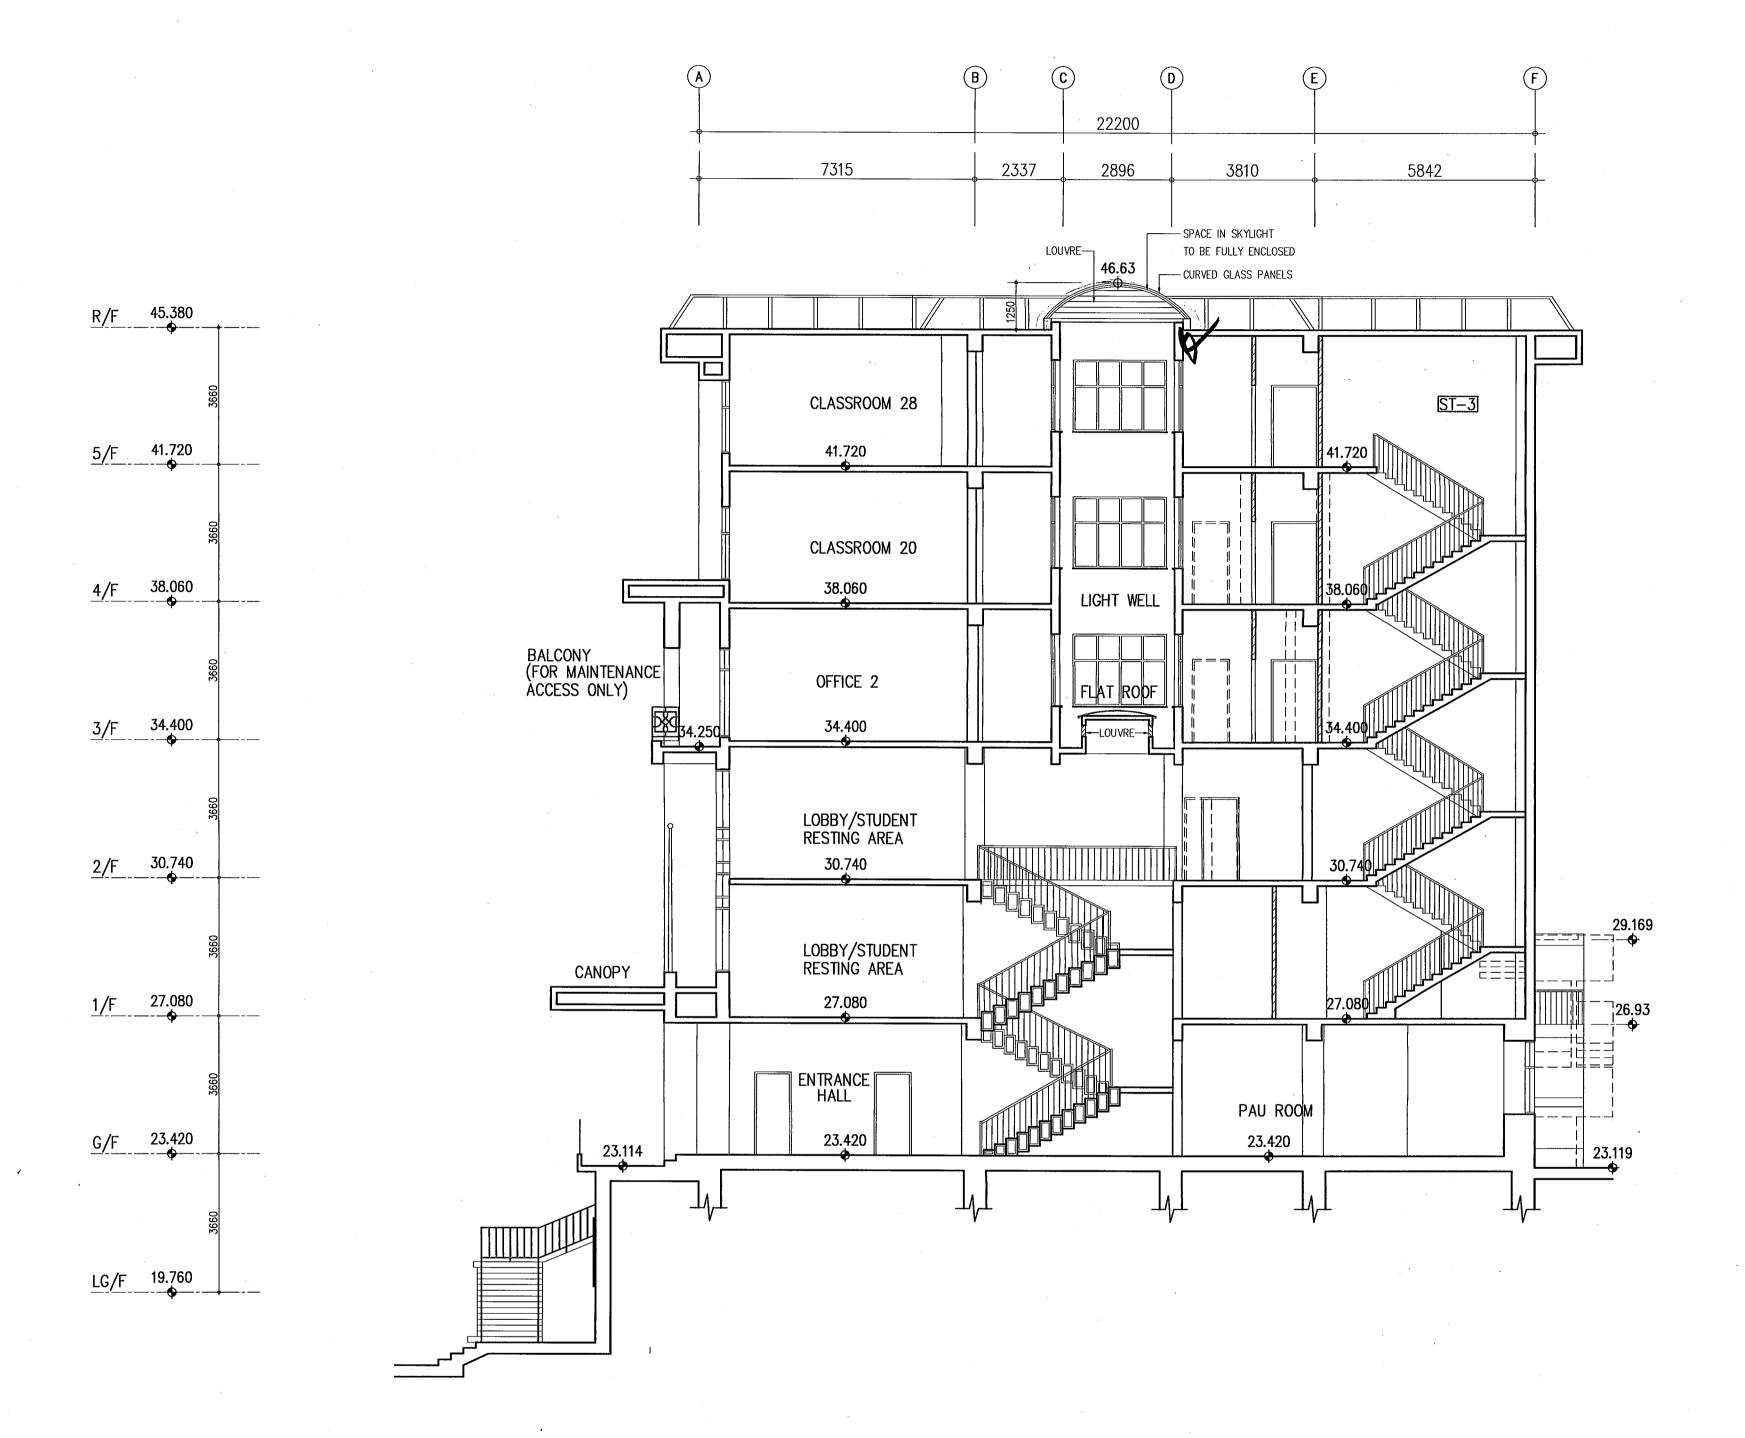


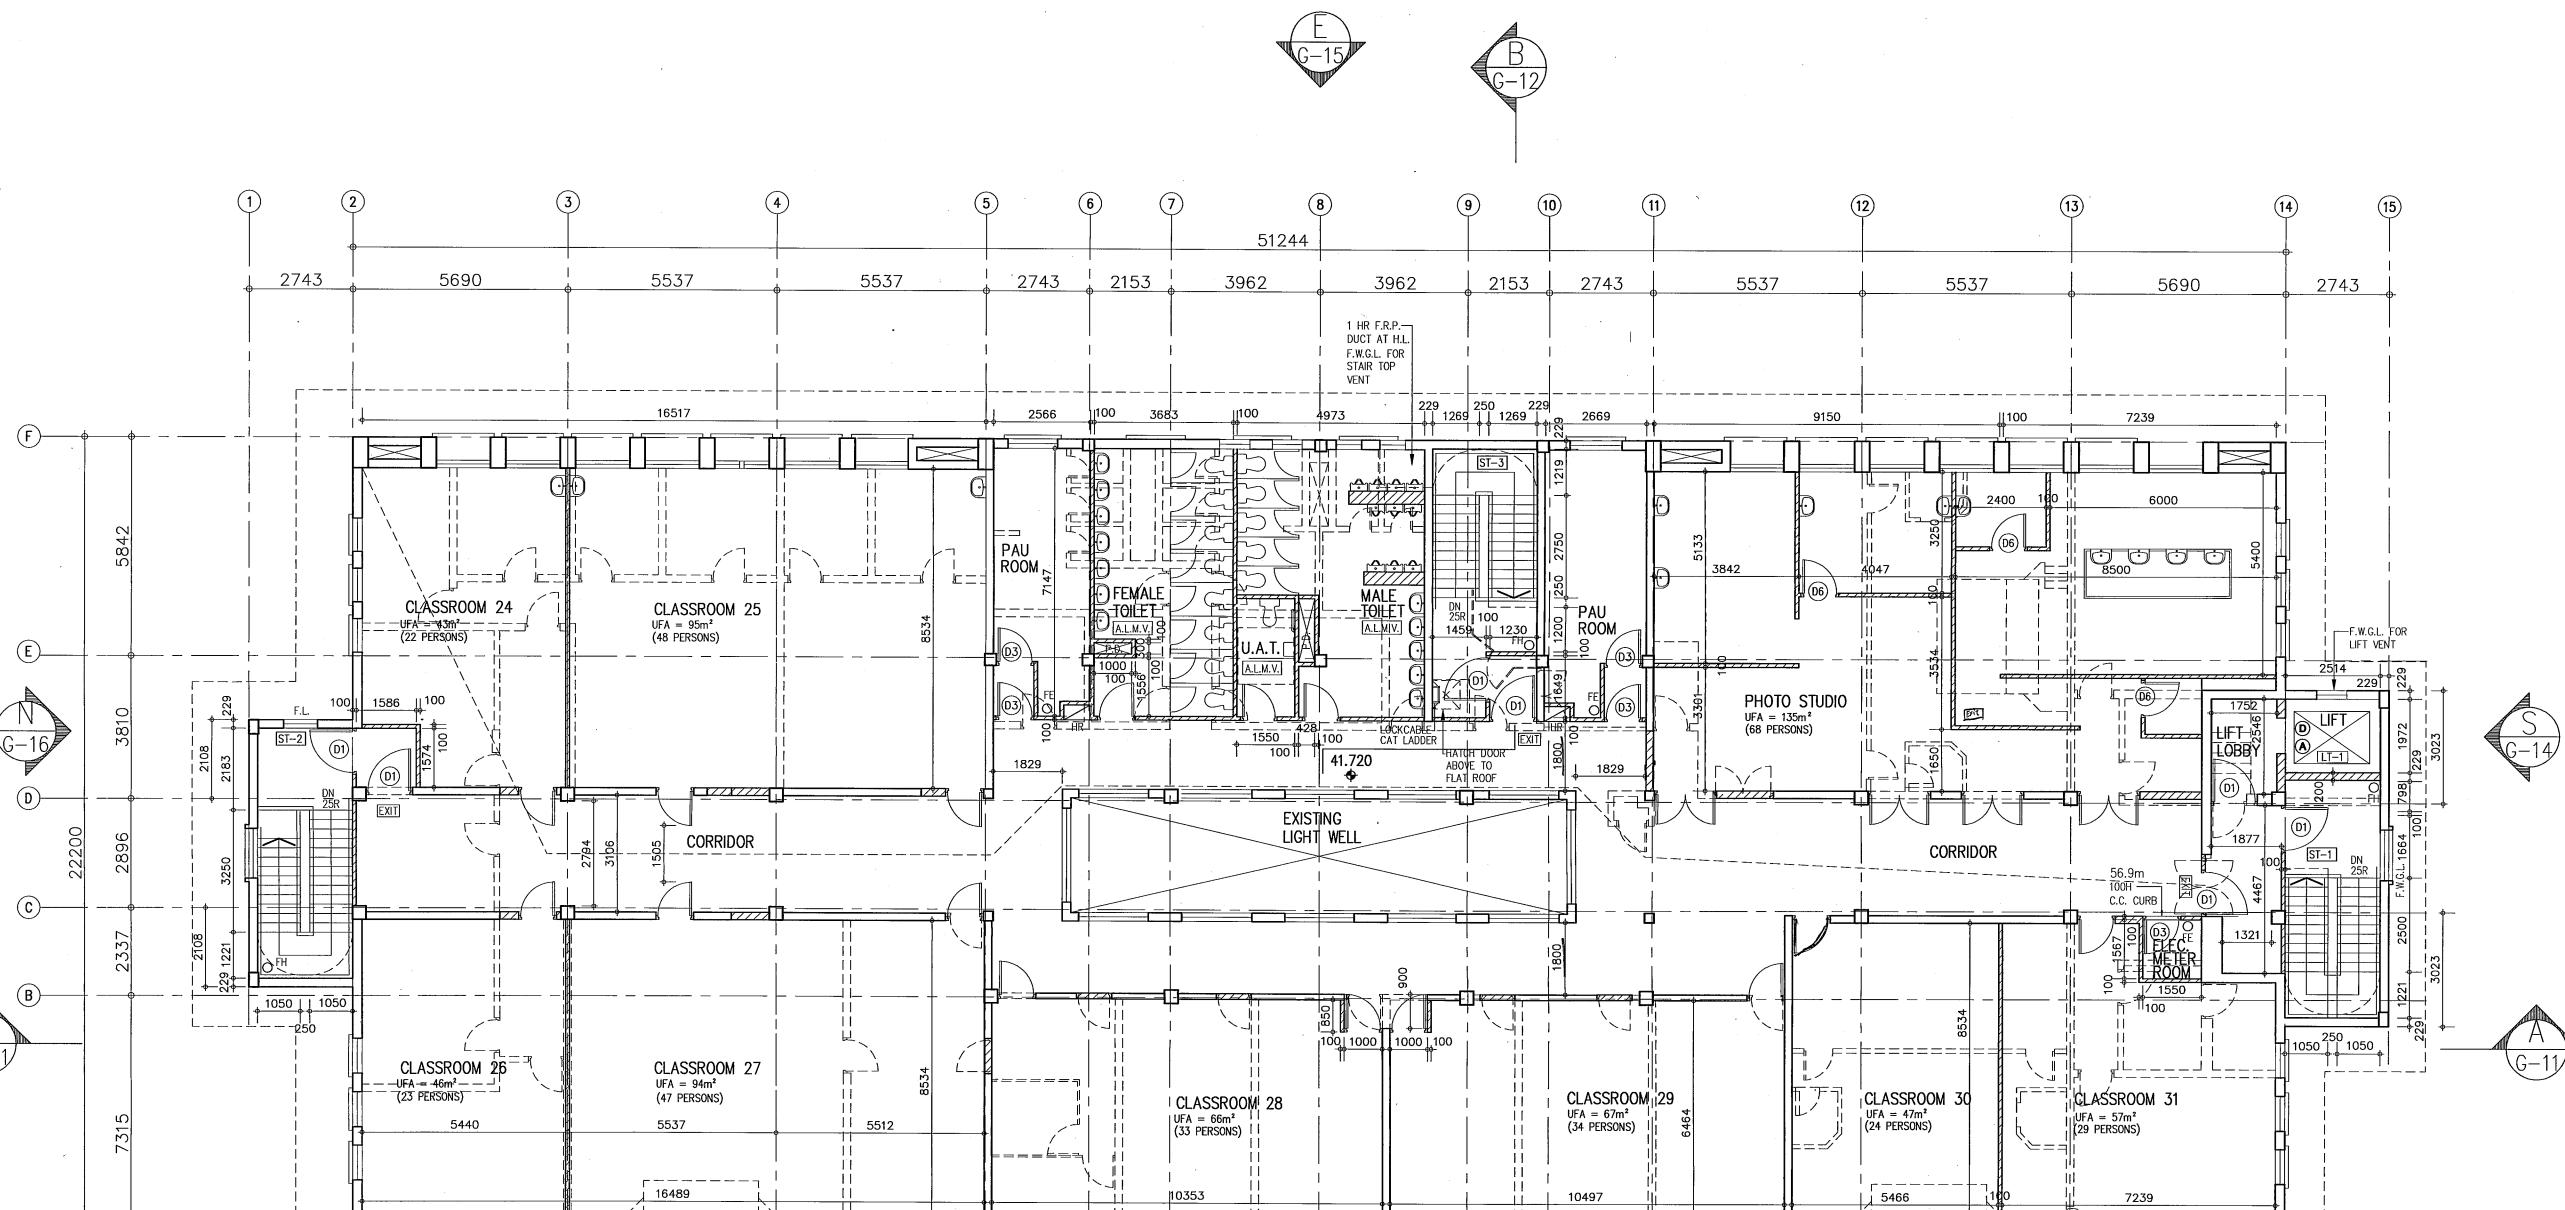

SECTION A-A

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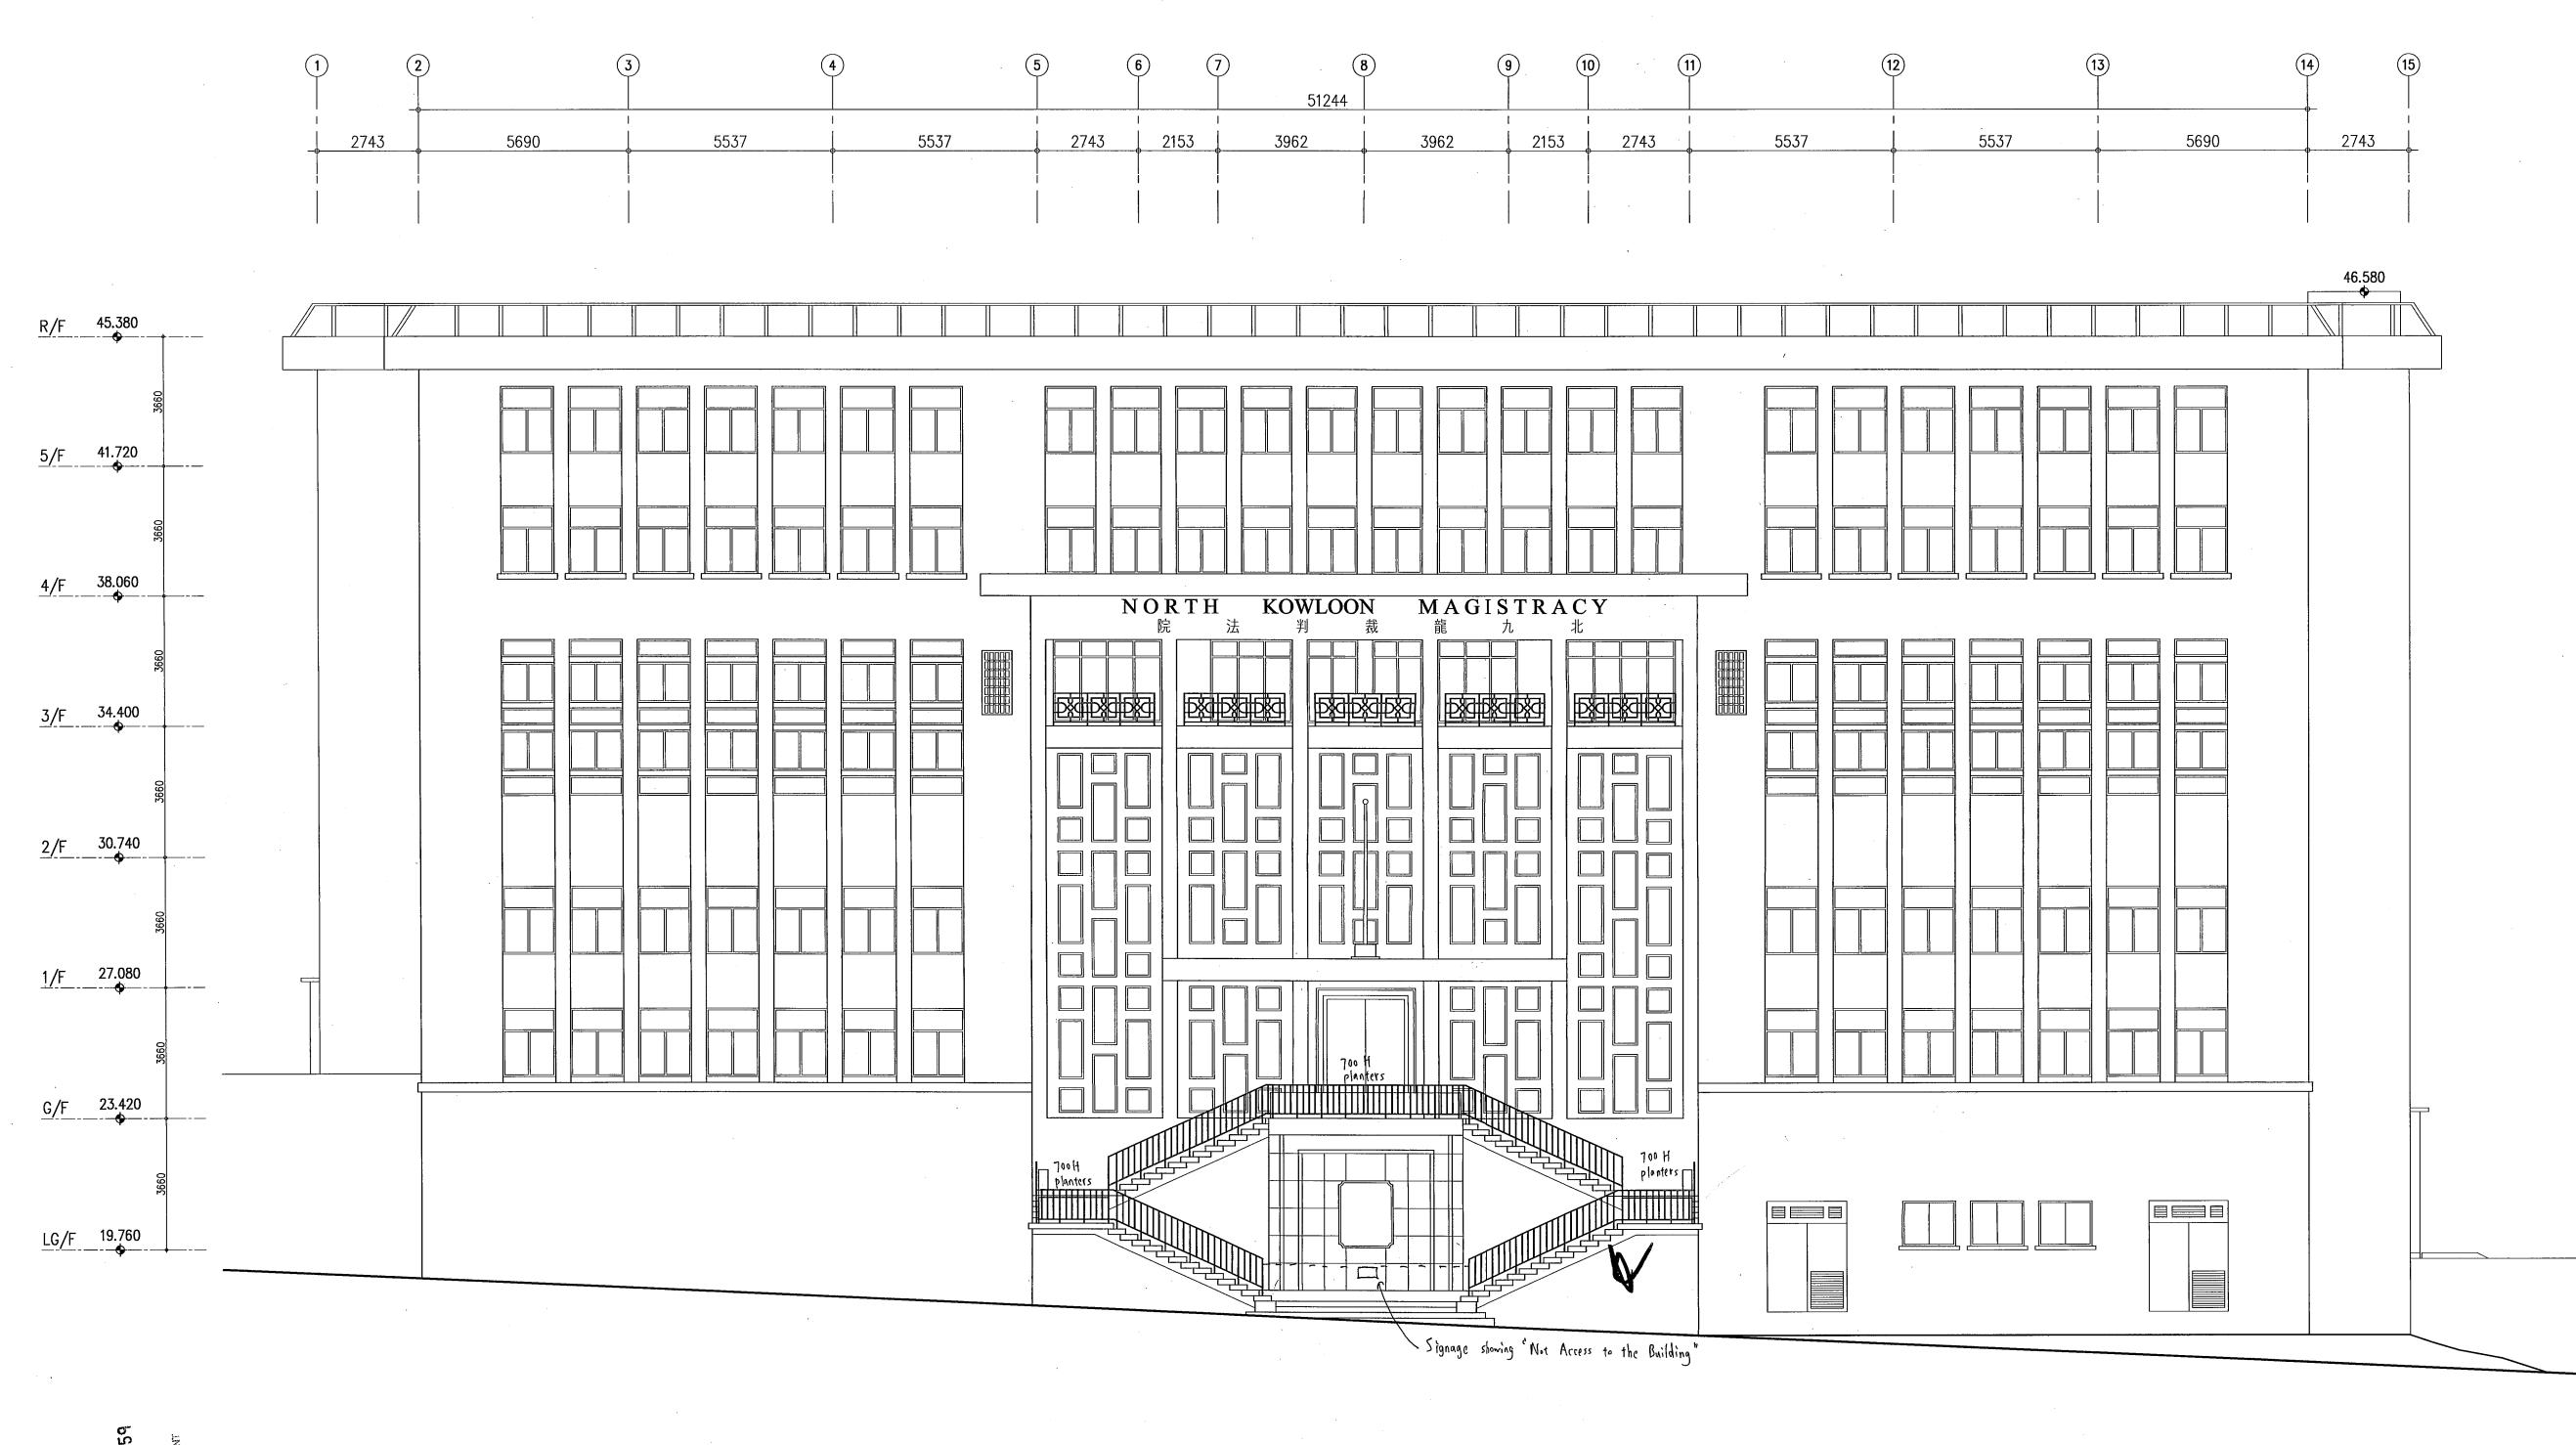
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NEW SCAD CAMPUS 292 TAI PO ROAD, KLN
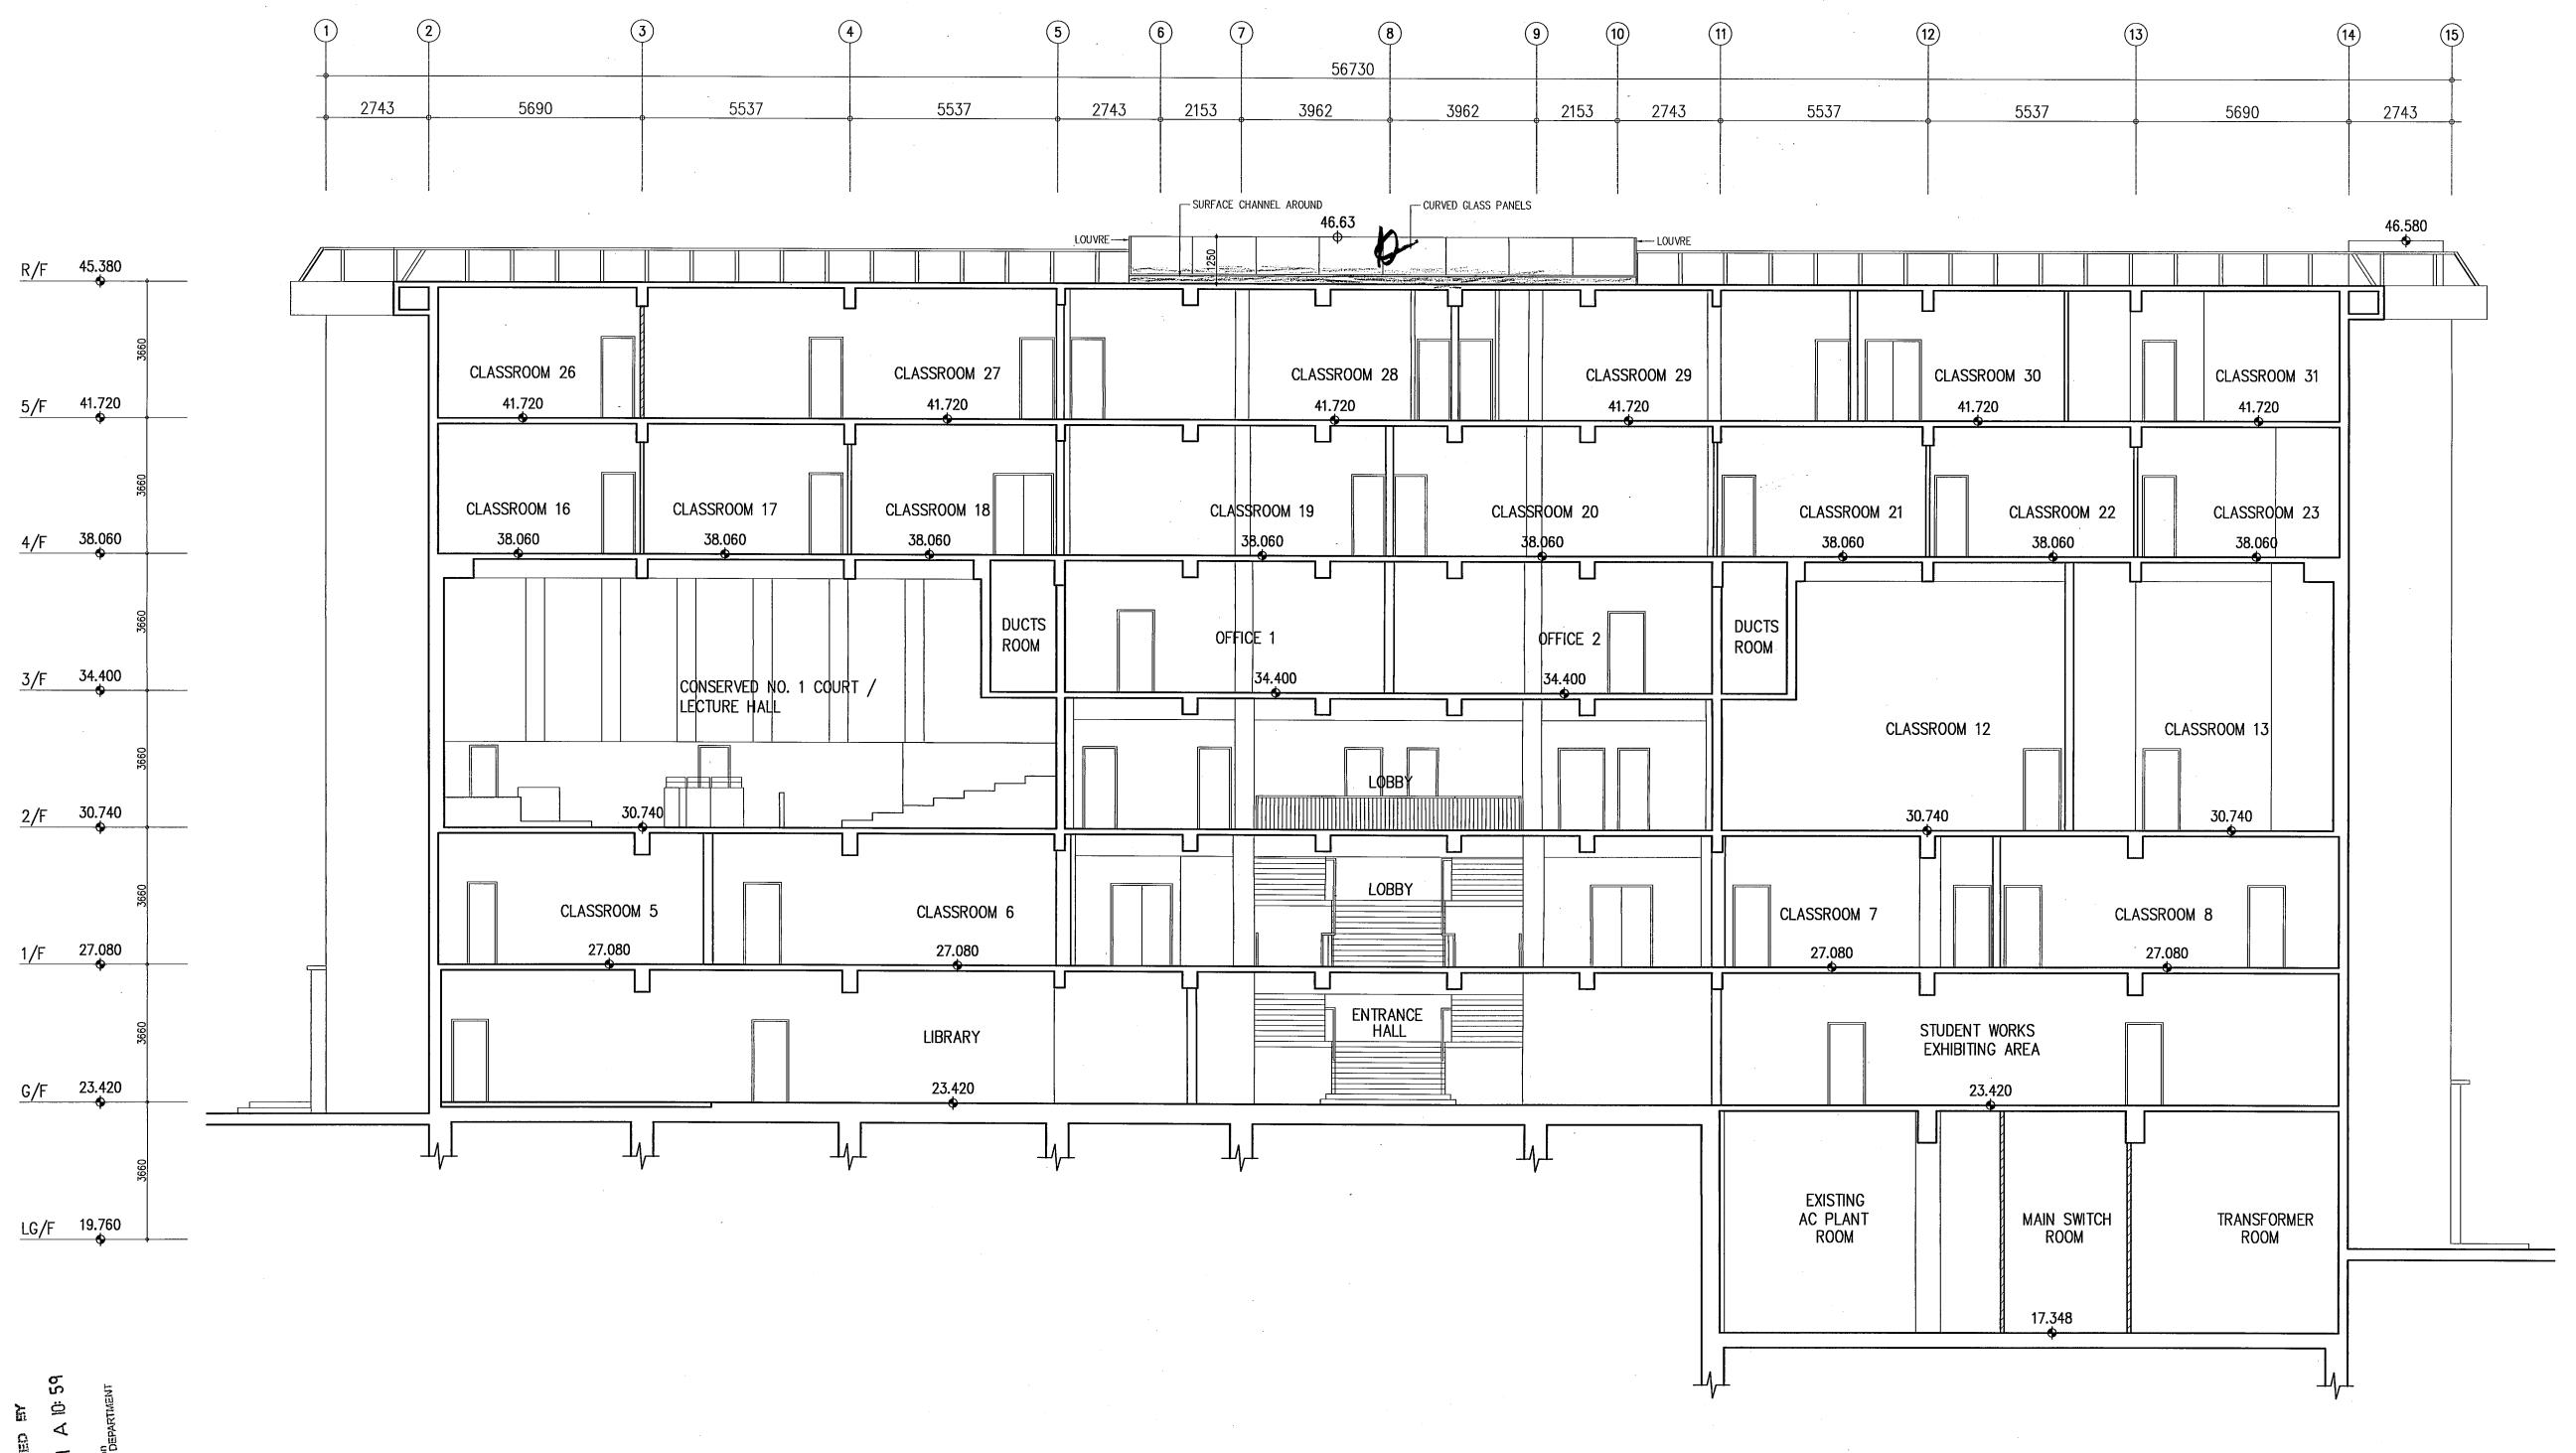
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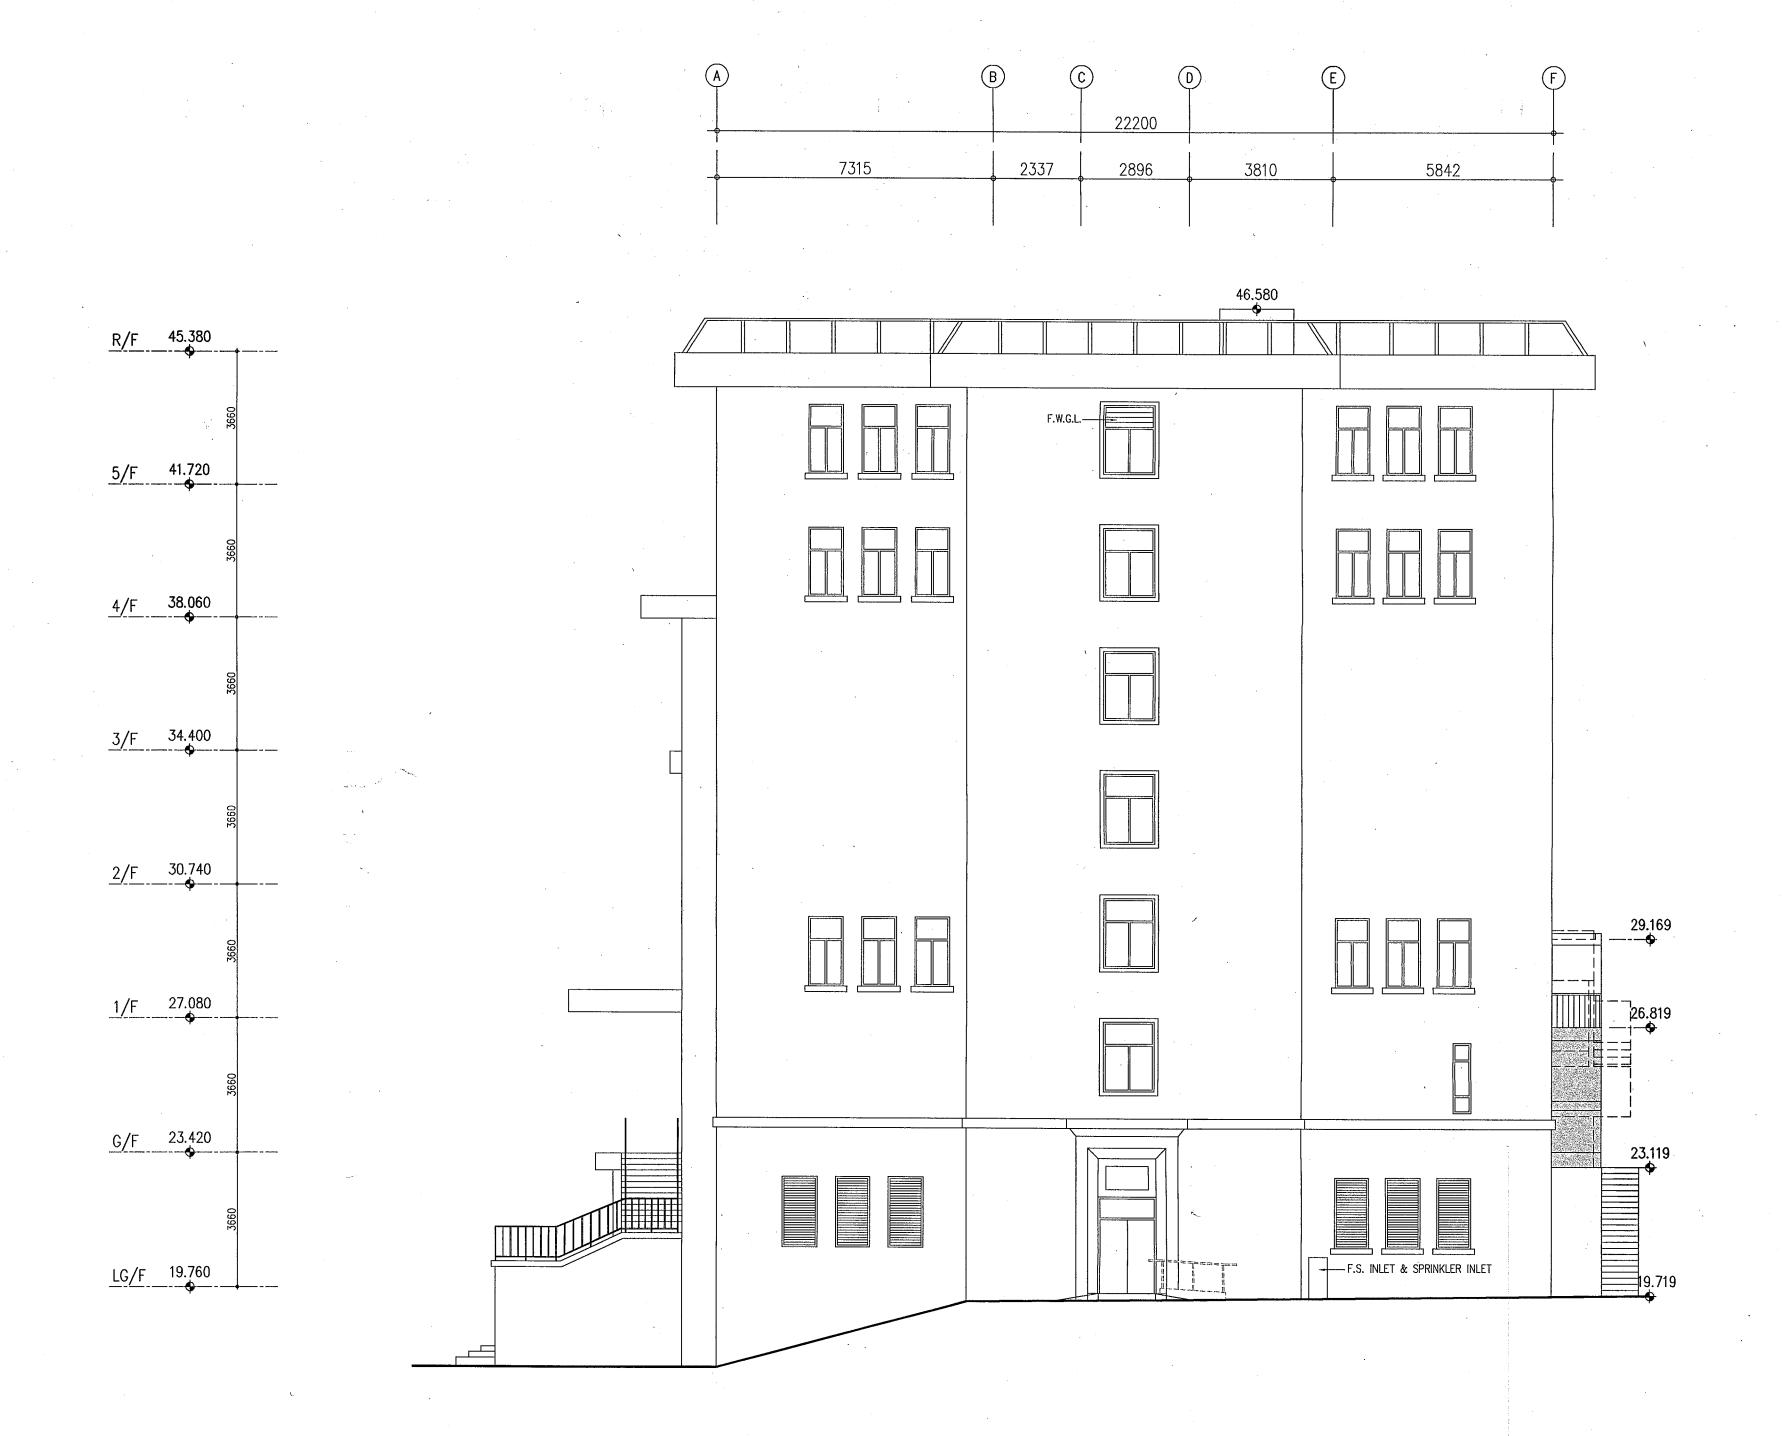




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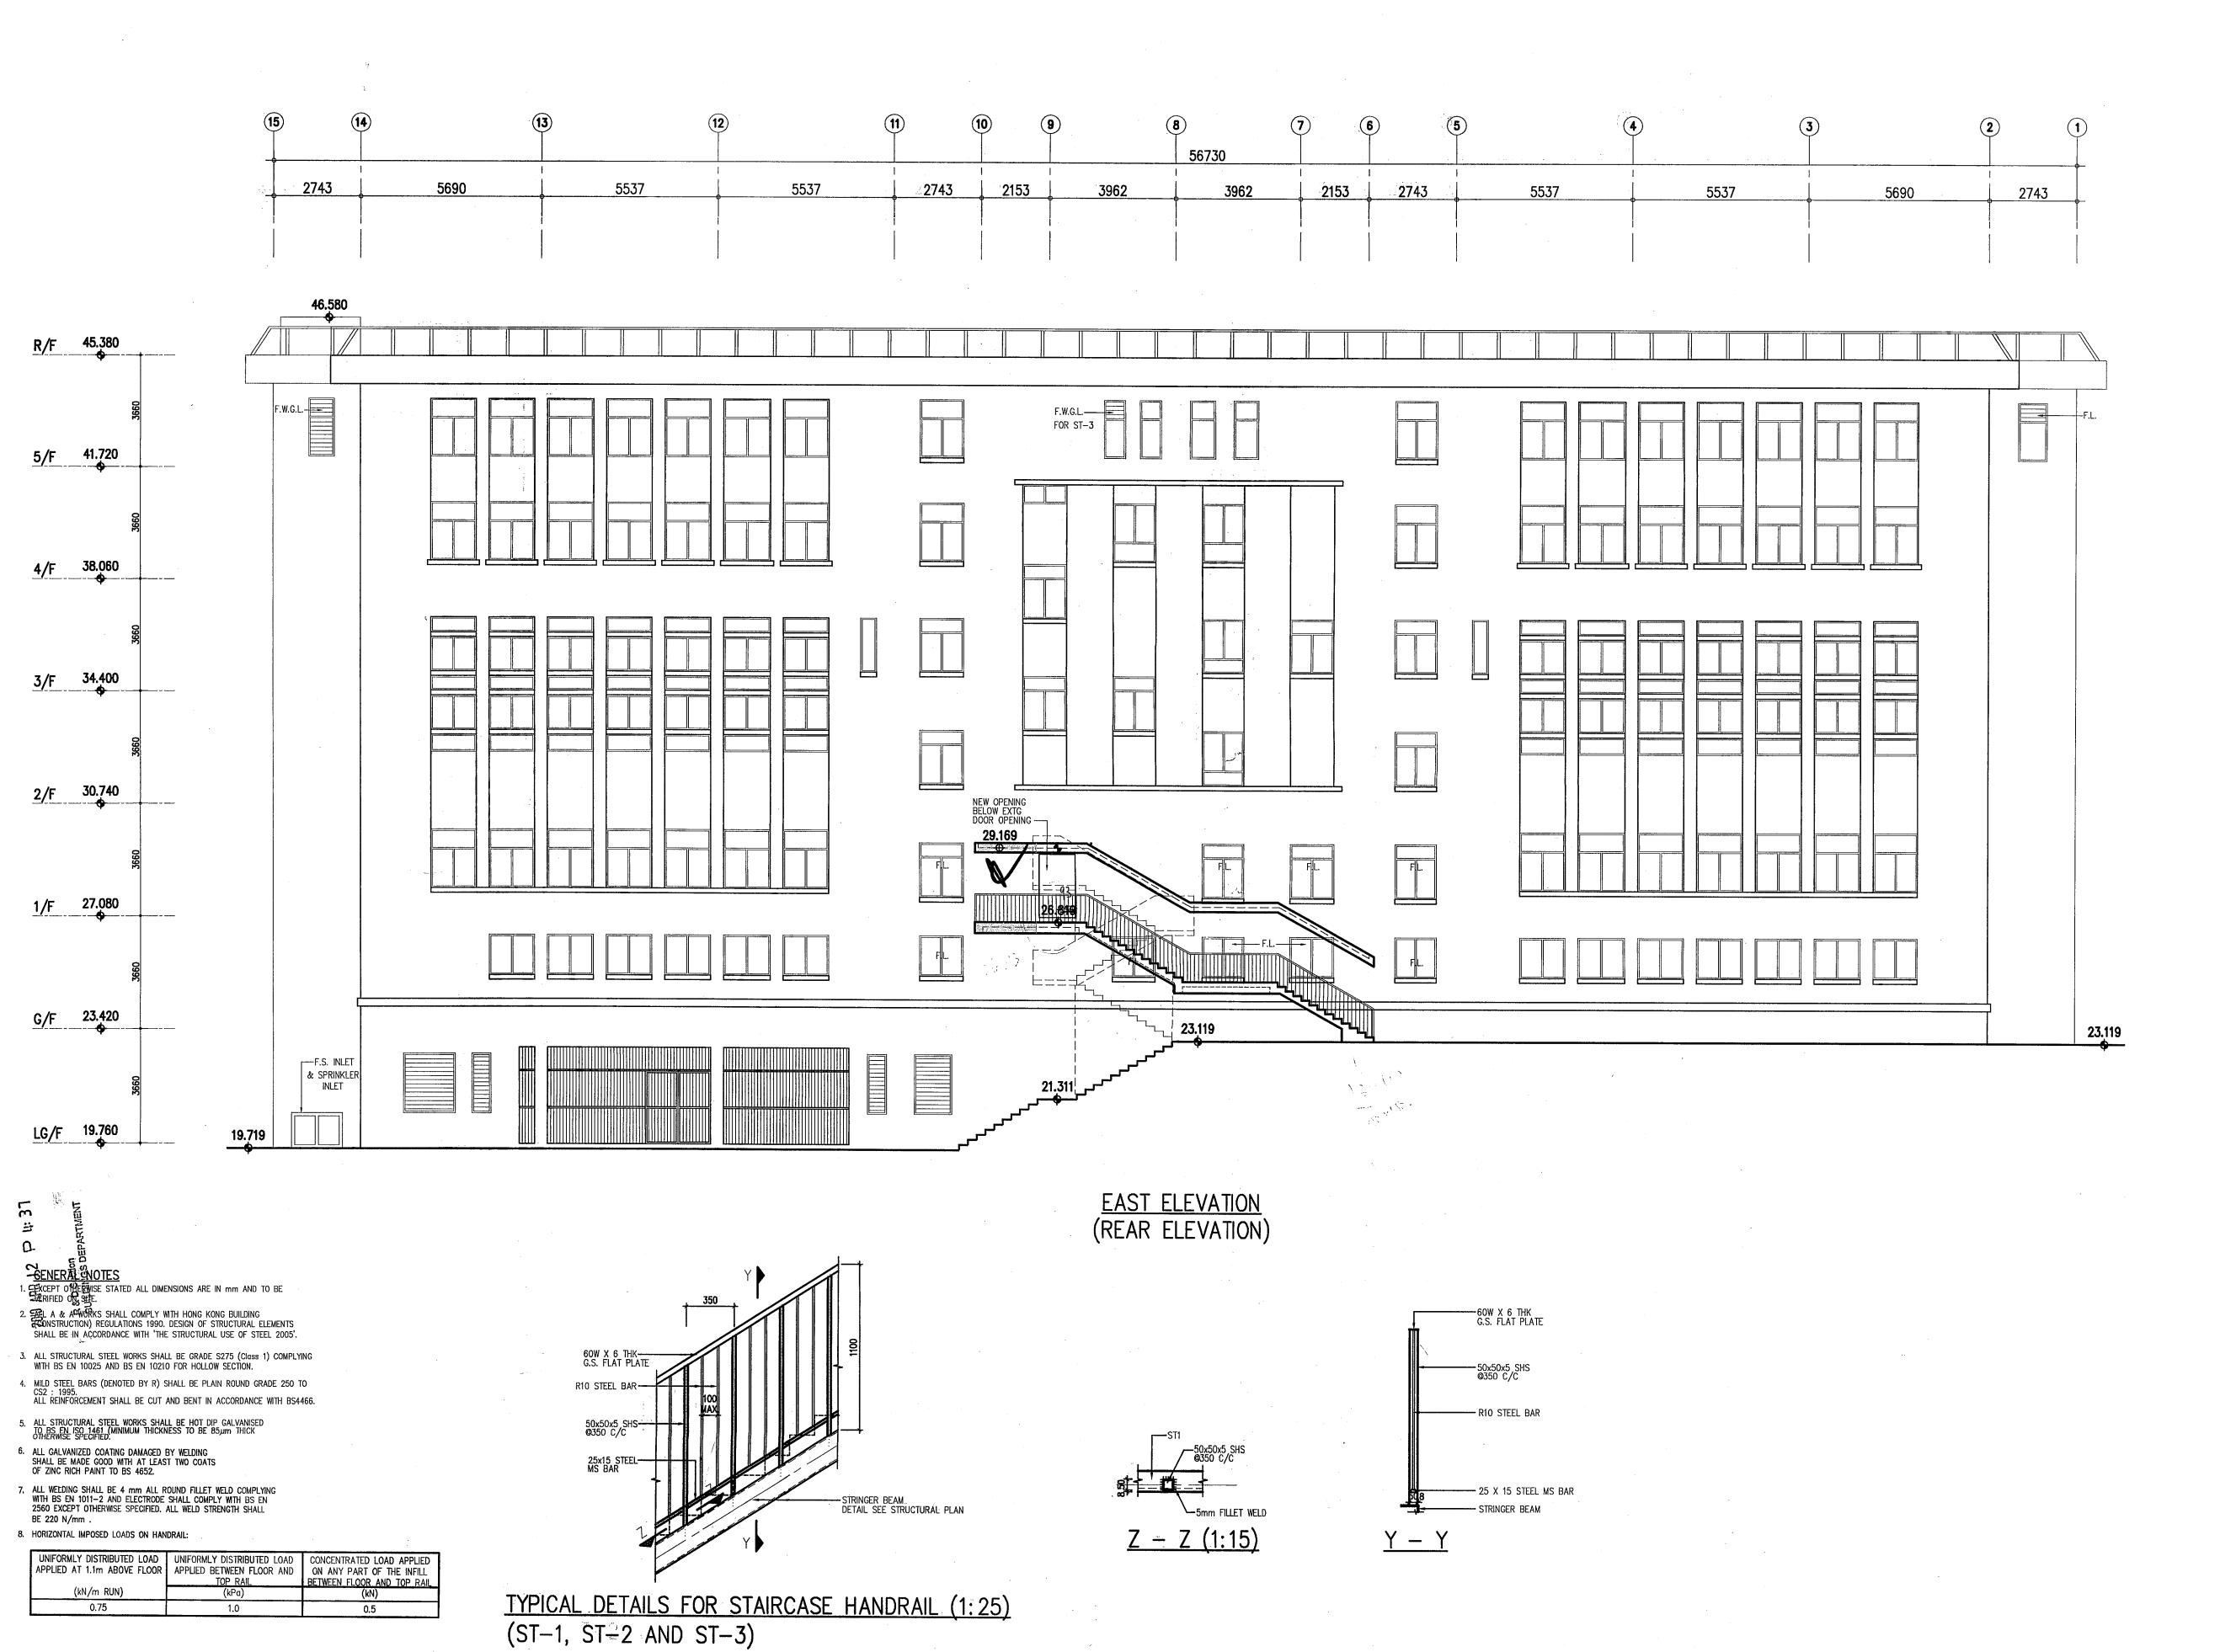
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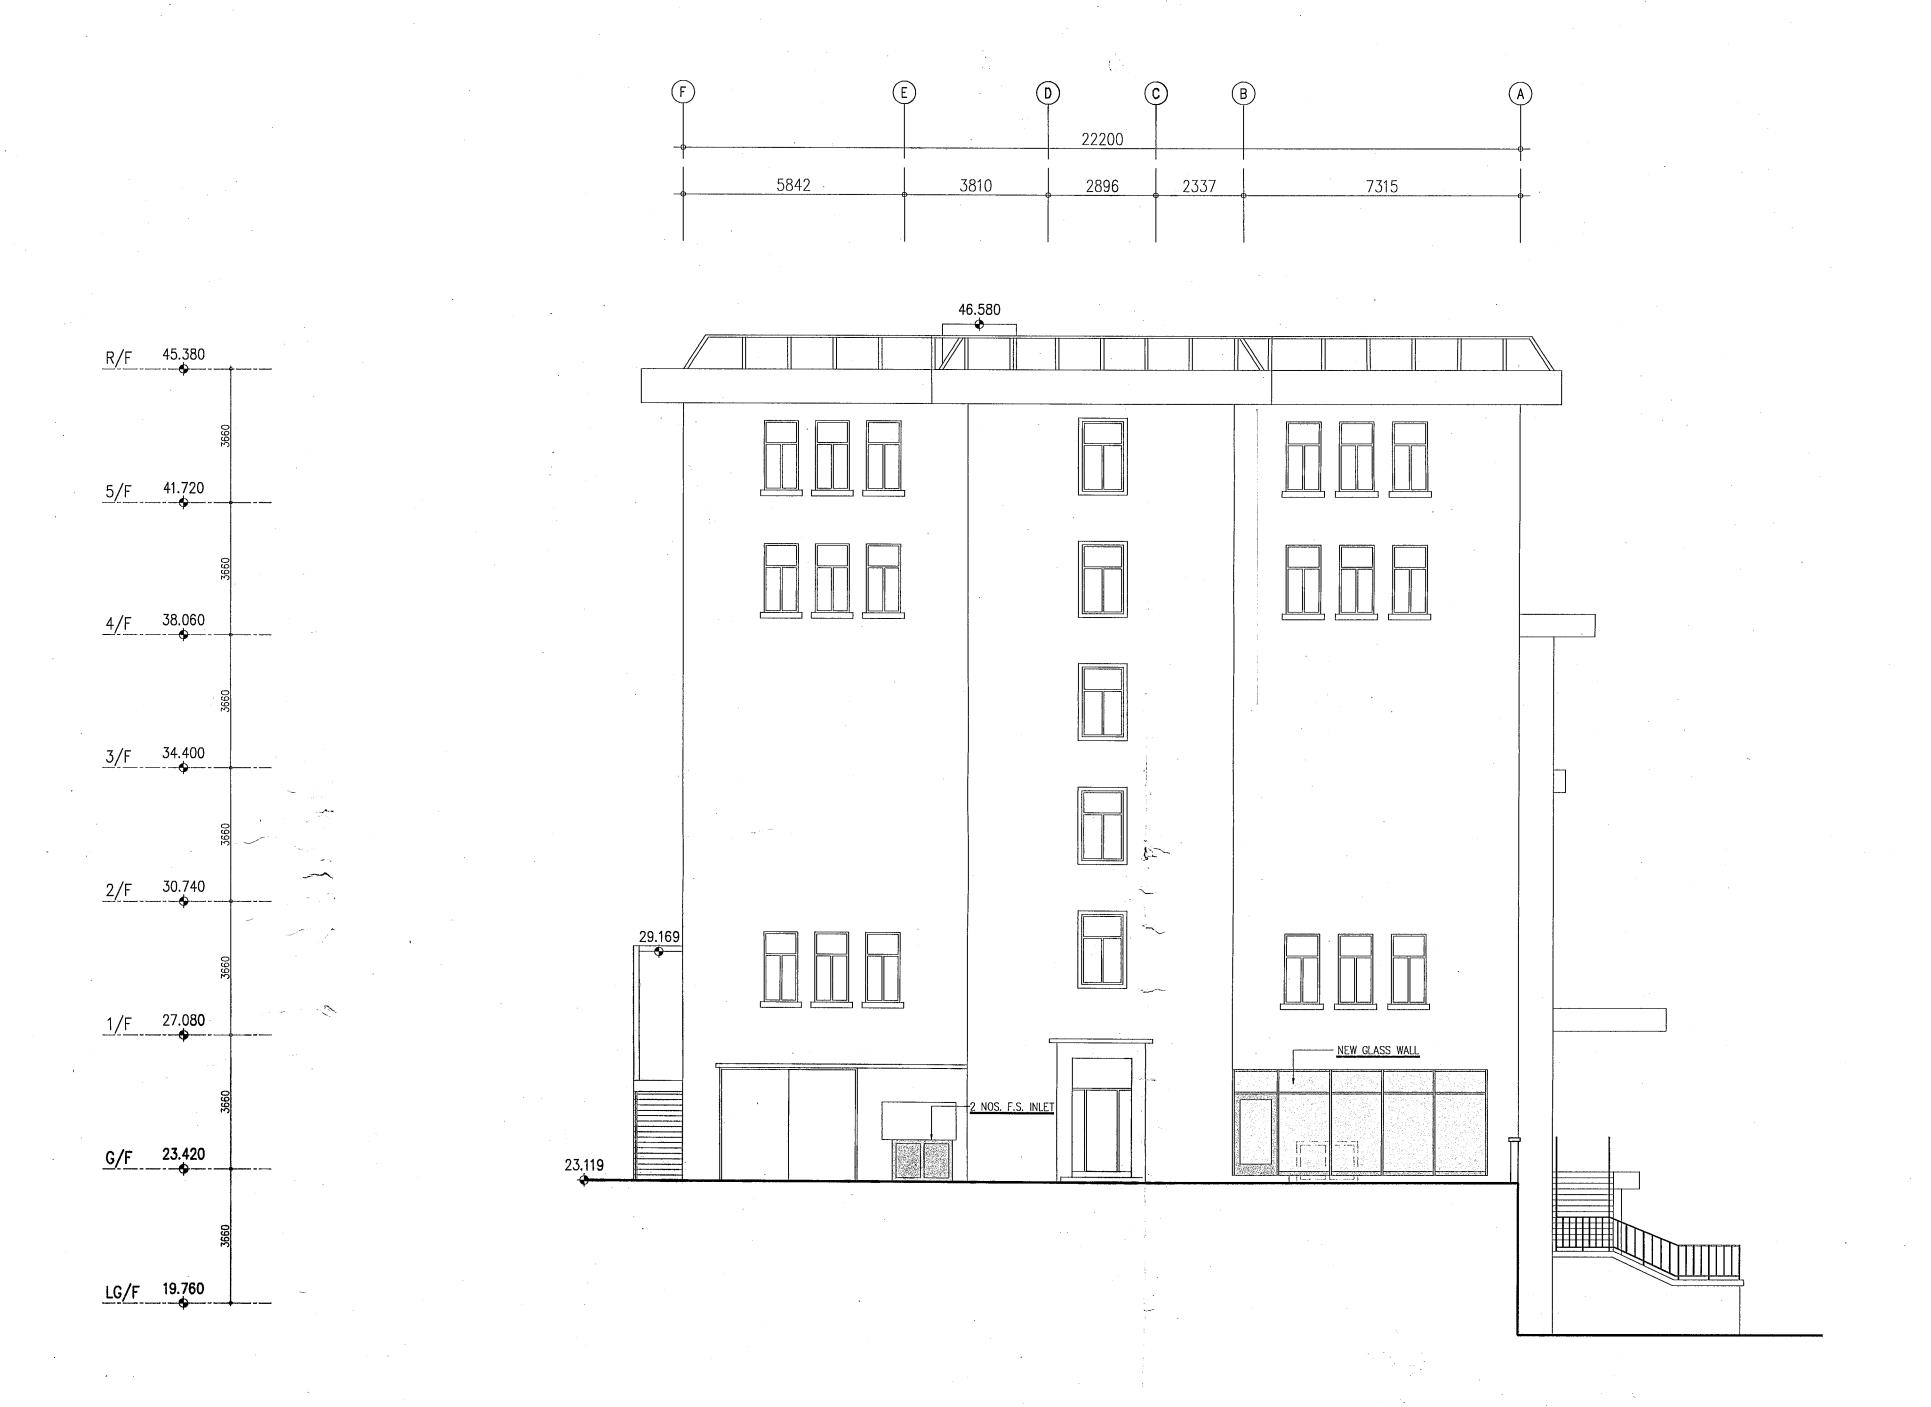
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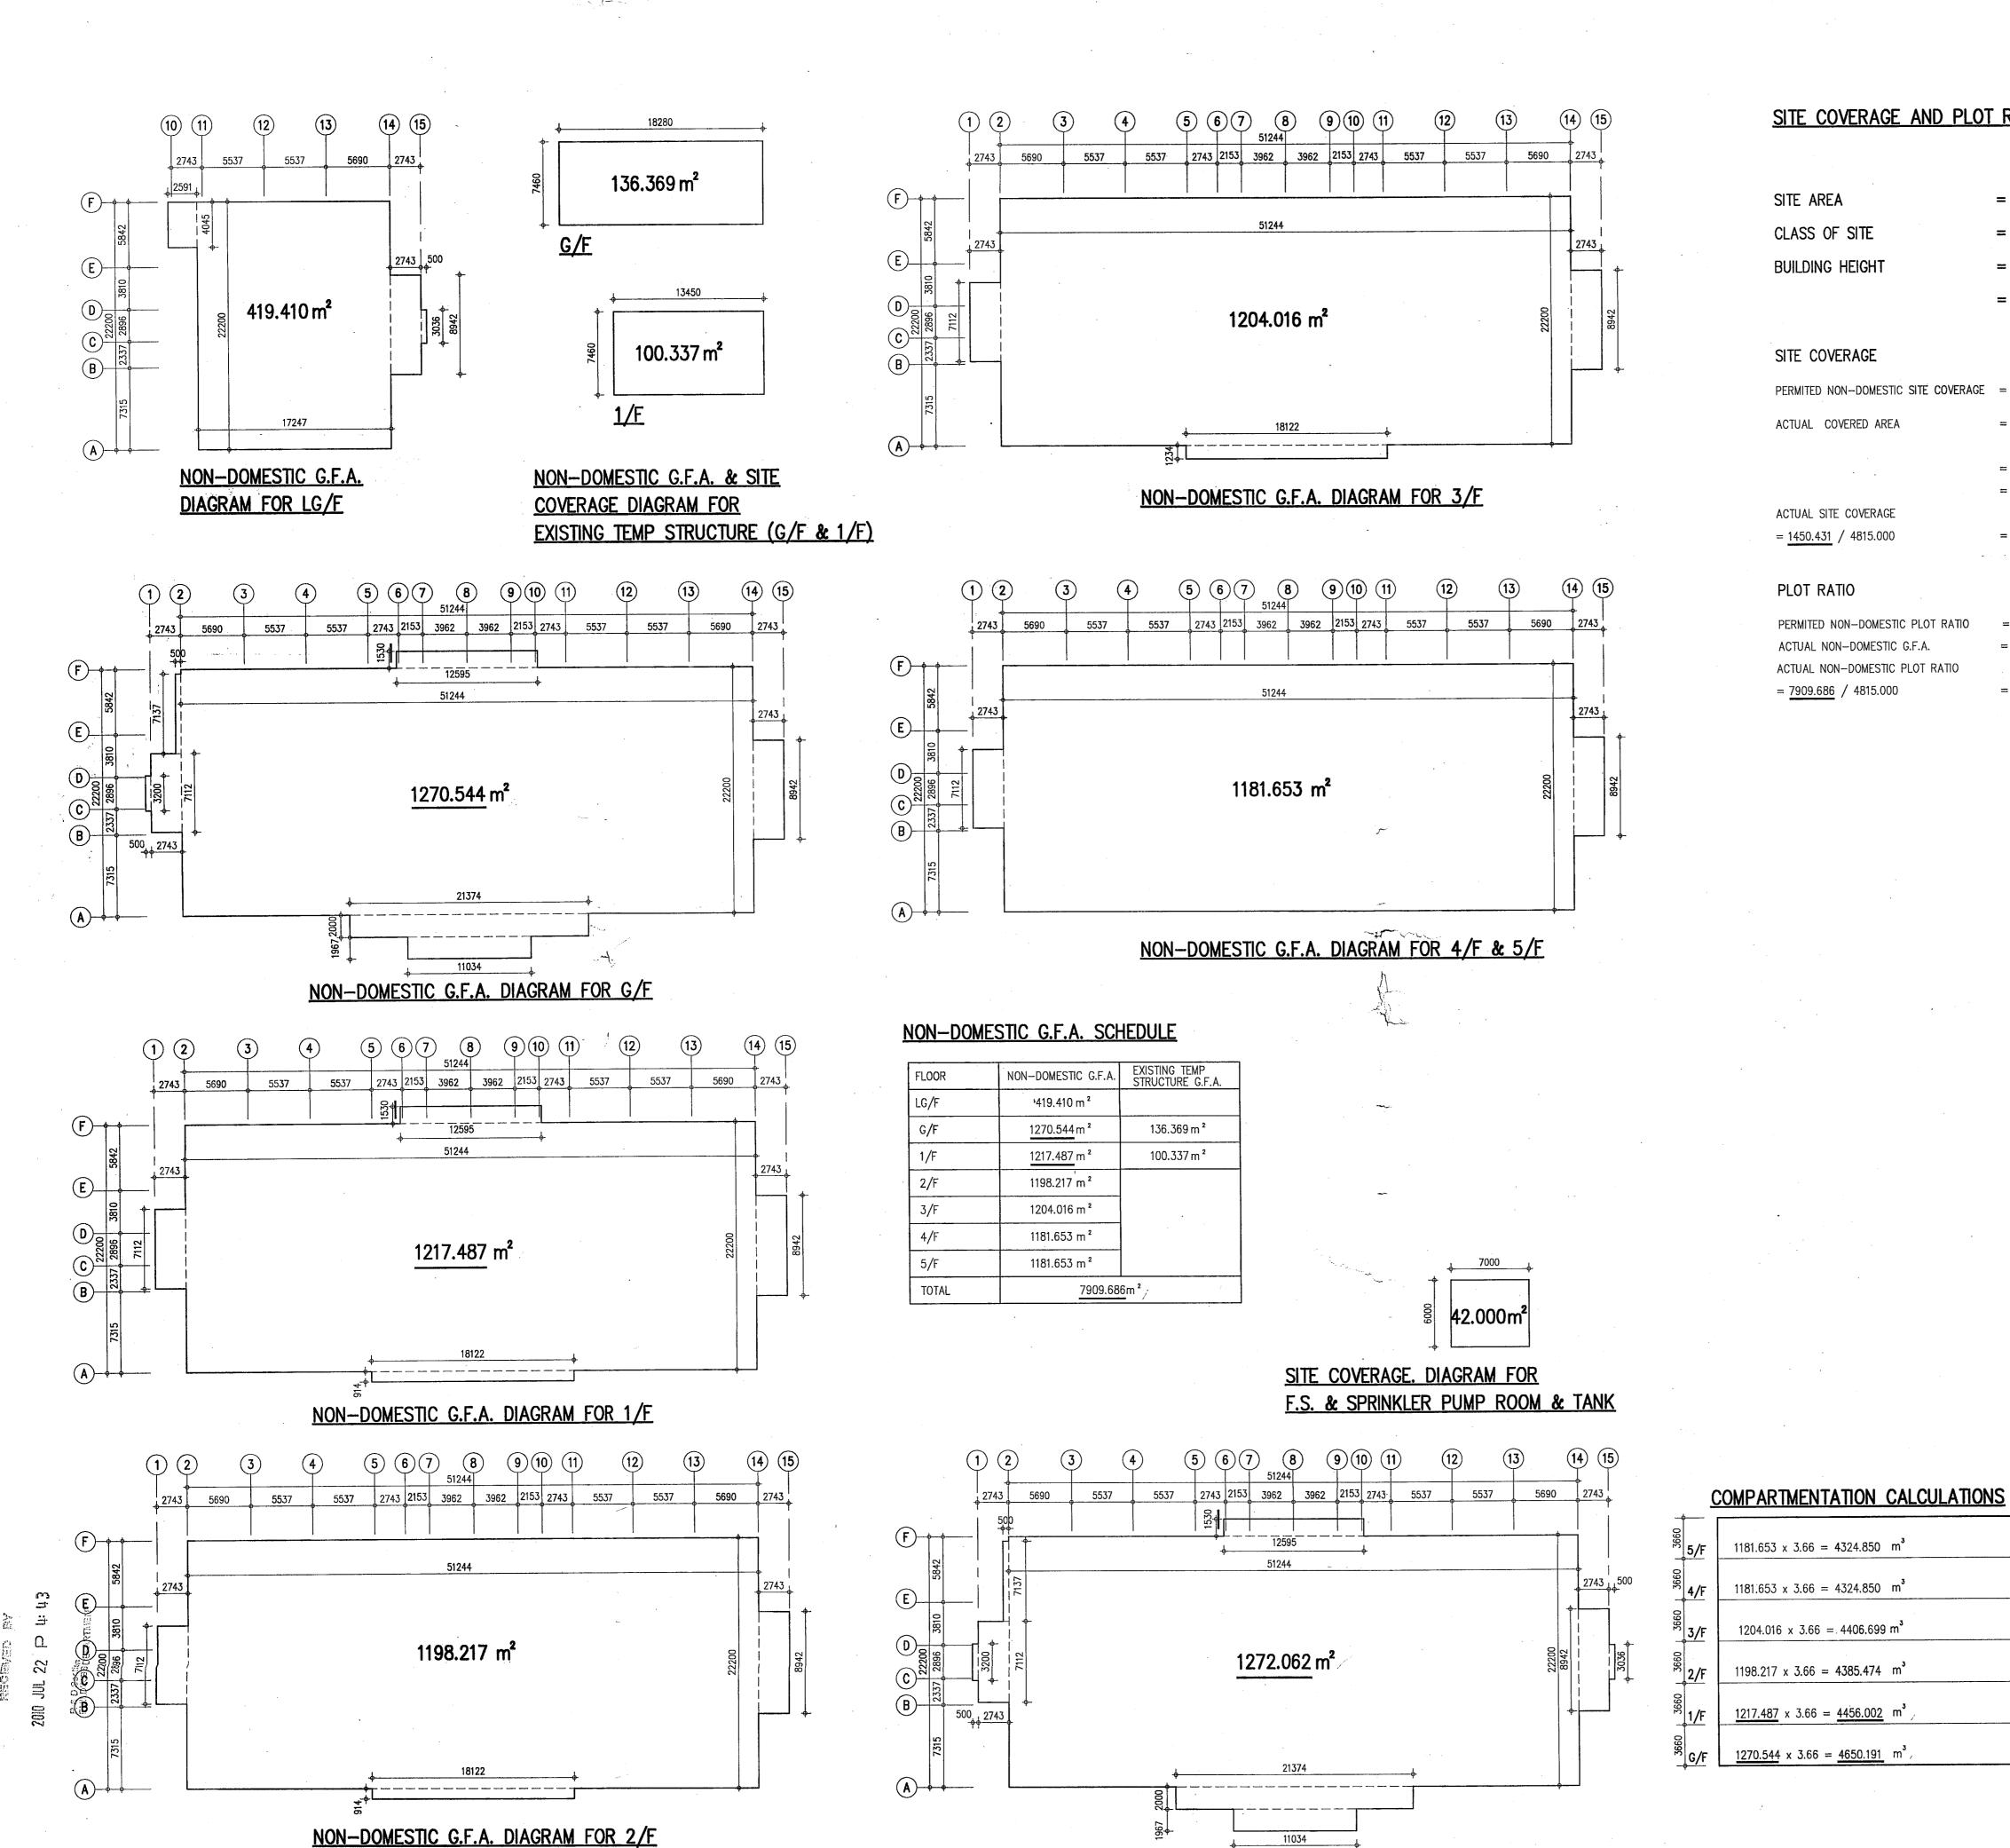
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SITE COVERAGE AND PLOT RATIO CALCULATION

SITE AREA

 $= 4815.000 \text{m}^2$

CLASS OF SITE

BUILDING HEIGHT

= 45.380 - 17.324

= 28.056m

SITE COVERAGE

PERMITED NON-DOMESTIC SITE COVERAGE = 85 %

ACTUAL COVERED AREA

= NORTH KOWLOON MAGISTRACY + EXISTING TEMP STRUCTURE +

F.S. & SPRINKLER PUMP ROOM & TANK

= 1272.062 + 136.369 + 42.000

 $= 1450.431 \,\mathrm{m}^2$

ACTUAL SITE COVERAGE

= <u>1450.431</u> / <u>4815.000</u>

= 30.123 % < 85 %

PLOT RATIO

 $1181.653 \times 3.66 = 4324.850 \text{ m}^3$

 $1181.653 \times 3.66 = 4324.850 \text{ m}^3$

 $1204.016 \times 3.66 = 4406.699 \text{ m}^3$

 $1217.487 \times 3.66 = 4456.002 \text{ m}^3$

SITE COVERAGE. DIAGRAM

PERMITED NON-DOMESTIC PLOT RATIO ACTUAL NON-DOMESTIC G.F.A.

= 8.5 $= 7909.686 \text{m}^2$

ACTUAL NON-DOMESTIC PLOT RATIO = <u>7909.686</u> / 4815.000

= <u>1.643</u> < 8.5

BD 5TH AMENDMENT APPROVED 12.04.10 R.M. W.T. BD 5TH AMENDMENT BD 4TH AMENDMENT APPROVED 15.01.10 KAN W.T BD 4TH AMENDMENT BD 1ST AMENDMENT APPROVED 17.7.09 KAN W.T. BD 1ST AMENDMENT 6.6.09 SUBMISSION APPROVED DATE DRAWN CHEC REVISIONS FOR B.D. USE ONLY

Plan Approved

YIM Yuen-ling
Senior Building Surveyor
for BUILDING AUTHORITY

1 2 AUG 2010

BD 7TH AMENDMENT

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16.7.10 R.M. W.T

Plan Approved

mmm YIM Yuen-ling
Senior Building Surveyor
for BUILDING AUTHORITY

1 6 AUG 2010

NORTH KOWLOON MAGISTRACY NEW SCAD CAMPUS 292 TAI PO ROAD, KLN

DRAWING TITLE

CALCULATIONS (SITE COVERAGE, PLOT RATIO & COMPARTMENTATION)

CHECKED APPROVED DATE 4 MAY 09 SCALE 1:300 (A1) JOB NO. DRAWING NO. 09002 G-17

LCK ARCHITECTS LTD 林陳簡建築師有限公司

WCTOR CHAN 陳麒仁建築師 B ARCH(HK) FHKIA RIBA FRAIA REGISTERED ARCHITECT AP

The works shown on these p

TOTAL VOLUME OF COMPARTMENT

 $= 26548.066 \,\mathrm{m}^3 < 28000 \,\mathrm{m}^3$

Appendix VII

Photos of the Site and Buildings



Photo No.: 1

General Appearance of the Former North Kowloon Magistracy



Photo No.: 2

Front Elevation / West Elevation



Photo No.: 3

North Elevation



Photo No.: 4

East Elevation



Photo No.: 5

South & East Elevation

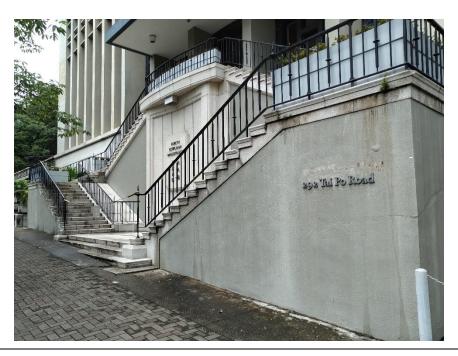


Photo No.: 6

Grand Double Staircase



Photo No.: 7

Temporary Structure



Photo No.: 8

Temprorary Storage



Photo No.: 9

FS & Sprinkler Pump Room & Tank



Photo No.: 10

North Open Forecourt

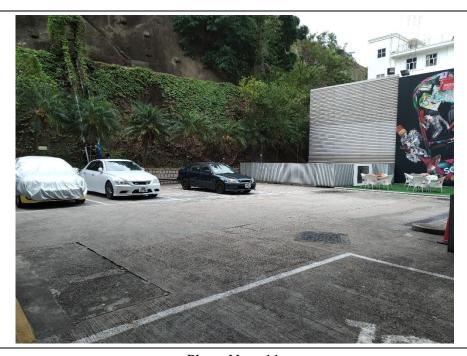


Photo No. : 11
South Open Forecourt



Photo No. : 12

North vehicular run in/out



Photo No.: 13

South vehicular run in/out

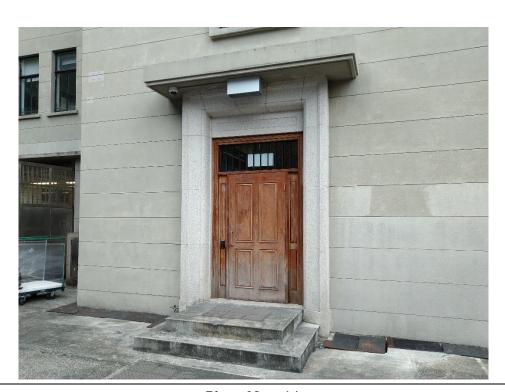


Photo No.: 14

North Entrance



Photo No.: 15

South Entrance



Photo No.: 16

LG/F Lift Lobby

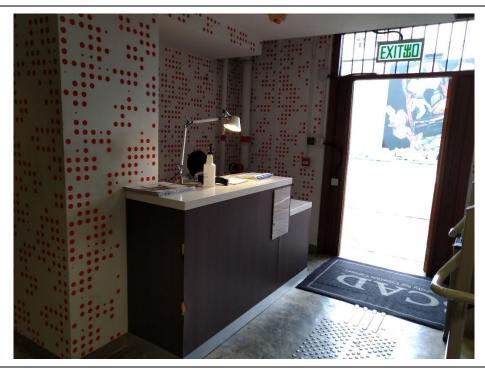


Photo No.: 17

LG/F Lobby

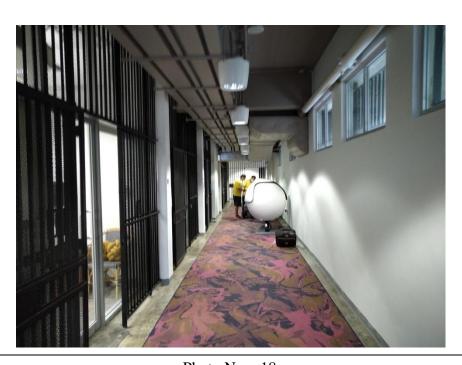


Photo No.: 18

G/F Corridor (Old Control Corridor)



Photo No.: 19

G/F Entrance Hall



Photo No.: 20

1/F Central Hall



Photo No.: 21

1/F Classroom



Photo No.: 22

2/F Conserved No. 1 Court/ Lecture Hall (Conserved Court Room No. 1)



Photo No.: 23

2/F Classroom

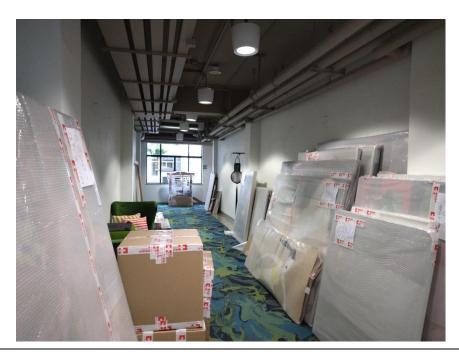


Photo No.: 24

3/F Corridor



Photo No.: 25

3/F Central Light Well

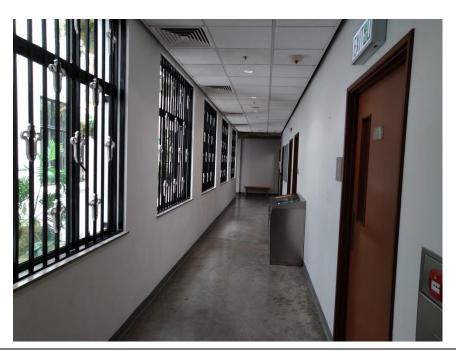


Photo No.: 26

4/F Corridor



Photo No.: 27

5/F Classroom



Photo No.: 28

5/F Photo Studio



Photo No.: 29

5/F Toilets



Photo No.: 30

5/F PAU Room



Photo No.: 31

Roof

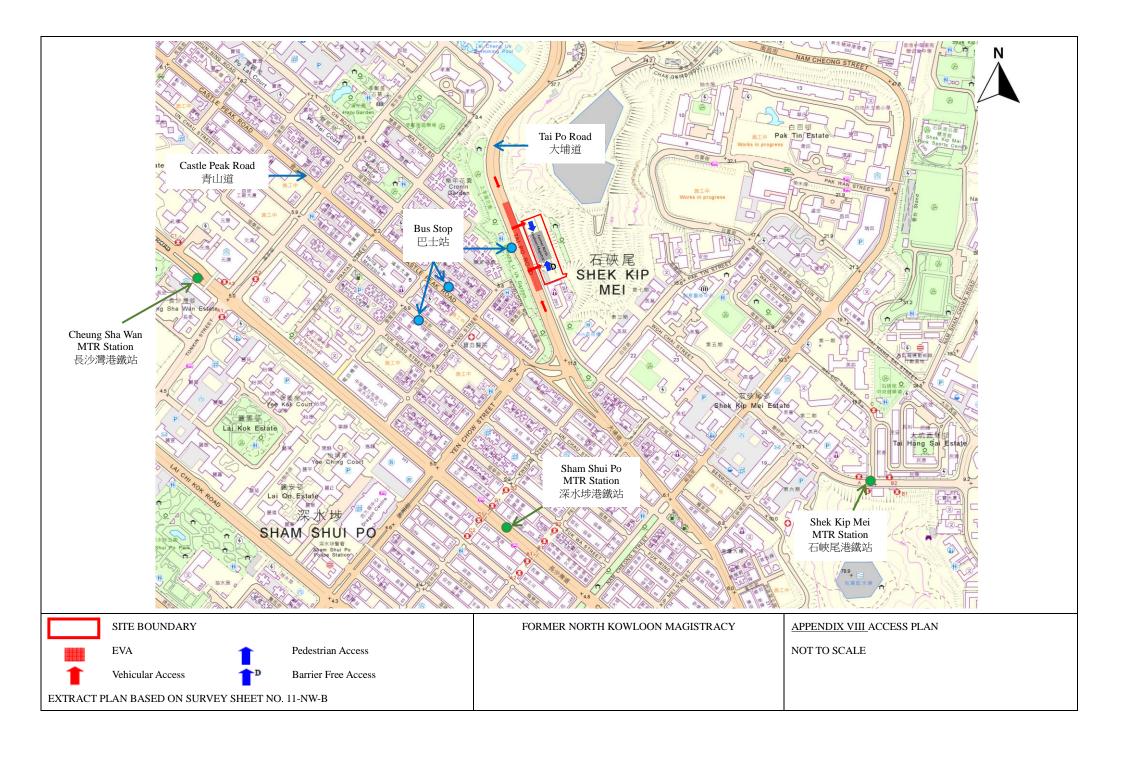


Photo No.: 32

Glazed Lift Overrun Enclosure on Roof

Appendix VIII

Access Plan




Appendix IX

List of Architectural Features to be Preserved

Former North Kowloon Magistracy List of Architectural Features to be Preserved

1. EXTERNAL GROUNDS

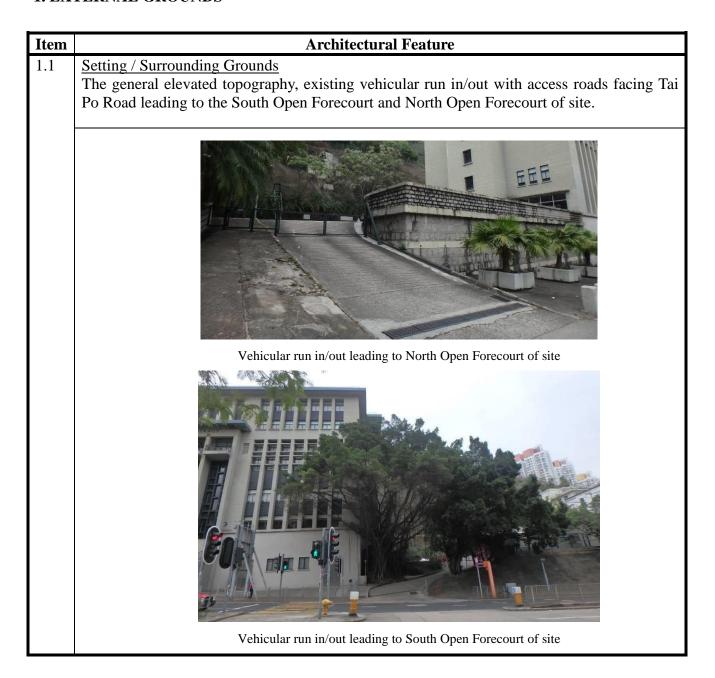

1.2 Retaining structures

Existing retaining structures forming podium or plinth facing Tai Po Road. Existing natural landscape with mature trees at the entrance of the South Open Forecourt. Stone parapet wall at the North Open Forecourt. Plain ashlar-faced retaining wall along north side of the symmetrical grand double staircases on LG/F.





Retaining structure with mature trees at entrance of the South Open Forecourt



Stone parapet wall at the North Open Forecourt



Plain ashlar-faced retaining wall along north side of LG/F

ItemArchitectural Feature1.3Open spaces at pavement level facing Tai Po Road
Open spaces between the vehicular run in/out and central grand double staircases at pavement level facing Tai Po Road.



Open space at south of central grand double staircase



Open space at north of central grand double staircase


1.4 South Open Forecourt and North Open Forecourt of the Historic Building

South Open Forecourt accommodates carparks with ancillary facilities, e.g. fire services pump room and tank, cooling tower for air-conditioning system, temporary storage and temporary structures, bounded by metal fencings and vehicular access gate facing Tai Po Road.

North Open Forecourt accommodates carparks bounded by stone parapet wall and vehicular access gate facing Tai Po Road.



South Open Forecourt

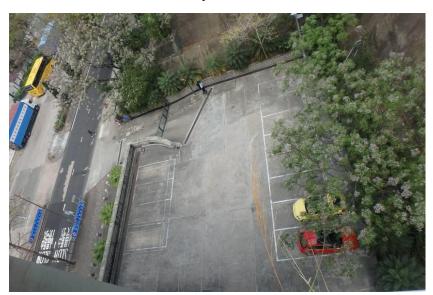

North Open Forecourt

2. MAIN BUILDING - EXTERIOR


Item Architectural Feature 2.1 External Building Facades All external building facades, including the symmetrical design with central projecting bay on front and side facades, and with series of tall and narrow windows separated by vertical columns at front and rear facades, all original windows and door openings, all stonework, ashlar, grooved stucco and decorative tiles etc., horizontal string course on G/F and all horizontal protruding eaves.



West Elevation



South Elevation

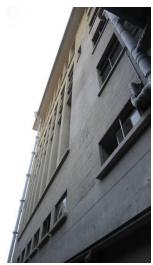


East Elevation



North Elevation

Item Architectural Feature 2.2 Flat roof The publicly non-accessible flat roof with its projecting eaves, roof tiles, surface channels, and access hatch. Projecting roof eave

Open flat roof

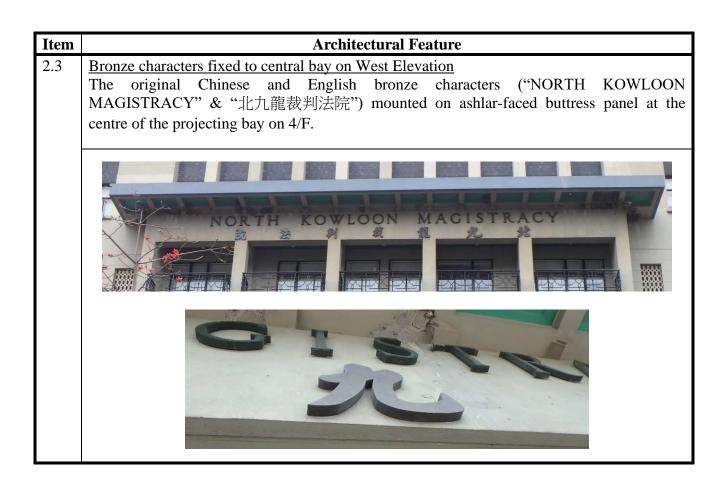

2.4 Roof terrace on 4/F

Roof terrace, including its projecting floor slab, solid parapet wall with deep overhanging coping slab, cornice mouldings at the soffit of the overhanging coping slab, floor finishes, thresholds to French doors, skirting and surface channels, at the flat roof of the central projecting bay.



Roof terrace with solid parapet on 4/F



Roof terrace with surface channel



Solid parapet with deep overhanging coping



Cornice mouldings at the soffit of the overhanging coping slab



Steel French doors with threshold

Item Architectural Feature 2.5 Balcony on 3/F A semi-opened balcony including its columns, roof slab, ornamental ironwork balustrades, mosaic tiled floor finishes, surface channels, skirting and projecting floor slab.












Item	Architectural Feature
2.6	Canopy above main entrance with flagpole Deep projecting concrete canopy, including the inverted beam-and-slab structure and surface channels, and the original metal flagpole fixed on concrete mass.
	Jan

T4	A 1.4 4 1.5 4
Item	Architectural Feature

2.7 Symmetrical grand double staircases


Double half-turn open symmetrical grand staircases from street level to main entrance at piano-nobile on G/F comprising flights of granite steps (including the three granite steps at street level), granite landings, string course decoration, spandrels, and ornamental ironwork balustrades.

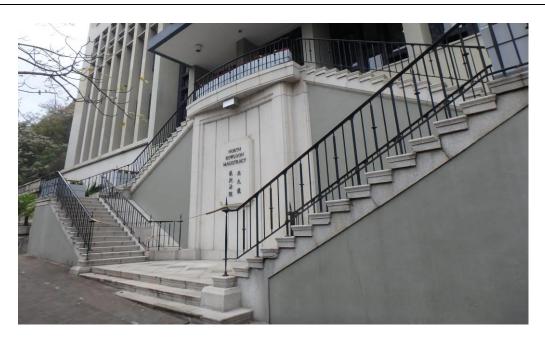





Item	Architectural Feature
2.8	Buttress Projecting ashlar-faced buttress between the staircase spandrels with grooved or recessed joints to the stonework, and a moulded name tablet set in a recessed panel.
	NORTH KOWLOON MAGISTRACY 東北 判 九 流 院 龍

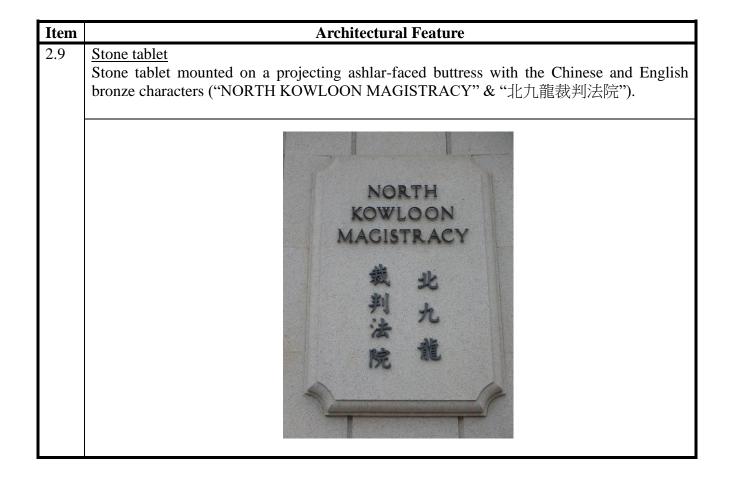

2.10 Main entrance bronze door case with bronze doors

Main entrance door comprises a pair of bronze studded panel cladding doors in a moulded bronze door case framed with moulded architraves, completes with handles, bolts, locks and hinges.





Exterior view

Interior view

Architectural Feature Item 2.11 Entrance stone door cases with steps Carved stone door case, including the moulded architrave, cornice crown moulding with

granite door threshold and steps facing South Open Forecourt.

Carved stone door case, including the moulded architrave and ashlar-faced canopy above with granite and steps facing North Open Forecourt.




Entrance stone door case facing South Open Forecourt



Entrance stone door case facing North Open Forecourt

2.12 Entrance wooden doors

Wooden panelled entrance doors and fanlights with wooden frame, including decorative mouldings at the door faces, door jambs and door head, facing South Open Forecourt and North Open Forecourt. (The door leaves and frames are not original but with design mimic the old wooden doors.)

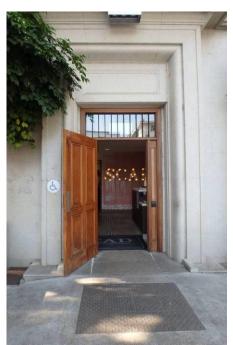





Entrance wooden door facing North Open Forecourt

Item	Architectural Feature
2.13	Steel French doors to roof terrace on 4/F and balcony on 3/F
	Steel French door openings, including steel French doors and fanlights with steel frames to roof terrace on 4/F and balcony on 3/F.





Architectural Feature Item Window openings and Steel Windows All regularly spaced window openings including transomed steel windows with granite cills or window surrounds at external, ironmongeries and internal terrazzo window cills. 2.14

Item	Architectural Feature
2.15	Decorative glazed tiles
	Decorative glazed tiles, including bullnose tiles and recess tiles, with groove lines mortared
	on apron panels and jamb tiles surround the steel window frames.







Item	Architectural Feature
2.16	Original Garage Openings on G/F
	The original wall openings for the old Police Van Garage with old metal gate and the old
	Magistrate's Garage facing North Open Forecourt.




Original wall opening for the old Police Van Garage with old metal gate



Original wall opening for the old Magistrate's Garage

Item	Architectural Feature
2.17	Wall openings with old steel gates at the East elevation
	The wall openings with old steel gates on LG/F at the East elevation.

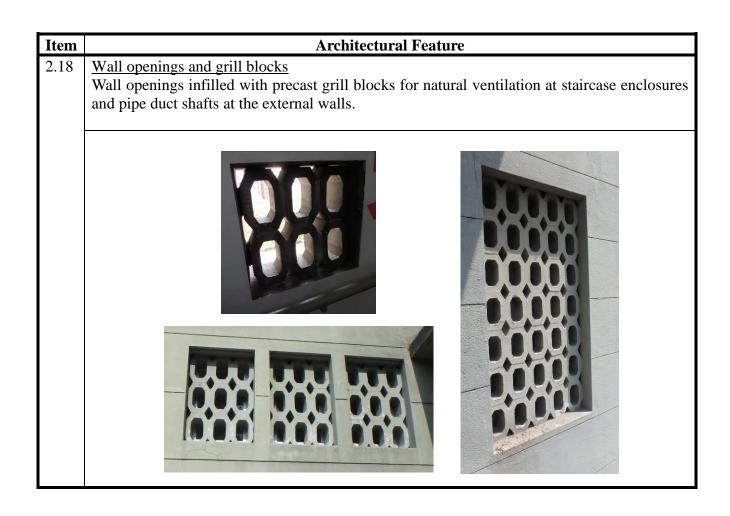

tral light well (on 3/F, 4/F and 5/F)
tral light well, exhaust fan housings with glass block roof light at 2/F soffit, and steel dows.
tra





3. MAIN BUILDING – INTERIOR

Item Architectural Feature 3.1 Building Structure All structural elements including columns, beams, floor and roof slabs, etc...



3.2 Central Halls

Central Halls from G/F to 2/F including random pattern stone flooring on G/F, marble wall cladding with black marble skirting on G/F to 2/F, the ornamental ironwork balustrades with wooden handrails and metal guard bars around the central hall staircase void featuring fleur-de-lis motifs, and ornamental metal handrails and guard bars to the vertical windows.



2/F Central Hall




1/F Central Hall



G/F Central Entrance Hall



Random pattern stone flooring on G/F

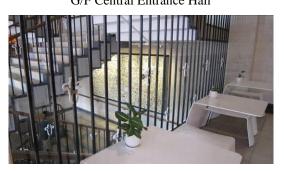

Metal guard bars around the staircase



Metal handrails and guard bars to the vertical windows

Item	Architectural Feature
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3.3 Central Staircase

Central staircase from G/F to 2/F which lit by the glass blocks roof light above including the stone finishes to treads and risers, the square mouldings at the sides, the ornamental ironwork balustrades with wooden handrails featuring fleur-de-lis motifs and the marble cladding with the black marble skirting on walls.







3.4 Old Detention Cells No. 2, 3, 4, 5 and 7

The remains of the old Detention Cells No. 2, 3, 4, 5 and 7 including all original configurations, metal guard bars and grilles, all metal gates with mortice locks, and all half-height partitioned squat toilets with white tiled wall finishes and mosaic tiled floor finishes.



Metal guard bars and grilles, metal gates of the old Detention Cell no. 2,3,4,5



Metal guard bars, grilles and metal gates of the old Detention Cell no. 7





Original configuration of cell



Half-height partitioned squat toilet inside cell.

3.5 Conserved Detention Cell No. 6

The conserved Detention Cell No. 6 with its original configuration and layout including the metal guard bars and grilles, the metal gate with mortice lock, the half-height partitioned squat toilet with white tiled wall finishes and mosaic tiled floor finishes, concrete benches, painted wall finishes with dado coloured grey, and with its upper portion painted white, the historic graffiti on walls, the original concrete flooring and the wash basin outside the cell.



Metal guard bars, grilles, gates and the wash basin



Original configuration and layout of cell



Half-height partitioned squat toilet and concrete benches



White tiled wall finishes and mosaic tiled floor finishes of squat toilet



Concrete benches and painted wall finishes with dado coloured grey



Historic graffiti on wall

3.6 Old Control Corridors on G/F

The old control corridors on G/F from the old Police Van Garage (existing common area) to the old detention cells and from the old detention cells to the metal gate of conserved Defendant Staircase including 4 nos. of metal gates, and the metal guard bars at window openings at high levels.



Old Police Van Garage (existing common area)



Old detention cells









Metal gates at the control corridor on G/F

ItemArchitectural Feature3.7Conserved Court Room No.1 on 2/F

The conserved Court Room No. 1 with the original configuration and settings including:

- i) the sound lobby with wooden ceiling, the upper fixed glass panels and frames, and a pair of wired glass panelled wooden inner doors and door frame;
- ii) public wooden benches on raised steps, the wooden bench of the press corner and the half-height wooden barrier and gate separating the public area;
- iii) Prisoner's Dock and the security bars, and the wooden panelled door and frame for prisoners/ defendants behind;
- iv) Clerk's bench, the witness box with wooden chair and court reporter's desk on low wooden raised platform;
- v) Magistrate's bench on high wooden raised platform, the backdrop wall including the full height wooden wall panelling at both sides, and the moulded frame, the acoustic panels and the Bauhinia plaque at the centre, the wooden steps to the high wooden raised platform and the wooden handrail, the wooden panelled door and door frame for magistrates; and
- vi) design with double-height steel windows on one side of walls, wall finishes with wooden wall panelling on the lower portion and acoustic panels on the upper portion, timber parquet flooring, and the mouldings on ceiling beams.







(Con't)















3.8 Old Court Room No. 2, 3, and 4 on 2/F

The configurations of the old Court Room No. 2. 3 and 4 which designed with double-storey ceiling height, the double-height steel windows on one side and the original mouldings on ceiling beams.






Old Court Room No. 2 (Existing Studio)





Old Court Room No. 3 (Existing Classroom 11 and Sound Design Studio)

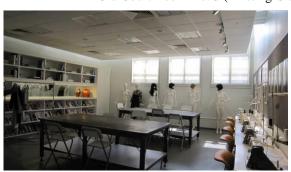



Old Court Room No. 4 (Existing Classrooms 12 & 13)

3.9 Old Court Rooms Entrance Doors on 2/F

The original wooden panelled double doors of the old Court Room No. 1-4, including all door frames, wooden door head panels with mouldings, metal signages and all old ironmongeries.









Item	Architectural Feature
3.10	Conserved Defendant Staircase
	The conserved Defendant Staircase leading from the detention cells on G/F to the conserved
	Court Room No. 1, including the metal gates and metal guard bars, the white nosing tiles,
	the white ceramic tiled wall finishes up to dado height and the glass block window on 2/F.









Item	Architectural Feature
3.11	Conserved Magistrates' Staircase The conserved portion of Magistrates' Staircase leading from the conserved Court Room No. 1 on 2/F to 3/F where the old Magistrates' chambers located including the mosaic tiles finishes and nosing tiles to the treads, risers and skirtings, and the stainless steel balustrades.



3.12 Old Ducts Rooms on 3/F

The configuration of the 4 nos. of old ducts rooms (existing duct rooms and stores) on 3/F with the existing ventilation duct openings on floor to the old court rooms below, the wall openings to the external wall.



Ducts Room (Grid A-C)



Store (Grid D-F)



Ducts Room (Grid D-F)



Store (Grid A-C)

Item	Architectural Feature
riem	Arcintectural Feature

3.13 All Other Old Wooden Panelled Doors

Apart from the old panelled doors mentioned in Item 3.7 and Item 3.9, all other old wooden panelled doors including the door frames and the ironmongeries. Some of the old doors have been salvaged and are being stored.













3.14 All Old Metal Guard Bars and Gates

All old metal guard bars and gates including those on windows and those which have been salvaged and are being stored, some of the old metal guard bars are ornamented with fleur-de-lis motifs painted in white.













Item	Architectural Feature
3.15	Splayed and moulded plaster cornices at ceilings All splayed and moulded plaster cornices at ceilings.
	All splayed and moulded plaster cornices at ceilings.

Item Architectural Feature

3.16 Other Salvaged Items

All salvaged items including furniture, fittings and signages which are being reused, displayed and stored.

















Appendix X

List of Required Treatment to Architectural Features

Former North Kowloon Magistracy Required Treatments to Architectural Features

1. EXTERNAL GROUNDS

Item	Architectural Feature	Required Treatments
1.1	Setting / Surrounding Grounds	 a. The general elevated topography should be kept intact. b. The vehicular run in/out with access roads facing Tai Po Road leading to the South Open Forecourt and North Open Forecourt of site should be generally kept intact. c. Improvement proposals for the site access in conformance to statutory requirements in a reversible manner and with minimum disturbance to the historic building may be considered and subjected to AMO's approval.
		considered and subjected to Thirte 5 approval.



Vehicular run in/out leading to North Open Forecourt of site



Vehicular run in/out leading to South Open Forecourt of site

Item	Architectural Feature		Required Treatments
1.2	Retaining structures	a.	Existing retaining structures forming podium facing Tai Po
			Road should be kept intact.
		b.	Plain ashlar-faced retaining wall forming a plinth at LG/F of
			the historic building facing Tai Po Road should be preserved
			in-situ. Generally clean, brush-off and remove stains from the
			surface as appropriate.
		c.	The natural landscape with mature trees at the entrance of the
			South Open Forecourt to be retained as far as possible.
		d.	Stone parapet wall at the North Open Forecourt should be
			preserved in-situ. Remove the organic growth on surface and
			remove the blockage at the weep holes. Repair and make good
			the stone finishes as appropriate.





Retaining structure with mature trees at entrance of the South Open Forecourt



Stone facing low parapet wall at the North Open Forecourt



Plain ashlar-faced retaining wall along north side of LG/F

Item	Architectural Feature	Required Treatments
1.3	Open spaces at pavement level facing Tai Po Road	 a. Open spaces originally used as carparking spaces for the Magistracy at pavement level facing Tai Po Road to be remained as open as possible, so that the vista to the LG/F facades of the historic building could be maintained. b. No objection to remove the existing on-grade planters and/or bollards to suit the new use. c. The overall landscaping design with paving material, if any, at the open spaces should blend in with the surroundings to preserve the historical character of the historic building, and subjected to AMO's approval.



Open space at south of central grand double staircase



Open space at north of central grand double staircase

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Item	Architectural Feature	Required Treatments
1.4	South Open Forecourt and North Open Forecourt of the Historic Building	 a. The vista of the facades of the historic building are important and should be maintained. The existing openness of the South Open Forecourt and North Open Forecourt be remained as far as possible to allow the general public to pay due respect to the building. b. The South Open Forecourt and North Open Forecourt adjacent to the historic building ('Open Space') as denoted in the following drawing should be preserved to minimize the visual impact to the building facades and to maintain the unobstructed vista to the historic building. c. Existing 2-storey temporary structure ('Temporary Structure') as denoted in the following drawing should be demolished, unless approval for continuing to occupy this structure is obtained from relevant departments. d. Existing temporary storage ('Temporary Storage') as denoted in the following drawing should be demolished. e. The landscaping design with paving material, if any, at the open courts should blend in with the surroundings to preserve the historical character of the historic building, and subjected to AMO's approval. f. Replacement of the metal fence and access gates facing Tai Po Road may be considered. The design should be compatible and distinguishable from the historic building, and is subjected to AMO's approval. g. Replacement of the covers of the surface channels may be considered, and is subjected to AMO's approval.
	South Open Forecourt North Open Forecourt Temporary Structure Temporary Storage	Open Space Temporary Structure Temporary Storage

2. MAIN BUILDING - EXTERIOR

Item	Architectural Feature	Required Treatments
2.1	External Building Facades	 a. All external building facades, including the symmetrical design with central projecting bay on front and side facades, and with series of tall and narrow windows separated by vertical columns at front and rear facades, all original windows and door openings, all stonework, ashlar, grooved stucco and decorative tiles etc., horizontal string course on G/F and all horizontal protruding eaves should be preserved in-situ. b. No new structures, air-conditioning equipment, awning, shading fins, etc. on building facades are permitted. c. It is noted that localized conversion works had been carried out at the facades. No alteration or blockage to openings or formation of new openings on the facades are permitted unless with sound evidence and approved by AMO. d. Repair defective rendered walls as necessary, and repaint to match existing with approved methods and materials. e. Remove the temporary signages fixed on the facades and make good as necessary. f. Clean and remove all organic growth on surfaces.



West Elevation



South Elevation



East Elevation



North Elevation

Item	Architectural Feature	Required Treatments
2.2	Flat roof	 a. The flat roof with its projecting eaves should be generally kept intact. b. No additional storey at roof is permitted. c. Installation of building services equipment, ductwork, pipe works, etc. on the roof maybe considered, provided that their visual impact to the historic building is minimal. These new installations with architectural screenings should be setback and placed as far away from the facades as possible, and should be subjected to AMO's approval. d. All new structures and installations on roof should be subjected to Registered Structural Engineer's advice and AMO's approval. e. Repair any defective roof slab, waterproofing membrane, roof tiles etc. and conduct re-roofing work if necessary. f. Clean and remove all organic growth on roof surface and surface channels.



Projecting roof eave



Open flat roof

Item	Architectural Feature	Required Treatments
2.3	Bronze characters fixed to central bay on West Elevation	 a. The original Chinese and English bronze characters ("NORTH KOWLOON MAGISTRACY" & "北九龍裁判法院") mounted on ashlar-faced buttress panel at the centre of the projecting bay on 4/F should be preserved in-situ. b. The original bronze characters should be preserved for public appreciation. No cover of the characters, wholly or partially, is permitted. c. Stains and dirt on the surface should be washed down.
	NOR	TH KOWLOON MAGISTRACY

a. The openness of roof terrace should be kept intact. Entire terrace, including its projecting floor slab, solid parapet wall with deep overhanging coping slab, cornice mouldings at the soffit of the overhanging slab, floor finishes, thresholds to French doors, skirting and surface channels, should be preserved in-situ. b. No covering of the roof terrace, wholly or partially, is permitted. c. No alteration to openings, formation of new openings or other permanent features in the roof terrace is permitted. d. Repair any defective floor finishes, thresholds to French doors, skirting and surface channels as necessary, with materials match existing. e. Repair any defective rendered at solid parapet wall, coping the paraget wall approach to some solid parapet wall, coping the paraget wall approach to some solid parapet wall, coping the paraget wall approach to some solid parapet wall, coping the paraget wall approach to some solid parapet wall, coping the paraget wall approach to some solid parapet wall approach to some solid parapet wall, coping the paraget wall approach to some solid parapet wall approach to solid parapet wall approach to solid parapet wall appr	Item	Architectural Feature	Required Treatments
coping slab. Refinish to match existing as necessary.	2.4	Roof terrace on 4/F	terrace, including its projecting floor slab, solid parapet wall with deep overhanging coping slab, cornice mouldings at the soffit of the overhanging slab, floor finishes, thresholds to French doors, skirting and surface channels, should be preserved in-situ. b. No covering of the roof terrace, wholly or partially, is permitted. c. No alteration to openings, formation of new openings or other permanent features in the roof terrace is permitted. d. Repair any defective floor finishes, thresholds to French doors, skirting and surface channels as necessary, with materials match existing. e. Repair any defective rendered at solid parapet wall, coping slab, and cornice mouldings at the soffit of the overhanging



Roof terrace with solid parapet on 4/F



Roof terrace with surface channel



Solid parapet with deep overhanging coping



Cornice mouldings at the soffit of the overhanging coping slab



Steel French doors with threshold

Item	Architectural Feature	Required Treatments
2.5	Balcony on 3/F	 a. The ambiance and natural ventilation of balcony on three sides should be kept intact. Entire balcony, including its columns, roof slab, ornamental ironwork balustrades, mosaic tiled floor finishes, surface channels, skirting and projecting floor slab, should be preserved in-situ. b. No enclosure of the balcony, wholly or partially, is permitted. c. No alteration to openings or formation of new openings, suspended ceiling system or other permanent features in the balcony are permitted. d. No alternation to ornamental ironwork balustrades is allowed. Stains and dirt on the surface should be washed down. e. Repair any defective floor tiles and surface channels as necessary, with materials match existing. f. Repair any defective rendered walls and ceiling as necessary, and refinish to match existing.













Item	Architectural Feature	Required Treatments
2.6	Canopy above main entrance with flagpole	 a. Deep projecting concrete canopy, including the inverted beamand-slab structure and surface channels should be preserved insitu. b. Repair any defective rendered at the canopy. Refinish to match existing as necessary. c. Remove the temporary signage, make good as necessary. d. Installation of temporary signage in a reversible manner and without causing adverse visual impact to hinder public appreciation to the main façade might be considered, and should be subjected to AMO's approval. g. Original metal flagpole fixed on concrete mass to be preserved in-situ. Stains and dirt on the surface should be washed down.
	Japania R	one in the second of the secon

Item Architectural Feature	Required Treatments
double staircases b.	Double half-turn open symmetrical grand staircases from street level to main entrance at piano-nobile on G/F comprising flights of granite steps (including the three granite steps at street level), granite landings, string course decoration, spandrels, and ornamental ironwork balustrades, should be preserved in-situ. All granite surfaces shall be cleaned with bristle or nylon brushes and clean water as necessary, and no corrosive cleaning chemical is allowed. No paintings should be applied on all granite surfaces. No alternation to ornamental ironwork balustrades is allowed. Stains and dirt on the surface should be washed down. Remove the temporary signage, make good as necessary.

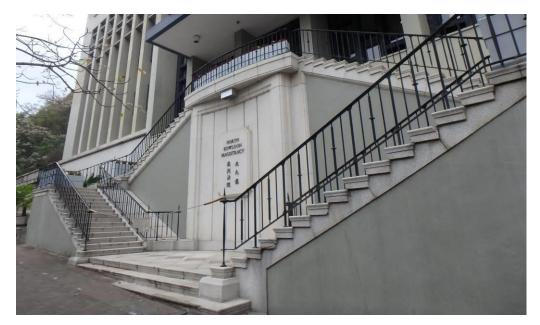

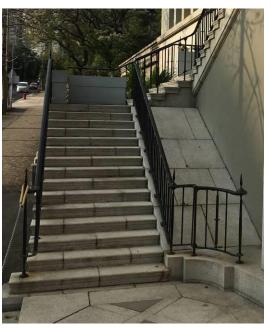



Item	Architectural Feature	Required Treatments
2.8	Buttress	a. Projecting ashlar-faced buttress between the staircase spandrels with grooved or recessed joints to the stonework, and a moulded name tablet set in a recessed panel should be preserved in-situ.b. Stains and dirt on the surface should be washed down.
		NORTH KOWLOON MAGISTRACY 截 北 到 九 法 截

Item	Architectural Feature	Required Treatments
2.9	Stone tablet	 a. Stone tablet mounted on a projecting ashlar-faced buttress with the Chinese and English bronze characters ("NORTH KOWLOON MAGISTRACY" & "北九龍裁判法院") should be preserved in-situ. b. The bronze characters should be preserved for public appreciation. No cover of the characters, wholly or partially, is permitted. c. Stains and dirt on the surface should be washed down.
		NORTH KOWLOON MAGISTRACY 競 地 判 九 法 院 龍

Item	Architectural Feature	Required Treatments
2.10	Main entrance bronze door case with bronze doors	 a. Main entrance door comprises a pair of bronze studded panel cladding doors in a moulded bronze door case framed with moulded architraves, completes with handles, bolts, locks and hinges, should be preserved in-situ. b. The bronze doors should be preserved for public appreciation. No cover of the door, wholly or partially, is permitted. c. Installation of new ironmongeries to the bronze doors should be avoided. d. Stains and dirt on the surface should be washed down by appropriate cleaning agent.

Interior view

Exterior view

Item	Architectural Feature	Required Treatments
2.11	Entrance stone door cases with steps	 a. Carved stone door case, including the moulded architrave, cornice crown moulding, ashlar-faced canopy, with granite door threshold and steps, should be preserved in-situ. b. No alteration and enlargement of door openings is allowed. c. All stone surfaces shall be cleaned with bristle or nylon brushes and clean water as necessary, and no corrosive cleaning chemical is allowed. d. Any improvement works to the access steps to fulfill the prevailing statutory requirements that are installed in a reversible manner may be considered, provided their visual impact and physical impact to the historic building is kept to be minimal, and is subjected to AMO's approval. e. The proposed works should be compatible and distinguishable from the historic building.




Entrance stone door case facing South Open Forecourt




Entrance stone door case facing North Open Forecourt

Item	Architectural Feature	Required Treatments
2.12	Entrance wooden doors	 a. Entrance doors and fanlights, including door jambs and door head, facing South Open Forecourt and North Open Forecourt should be preserved in-situ. b. The wooden panelled doors and frames including the decorative mouldings at the door faces, though not historical elements were reconstructed with design mimic the old wooden doors, should be re-used as far as practical. c. Existing ironmongeries are new to fulfil the statutory requirements or suit the operational need. Alteration or replacement of ironmongeries for security reasons to suit operational needs may be permitted, and is subjected to AMO's approval.
		d. No air-conditioning units and any associated ducting and supports attaching to, passing through and disturbing the doors are permitted.
		e. Check for proper operation and any water ingress, repair as necessary.

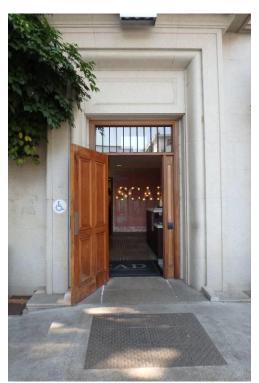

Entrance wooden door facing South Open Forecourt

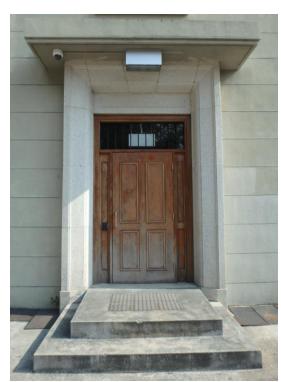

Entrance wooden door facing North Open Forecourt

Ite	m Architectural Feature	em A	Required Treatments
2.1		.13 <u>Sto</u>	 Steel French door openings, including steel French doors and fanlights with steel frames to roof terrace on 4/F and balcony on 3/F should be preserved in-situ. No alteration and enlargement of door openings is allowed. Check for proper operation and any water ingress, repair and repaint as necessary to match existing. Stains and dirt on the surface should be washed down by appropriate cleaning agent.





Item	Architectural Feature	Required Treatments
2.14	Window openings and Steel Windows	 a. All regularly spaced window openings including transomed steel windows with granite cills or window surrounds at external, ironmongeries and internal terrazzo cills should be preserved in-situ. b. No alteration and enlargement of window openings is allowed. c. Alteration of window frames and ironmongeries, including installation of metal louvers, fire damper etc. to suit the new use may be considered, and is subjected to AMO's approval. d. Some of the existing windows were altered to fulfil the statutory requirements or suit the operational need. Conduct research on the original design of the windows, and restore the window to the original design if the altered window could not suit the new use. e. Take down all window type air-conditioning units or abandoned building services fixed to window frames and make good the window frames and/or glazings to match with original design. f. Repair cracks on the existing window cills with materials match existing as appropriate.
		g. Stains and dirt on the surface should be washed down by appropriate cleaning agent.h. Check for proper operation and any water ingress, repair and repaint as necessary to match existing.



















Item	Architectural Feature	Required Treatments
2.15	Decorative glazed tiles	 a. Decorative glazed tiles, including bullnose tiles and recess tiles, with groove lines mortared on apron panels and jamb tiles surround the steel window frames, should be preserved insitu. b. No covering up of decorative tiles is allowed. c. Any damaged decorative tiles should be carefully removed and replaced with matching colour tile if and only if the tile is beyond repair.







Item	Architectural Feature		Required Treatments
2.16	Original Garage Openings on GF	b. c.	The original wall openings for the old Police Van Garage with old metal gates and the old Magistrate's Garage facing North Open Forecourt should be preserved in situ. No alteration to the openings are permitted. Check for proper operation for the old metal gates, repair as necessary to match existing. Window walls were installed to convert the Magistrate's Garage to indoor space, no objection to remove the window walls if it could not suit the new use. Alteration or replacement of the window walls to suit operational needs but maintaining the existing transparency may be permitted, and is subjected to AMO's approval.



Original wall opening for the old Police Van Garage with old metal gate



Original wall opening for the old Magistrate's Garage

Item	Architectural Feature	Required Treatments
2.17	Wall openings with old steel gates at the East elevation	a. The wall openings with old steel gates on LG/F at the East elevation should be preserved in situ.b. Check for proper operation for the old steel gates, repair and repaint as necessary to match existing.

Item	Architectural Feature	Required Treatments
2.18	Wall openings and grill blocks	 a. Wall openings infilled with precast grill blocks for natural ventilation at staircase enclosures and pipe duct shafts at the external walls should be preserved in-situ. b. Any patterns formed with the grill blocks should not be filled up. c. Some of the wall openings were block internally to fulfil the statutory requirements or suit the operational need. Blocking of wall openings from internal side in a reversible manner may be
		considered, and is subjected to AMO's approval.







Item	Architectural Feature	Required Treatments
2.19	Central light well (on 3/F, 4/F and 5/F)	a. Central light well, exhaust fan housings with glass block roof light at 2/F soffit, and steel windows should be preserved insitu.
		 b. The central light well was covered with a skylight installed at roof level to suit the operational need. Covering to the central light well may be considered, provided that the natural daylight ambiance could be maintained, and is subjected to AMO's approval. d. Repair and make good to the glass block roof light at 2/F soffit, rectify any water leakage as necessary. Any damaged glass blocks should be carefully removed and replaced with material match existing, if and only if the glass block is beyond repair.
		beyond repair.






3. MAIN BUILDING – INTERIOR

Item	Architectural Feature	Required Treatments
3.1	Building Structure	 a. All structural elements including columns, beams, floor and roof slabs, etc. should be kept intact as far as practicable. b. The existing provisions of means of escape (MOE) staircases (ST-1, ST-2 and ST-3), and barrier free access including accessible lift (LT-1) should be reused in order to avoid extensive alteration to the structural elements. c. Apart from point (b), conduct research on the original layout and structure, remove the later-added structure and reinstate to suit the new use as far as practicable, and is subjected to AMO's approval. d. Improvement of running of services and circulation as required by design and statutory requirements that are constructed in a reversible manner may be considered. The design for coring or forming of new openings or alteration of existing opening on the structure elements is subjected to Registered Structural Engineer's advice and AMO's approval. e. Repair all spalled concrete and other defects as necessary. f. Any strengthening works required to meet statutory requirements may be considered and should be subjected to Registered Structural Engineer's advice and AMO's approval. However, strengthening or recasting in the conserved spaces in the old Court Rooms No. 1 to 4 on 2/F, the old Detention Cells on G/F, the Central Halls on G/F to 2/F, the conserved Defendant Staircase and the conserved Magistrates Staircases should be avoided as far as practicable.






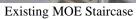



Existing accessible lift

Item	Architectural Feature	Required Treatments
3.2	Central Halls	a. The configuration of entrance hall on G/F which had been altered in the 1970s, should be restored to its original symmetrical design, while the Central Halls on 1/F and 2/F should be kept intact. No new opening should be formed on walls unless approved by the AMO.
		 b. The random pattern stone flooring on G/F and the marble wall cladding with black marble skirting on G/F to 2/F should be preserved in-situ. Clean and repair the stone flooring and marble cladding and skirting as necessary to match existing. c. The ornamental ironwork balustrades with wooden handrails, the metal guard bars around the central hall staircase void and
		the ornamental metal handrails and guard bars to vertical windows should be preserved in-situ. Clean, repair and repaint the ironwork and woodwork as necessary to match existing.
		d. Later-added glass barriers to the balustrades and metal guard bars to meet statutory requirements should be reused as far as practicable.
		e. Any suspended ceilings should allow the moulding details at ceiling beams and the window profiles to be fully exposed and uninterrupted.

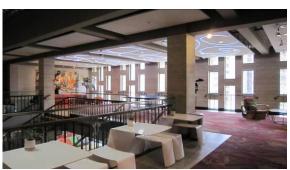











Item	Architectural Feature	Required Treatments
3.3	Central Staircase	 a. The central staircase from G/F to 2/F including the stone finishes to treads and risers, the square mouldings at the sides and the ornamental ironwork balustrades with wooden handrails featuring fleur-de-lis motifs should be preserved insitu. b. Repair, replaster and repaint the staircase including ironwork and woodwork to match existing as necessary. c. Upgrading works to the existing handrails and balustrades to meet the statutory requirements should be avoided as far as practicable subjected to the approval of Buildings Authority. In case upgrading works are required, modification works should be carried out in a reversible manner. The design should be distinguishable from and compatible with the existing handrails and balustrades and is subjected to AMO's approval. d. The marble cladding with black marble skirting on walls should be preserved in situ. Clean and repair as necessary. e. Do not block the glass blocks roof lights at 2/F ceiling.
	1	







Item	Architectural Feature	Required Treatments
3.4	Old Detention Cells No. 2, 3, 4, 5 and 7	 a. The remains of the old Detention Cells No. 2, 3, 4, 5 and 7 including all original configurations, metal guard bars and grilles, all metal gates with mortice locks, and all half-height partitioned squat toilets with white tiled wall finishes and mosaic tiled floor finishes should be preserved in-situ. b. Clean, repair the ironwork and the tiled finishes as necessary to match existing. c. No objection to reuse the later-added glass partitions and glass doors. Alteration to the existing walls or addition of new partitions is not allowed except for restoration works and unless approved by the AMO, and is subjected to the advice of a Registered Structural Engineer. d. Reuse the existing openings on walls and the metal guard bars and grilles for running of services as far as practicable. Any alteration to existing opening or forming of new opening on walls and the metal guard bars and grilles should be approved by the AMO. e. Covering up the half-height partitioned squat toilets in a reversible manner could be considered and is subjected to AMO's approval.











Item	Architectural Feature	Required Treatments
3.5	Conserved Detention Cell No. 6	 a. The conserved Detention Cell No. 6 with its original configuration and layout including the metal guard bars and grilles, the metal gate with mortice lock, the half-height partitioned squat toilet with white tiled wall finishes and mosaic tiled floor finishes, concrete benches, painted wall finishes with dado coloured grey, and with its upper portion painted white, the historic graffiti on walls, the original concrete flooring and the wash basin outside the cell should be preserved in-situ. b. Clean and repair the ironwork and tiled finishes as necessary to match existing. c. Repaint the walls and the concrete benches to match existing colour scheme as necessary, carefully remove the new graffiti on walls and avoid damaging the historic graffiti on walls. d. Reuse the existing wall openings, the air duct, the light fittings and the fire services installation as far as practicable. Any alteration to existing opening or forming of new opening on walls and the metal guard bars and grilles should be approved by the AMO.













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Item	Architectural Feature	Required Treatments
3.6	Old Control Corridors on G/F	a. A portion of the old control corridors on G/F from the old Police Van Garage (existing common area) to the old detention cells and from the old detention cells to the metal gate of conserved Defendant Staircase had been altered in last renovation with additions of new door openings along the corridors which disturbed the atmosphere of a controlled environment.
		 environment. b. Research study on the original layout of control corridors should be carried out. The unaltered portions should be preserved in-situ while the altered portions should be restored or re-planning in order to enhance the atmosphere of a controlled environment as far as practicable and is subjected to AMO's approval. c. The modified metal gate should be restored to its original appearance, while the other 3 nos. of metal gates, and the retained metal guard bars at window openings at high levels should be preserved in-situ. d. Metal guard bars which had been installed at the window openings along the original control corridors but were later-removed should be restored according to the research study. e. Reuse the existing openings on walls and the metal guard bars and grilles for running of services as far as practicable. Any alteration to existing opening or forming of new opening on walls and the metal guard bars and grilles should be approved by the AMO. f. Clean, repair the existing finishes and repaint the metal guard
		bars as necessary to match existing. g. No objection to repaint the wall in a reversible manner with different colour scheme, but the design should be subjected to AMO's approval.













Item	Architectural Feature	Required Treatments
Item 3.7	Architectural Feature Conserved Court Room No.1 on 2/F	 a. The conserved Court Room No. 1 with the original configuration and settings should be preserved in-situ including: i) the sound lobby with wooden ceiling, the upper fixed glass panels and frames, and a pair of wired glass panelled wooden inner doors and door frame; ii) public wooden benches on raised steps, the wooden bench of the press corner and the half-height wooden barrier and gate separating the public area; iii) Prisoner's Dock and the security bars, and the wooden panelled door and frame for prisoners/ defendants behind; iv) Clerk's bench, the witness box with wooden chair and court reporter's desk on low wooden raised platform; v) Magistrate's bench on high wooden raised platform, the backdrop wall including the full height wooden wall panelling at both sides, and the moulded frame, the acoustic panels and the Bauhinia plaque at the centre, the wooden steps to the high wooden raised platform and the wooden handrail, the wooden panelled door and door frame for magistrates; vi) and wall finishes with wooden wall panelling on the lower portion and acoustic panels on the upper portion, timber parquet flooring, and the mouldings on ceiling beams. b. Clean and repair all defective fittings, finishes and furniture as necessary to match existing. c. Do not block the double-height steel windows, addition of shades or blinds in front of windows in a reversible manner could be considered and the design should be subjected to AMO's approval. d. Reuse the existing wall openings, the air duct, the light fittings and the fire services installation as far as practicable.
		Any alteration to existing opening or forming of new opening on walls should be approved by the AMO. e. No suspended ceiling system is permitted.





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Item	Architectural Feature		Required Treatments
3.8	Old Court Room No. 2, 3, and 4 on 2/F	a. b. c. d.	The configurations of the old Court Room No. 2. 3 and 4 should be generally kept intact. Partitioning inside each court room should not block the existing double-height steel windows and should kept to a minimum in order to reveal the original spacious rectangular design of court rooms. All later-added partitions which blocked the double-height steel windows and all false ceiling system installed should be removed to expose the double-height steel windows and the original double-storey ceiling height design as far as practicable. No additional storey should be constructed inside the original double-height spacing. Do not block the double-height steel windows, addition of shades or blinds in front of windows in a reversible manner could be considered and the design should be subjected to AMO's approval. Running of services inside the court room should be redesigned, grouped together, and concealed inside bulkhead as necessary to reduce the visual impact and to expose the mouldings on ceiling beams as far as practicable.
		1	













Item	Architectural Feature	Required Treatments
3.9	Old Court Rooms Entrance Doors on 2/F	 a. The original wooden paneled double doors of the old Court Room No. 1-4, including all door frames, wooden door head panels with mouldings, metal signages and all old ironmongeries should be preserved in-situ. b. Clean the doors and repair any defective parts to operable status as necessary.









Item	Architectural Feature		Required Treatments
3.10	Architectural Feature Conserved Defendant Staircase	a. b.	Required Treatments The conserved Defendant Staircase leading from the detention cells on G/F to the conserved Court Room No. 1, including the metal gates and metal guard bars, the white nosing tiles and the white ceramic tiled wall finishes, and the glass block windows on 2/F should be preserved in-situ. Since the staircase was not retained as main circulation but for interpretation only, same approach should be adopted to avoid any upgrading works to the existing staircase as far as practicable, subjected to the approval of Buildings Authority. In case upgrading works or addition of protective barriers or handrails to the existing staircase to meet statutory requirements are required, all works should be carried out in a reversible manner. The design should be distinguishable from
		c. d.	and compatible with the existing staircase and is subjected to AMO's approval. Clean, repair and repaint the existing finishes and metal guard bars as necessary to match existing. Reuse the existing wall openings, the light fittings and the fire services installation as far as practicable. Any alteration to existing opening or forming of new opening on walls and the metal guard bars and grilles should be approved by the AMO.










a. The conserved portion of Magistrates' Staircase leading from the conserved Court Room No. 1 on 2/F to 3/F where the conserved conserved in stail to the treads, risers and skirtings, at the stail to the treads, risers and skirtings, at the stail to the treads, risers and skirtings, at the stail to the treads, risers and skirtings, at the stail to the treads, risers and skirtings, at the stail to the treads, r
as necessary to match existing. e. Reuse the existing wall openings, the light fittings and the fit services installation as far as practicable. Any alteration existing opening or forming of new opening on walls show

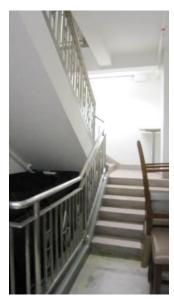





Item	Architectural Feature	Required Treatments
3.12	Old Ducts Rooms on 3/F	The configuration of the 4 nos. of old ducts rooms (existing ducts rooms and stores) on 3/F with the existing ventilation duct openings on floor to the old court rooms below and the wall openings to the external wall should be preserved in-situ.









Panelled Doors Item 3.9, all other old wooden panelled doors installed in historic building including the door frames and the ironmongeries should be reused as far as practicable. b. Old wooden panelled doors at the Old Duct Rooms (Item 3.12) should be preserved in-situ, while relocation of other old doors installed in historic building to suit new layout could be considered. c. For all the salvaged doors which are being stored, check the conditions and document all the salvaged doors and frames by photos and drawings, assess the level of significance of each door and explore ways to reuse or display the salvaged doors on site as far as practicable (otherwise the salvaged doors are still required to be stored properly within the site). Submit the condition report, the documentations and the proposal for the doors to AMO for approval.	Item	Architectural Feature	Required Treatments
defective parts to operable conditions as necessary to match	3.13		 Item 3.9, all other old wooden panelled doors installed in historic building including the door frames and the ironmongeries should be reused as far as practicable. b. Old wooden panelled doors at the Old Duct Rooms (Item 3.12) should be preserved in-situ, while relocation of other old doors installed in historic building to suit new layout could be considered. c. For all the salvaged doors which are being stored, check the conditions and document all the salvaged doors and frames by photos and drawings, assess the level of significance of each door and explore ways to reuse or display the salvaged doors on site as far as practicable (otherwise the salvaged doors are still required to be stored properly within the site). Submit the condition report, the documentations and the proposal for the doors to AMO for approval. d. Clean, treat with wooden preservative treatment and repair the defective parts to operable conditions as necessary to match existing for all the wooden doors to be preserved in-situ,














Architectural Feature	Required Treatments
Architectural Feature All Old Metal Guard Bars and Gates	 a. All existing metal guard bars and gates installed in historic building should be preserved in-situ and repaired as necessary unless approved by the AMO. b. For all the salvaged metal guard bars and gates which are being stored, check the conditions, document all the salvaged metal guard bars and gates by photos and drawings, assess the level of significance of each metal guard bars and gate, and explore ways to reuse or display the salvaged metal guard bars and gates on site as far as practicable (otherwise the salvaged guard bars and gates are still required to be stored properly within the site). c. If any salvaged metal guard bars on windows with fleur-de-lis motifs is found, investigate its original location, repair as necessary and restore to the original location as far as practicable. d. Submit the condition report, the documentations and the proposal for all the salvaged metal guard bars to AMO for approval. e. Clean, repair the defective parts and repaint as necessary for all the old metal guard bars to be preserved in-situ, reused,
	displayed or restored.
	All Old Metal Guard





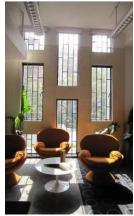








Item	Architectural Feature	Required Treatments
3.15	Splayed and moulded plaster cornices at ceilings	 a. All splayed and moulded plaster cornices at ceilings should be preserved in-situ. b. Repair and repaint as necessary. c. Suspended false ceilings may be considered, the design should allow the moulding details at ceilings and the window profiles to be fully exposed and uninterrupted, and is subjected to AMO's approval.



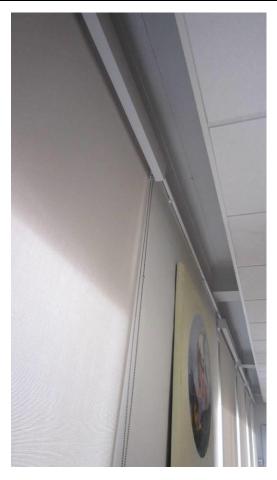

Item	Architectural Feature	Required Treatments
3.16	Other Salvaged Items	 a. All other salvaged items including furniture, fittings and signages which are being reused, displayed and stored should be preserved within the site unless approved by the AMO. b. Check the conditions and document all the salvaged items by photos and drawings. Reuse and display all the salvaged items as far as practicable. c. Clean and repair the salvaged items as necessary to match existing.

















Appendix XI

List of Recommended Treatment to Architectural Features

Former North Kowloon Magistracy Recommended Treatments to Architectural Features

1. EXTERNAL GROUNDS

Item	Architectural Feature		Recommended Treatments
1.1	Ancillary facilities at the South Open Forecourt and North Open Forecourt of the Historic Building (Later-Addition)	b. с.	South Open Forecourt accommodates later-added ancillary facilities, e.g. designated parking space for persons with disabilities, fire services pump room and tank, cabinet for fire services and sprinkler inlets, check meter cabinet, cooling tower for air-conditioning system etc. North Open Forecourt accommodates later-added cabinet for fire services inlets. Reuse the later-added facilities as far as possible. Installation/ alternation of building services equipment, ductwork, pipe works, etc. maybe considered, provided that their visual impact to the historical building is minimal. These new installations with architectural screenings should be placed as far away as possible from the historic building, and should be subjected to AMO's approval. No objection to change the color scheme of the ancillary facilities, and is subjected to AMO's approval.









2. MAIN BUILDING - EXTERIOR

Item	Architectural Feature	Recommended Treatments
2.1	External exit staircase at East elevation (Later-Addition)	a. A covered exit staircase was reconstructed from G/F to 1/F at East elevation to fulfil statutory requirement. Reuse the staircase as far as possible.b. No objection to change the color scheme of the exit staircase, and is subjected to AMO's approval.

Item	Architectural Feature	Recommended Treatments
2.2	Flue for exhaust of emergency generator at East elevation (Later-Addition)	a. Flue for exhaust of emergency generator was constructed from G/F to R/F at East elevation. Reuse the facilities as far as possible.b. Check for proper operation and repair as necessary.

Item	Architectural Feature	Recommended Treatments
2.3	Building services/ installation at flat roof (Later-Addition)	 a. Skylight, glazed lift overrun enclosure, lightning protection system, exhaust chimney for emergency generator and metal balustrades were constructed at flat roof to fulfil statutory requirement and operation use. Reuse the facilities as far as possible. b. Check for proper operation and repair as necessary.
		Skylight Glazed lift overrun enclosure
	Metal	palustrades Exhaust chimney for emergency generator

Access hatch

lightning protection system


Item	Architectural Feature	Recommended Treatments	
2.4	Fall arrest system at the canopy above main entrance (Later-Addition)	a. Fall arrest system was installed to fulfil statutory requirement and operation need. Reuse the system as far as possible.b. Check for proper operation and repair as necessary.	



Item	Architectural Feature	Recommended Treatments
2.5	Roof terrace on 4/F and balcony on 3/F	 a. 'Access for maintenance only' was adopted at roof terrace on 4/F and balcony on 3/F to strike a balance between maintaining the architectural authenticity and complying with statutory requirement in previous statutory submission. b. Adoption of similar approach as far as possible to preserve the roof terrace/ balcony in-situ is recommended.
	NO	RTH KOWLOON MAGISTRACY
		Balcony on 3/F Roof terrace on 4/F

Item	Architectural Feature	Recommended Treatments
2.6	Symmetrical grand double staircases	 a. Management approach, including the double staircase will not be used as access to the building, occasion access would be monitored and supervised by attendants, permanent signs to be erected to notify the public that access cannot be gained, barriers to be placed at designated area of the staircase landings to provide addition protection etc., was adopted to strike a balance between maintaining the architectural authenticity and complying with statutory requirement in previous statutory submission. b. Adoption of similar management approach as far as possible to preserve the grand double staircase in-situ is recommended.



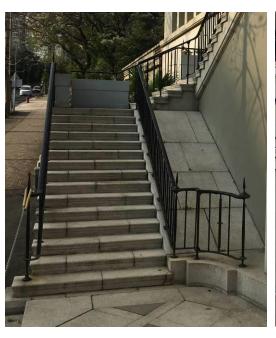



Item	Architectural Feature	Recommended Treatments
2.7	Main entrance bronze door case with bronze doors	 a. Management approach, i.e. the bronze doors will normally be closed to public, was adopted to strike a balance between maintaining the architectural authenticity and complying with statutory requirement in previous statutory submission. b. Adoption of similar management approach as far as possible to preserve the bronze doors in-situ is recommended.

ramp and steps the existing granite steps at the side entrance facing S	Item Architectural Fe	ature	Recommended Treatments
requirements. Reuse the barrier free access as far as possib b. Additional steps were constructed on top of the existing gr steps at the side entrance facing North Open Forecourt		b.	±



Exterior view

Addition barrier free access ramp facing South Open Forecourt




Interior view


Addition access steps facing North Open Forecourt

Item	Architectural Feature	Recommended Treatments
2.9	Steel French doors to roof terrace on 4/F and balcony on 3/F	a. Steel French doors gaining access to roof terrace on 4/F and balcony on 3/F were locked for maintenance only to fulfill the statutory requirement in previous statutory submission.b. Adoption of similar approach as far as possible is recommended.

3. MAIN BUILDING - INTERIOR

Item	Architectural Feature	Recommended Treatments
3.1	Old Magistrates' Staircase	Re-planning the interior layout near ST-2 on G/F, 1/F and 2/F (refer to the areas highlighted in red below) in order to restore the demolished portions of the old Magistrates' Staircase (refer to areas highlighted in yellow below) leading from G/F North Entrance to 2/F conserved Court Room No. 1, for full interpretation of the original design of independent circulation for Magistrates from G/F entrance to the court and to office floor.
	Exist 13810	COMMON AREA COMMO
	Old G/F Pa	POLICE VAIN POLIC

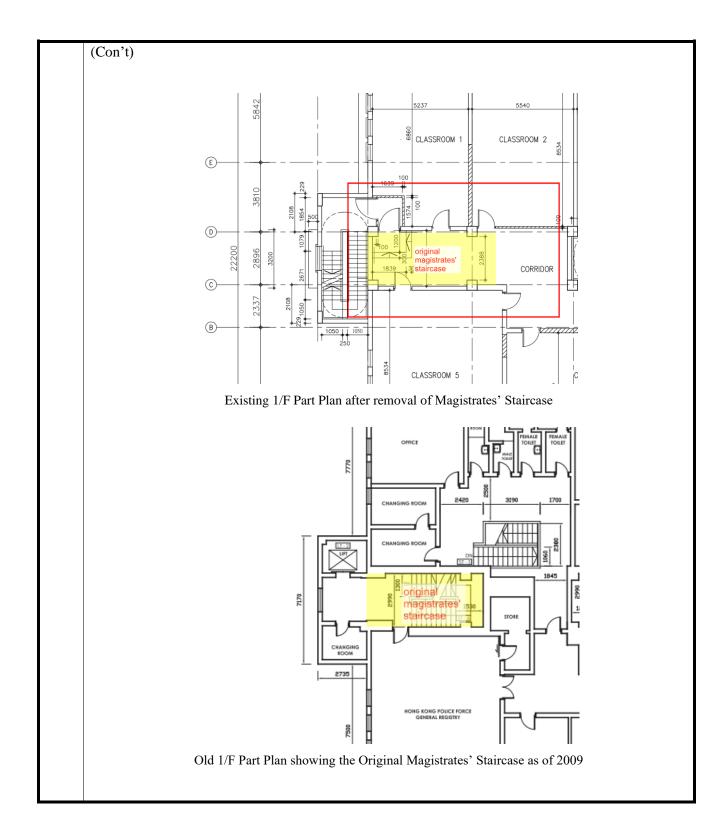

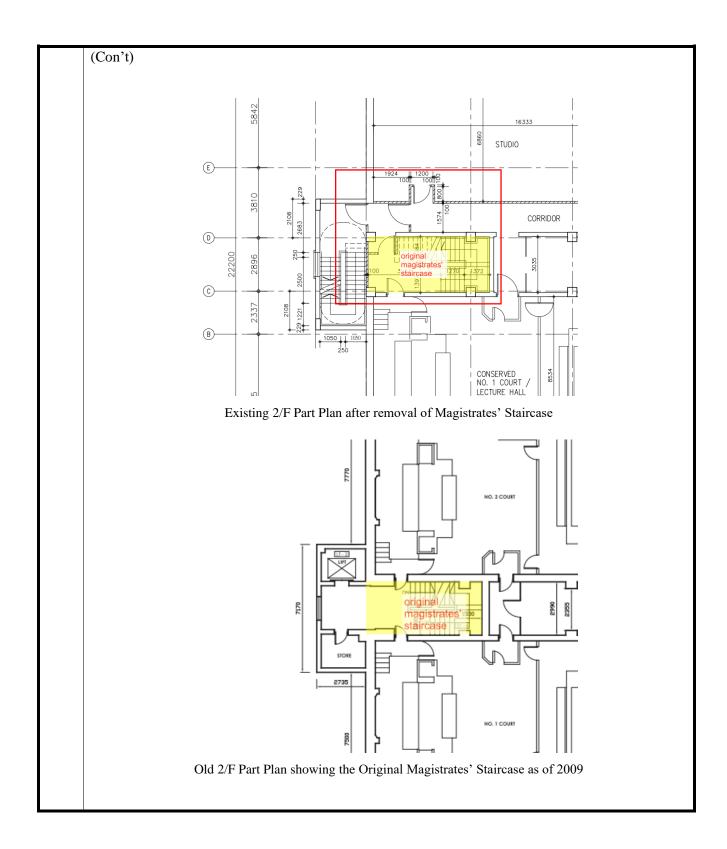

Item	Architectural Feature	Recommended Treatments
3.2	Existing building services provisions (Later-Addition)	a. Reuse the existing building services provisions inside the historic building as far as practicable.b. Any alternation or installation of new building services equipment, ductwork, pipe works etc. may be considered, provided that their visual impact to the historic building is minimal, and is subjected to AMO's approval.



Existing PAU Room



Existing Flushing Water Pump Room



Existing Emergency Generator Room



Existing Fresh Water Pump Room




Existing AC Plant Room



Existing Main Switch Room

Appendix XII

Outline Zoning Plan

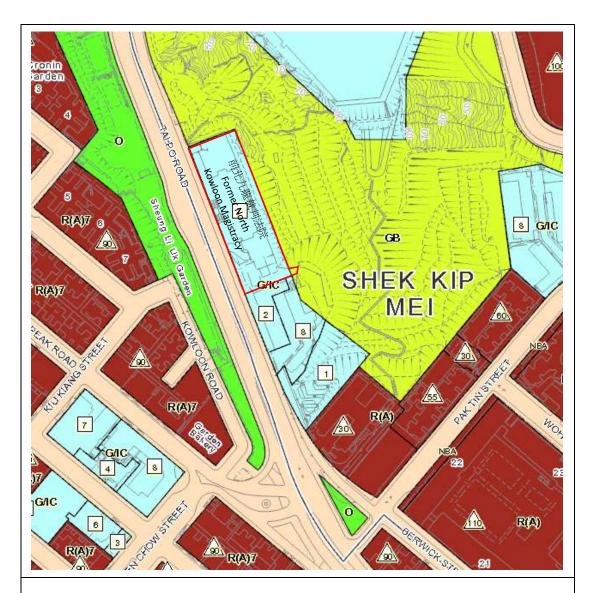

OUTLINE ZONING PLAN

(EXTRACT PLAN BASED ON WEBSITE OF TOWN PLANNING)
DATE:27.05.2020

Legend:	FORMER NORTH KOWLOON	APPENDIX XII			
Statutory Plan	MAGISTRACY	OUTLINE ZONING PLAN			
Statutory Plan OZP Zoning O Open Space GB Green Belt R(A) Residential (Group A) Gric Government, Institution or Community OU Other Specified Uses Maximum Building Height (In Metres Above Principal Datum) Maximum Building Height (In Number of Storeys) SITE BOUNDARY		NOT TO SCALE			

- 14 - S/K4/29

GOVERNMENT, INSTITUTION OR COMMUNITY

Column 1 Uses always permitted

Column 2 Uses that may be permitted with or without conditions on application to the Town Planning Board

Ambulance Depot

Animal Quarantine Centre

(in Government building only)

Broadcasting, Television and/or Film Studio

Eating Place (Canteen,

Cooked Food Centre only)

Educational Institution

Exhibition or Convention Hall

Field Study/Education/Visitor Centre

Government Refuse Collection Point

Government Use (not elsewhere specified)

Hospital

Institutional Use (not elsewhere specified)

Library Market

Place of Recreation, Sports or Culture

Public Clinic

Public Convenience

Public Transport Terminus or Station

Public Utility Installation Public Vehicle Park

(excluding container vehicle) Recyclable Collection Centre

Religious Institution

Research, Design and Development Centre

School

Service Reservoir Social Welfare Facility

Training Centre Wholesale Trade Animal Boarding Establishment Animal Quarantine Centre (not elsewhere specified)

Columbarium

Correctional Institution

Crematorium Driving School

Eating Place (not elsewhere specified)

Flat

Funeral Facility

Helicopter Filling Station Helicopter Landing Pad

Holiday Camp

Hotel House

Mass Transit Railway Vent Shaft and/or Other Structure above Ground Level other than

Thuesare above Ground Beve

Entrances

Off-course Betting Centre

Office

Petrol Filling Station Place of Entertainment

Private Club

Radar, Telecommunications Electronic

Microwave Repeater, Television and/or

Radio Transmitter Installation Refuse Disposal Installation (Refuse Transfer Station only)

Residential Institution

Sewage Treatment/Screening Plant

Shop and Services

Utility Installation for Private Project

Zoo

Planning Intention

This zone is intended primarily for the provision of Government, institution or community facilities serving the needs of the local residents and/or a wider district, region or the territory. It is also intended to provide land for uses directly related to or in support of the work of the Government, organizations providing social services to meet community needs, and other institutional establishments.

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GOVERNMENT, INSTITUTION OR COMMUNITY (Cont'd)

Remarks

- (1) On land designated "Government, Institution or Community" ("G/IC"), no new development, or addition, alteration and/or modification to or redevelopment of an existing building shall result in a total development and/or redevelopment in excess of the maximum building heights in terms of number of storey(s) or metres above Principal Datum (mPD) as stipulated on the Plan, or the height of the existing building, whichever is the greater.
- (2) On land designated "G/IC(1)", "G/IC(2)", "G/IC(3)", "G/IC(4)", "G/IC(5)", "G/IC(6)", "G/IC(7)" and "G/IC(8)", no new development, or addition, alteration and/or modification to or redevelopment of an existing building shall result in a total development and/or redevelopment in excess of the maximum plot ratio, building height, gross floor area specified below, or the plot ratio, building height, gross floor area of the existing building, whichever is the greater:

Sub-Area	Restriction					
G/IC(1)	a maximum building height of 10.67m					
G/IC(2)	a maximum building height of 46mPD					
G/IC(3) a maximum building height of 51mPD						
G/IC(4)	sub-area (A) - a maximum building height of 70mPD					
	sub-area (B) - a maximum building height of 119.5mPD					
G/IC(5)	a maximum gross floor area of 27 400m² and a maximum building height of 112mPD					
G/IC(6)	a maximum plot ratio of 3.37 and a maximum building height of 134.9mPD					
G/IC(7)	a maximum building height of 112mPD					
G/IC(8)	a maximum building height of 38mPD					

- (3) In determining the relevant maximum number of storey(s) for the purposes of paragraph (1) above, any basement floor(s) may be disregarded.
- (4) Based on the individual merits of a development or redevelopment proposal, minor relaxation of the plot ratio/gross floor area/building height restrictions stated in paragraphs (1) and (2) above may be considered by the Town Planning Board on application under section 16 of the Town Planning Ordinance.

(Please see next page)

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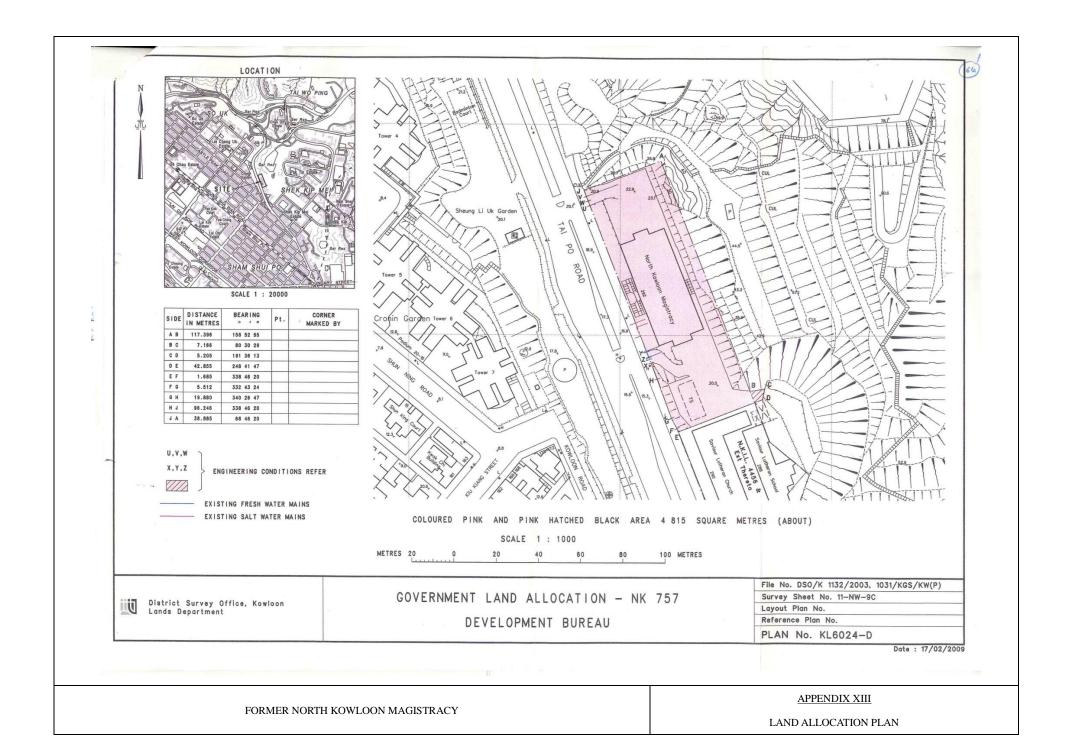
GOVERNMENT, INSTITUTION OR COMMUNITY (Cont'd)

Remarks (Cont'd)

- (5) On land designated "G/IC(5)", the maximum building height as set out in paragraph (2) above may, upon obtaining permission of the Town Planning Board under section 16 of the Town Planning Ordinance, be increased to a maximum of 135mPD, with the support of a visual and landscape impact assessment and any other information as may be required by the Town Planning Board.
- (6) Under exceptional circumstances, for developments and/or redevelopments, minor relaxation of the non-building area restrictions as shown on the Plan may be considered by the Town Planning Board on application under section 16 of the Town Planning Ordinance.

Appendix XIII

Land Allocation Plan



Appendix XIV

Tree Schedule

TREE IDENTIFICATION SCHEDULE

PROJECT: Resource Kit for Former North Kowloon Magistracy

Site Location: Submission: Former North Kowloon Magistracy, no. 292 Tai Po Road, Sham Shui Po, Kowloon Third Submission - 27 June 2020

Topographic Survey: Tree Survey:

From Henry Chan Surveyors Ltd, drawing No. HC-15181/01 dated May 2020 By Wong Yun Keung (ISA-CA no. HK-0007BUM, TRAQ, HKILA-AA no. AA024) dated 16 May & 13 June 2020

This schedule to be read in conjunction with Tree Survey Plan Drawing No. TS-01

Tree ID Number	Tree Specie	es ¹	Location ²		Tree Size ²		Coord	linate ²	Top of Soil Level above Root Zone (mPD) ²	Health	Form	Structure	Amenity Value	Anticipated Survival Rate after Transplanting	Registered OVT/ Potential OVT ³	Conservatio n Status ^{1, 4}	Hazardous Tree	Proposed Treatment	Remarks
	Scientific name	Chinese name		Height (m)	Spread (m)	Girth (mm)	East	North	` ,	(Good/ Fair/ Poor/ Dead)	(Good/ Fair/ Poor)	(Good/ Fair/ Poor)	(High/ Medium/ Low)	(High/ Medium/ Low)	(OVT/ pOVT/ No)	(Cap 96/ Cap 586/ RPPHK/ IUCN/ No)	(Yes/ No)	(Retain/Transplant / Fell)	
T1	Phoenix roebelenii	日本葵	Inside Lot	3	3	360	834823.65	821851.17	23.96	Fair	Fair	Fair	Low	Low	No	No	No	Retain	Root restricted by toe planter
T2	Phoenix roebelenii	日本葵	Inside Lot	3	2	340	834821.46	821856.23	23.92	Fair	Fair	Fair	Low	Low	No	No	No	Retain	Root restricted by toe planter
T3	Phoenix roebelenii	日本葵	Inside Lot	4	4	320	834820.49	821858.86	23.92	Fair	Fair	Fair	Low	Low	No	No	No	Retain	Root restricted by toe planter
T4	Phoenix roebelenii	日本葵	Inside Lot	4	4	310	834819.29	821861.35	23.95	Fair	Fair	Fair	Low	Low	No	No	No	Retain	Root restricted by toe planter, root restricted by other tree
T5	Melia azedarach	苦楝	Inside Lot	10	7	1110	834819.12	821862.04	23.82	Fair	Poor	Fair	Low	Low	No	No	No	Retain	Unbalanced crown, co-dominant trunks, root restricted by toe planter
T6	Phoenix roebelenii	日本葵	Inside Lot	3	3	320	834817.39	821866.60	23.89	Fair	Fair	Fair	Low	Low	No	No	No	Retain	Root restricted by toe planter
T7	Phoenix roebelenii	日本葵	Inside Lot	4	3	320	834816.16	821869.31	23.83	Fair	Fair	Fair	Low	Low	No	No	No	Retain	Root restricted by toe planter
T8 T9	Melia azedarach	苦棟	Inside Lot	7 8	6	500	834815.17 834813.71	821871.51	23.94	Fair	Poor	Fair	Low	Low	No	No No	No	Retain	Unbalanced crown, root restricted by toe planter
T10	Melia azedarach	苦楝	Inside Lot Inside Lot	9	5 6	390 490	834813.54	821875.35 821875.78	23.90 23.91	Fair Fair	Poor Poor	Fair Fair	Low	Low	No No	No No	No No	Retain Retain	Unbalanced crown, root restricted by toe planter, root restricted by other Unbalanced crown, root restricted by toe planter, root restricted by other
T11	Melia azedarach Phoenix roebelenii	日本葵	Inside Lot	4	4	360	834813.11	821876.93	23.87	Fair	Fair	Fair	Low	Low	No	No	No	Retain	Root restricted by toe planter
T12	Melia azedarach	苦棟	Inside Lot	6	4	530	834812.03	821879.53	23.87	Fair	Poor	Fair	Low	Low	No	No	No	Retain	Unbalanced crown, root restricted by toe planter, root restricted by other
T13	Phoenix roebelenii	日本葵	Inside Lot	4	4	340	834811.93	821879.59	23.89	Fair	Fair	Fair	Low	Low	No	No	No	Retain	Root restricted by toe planter, root restricted by other tree
T14	Phoenix roebelenii	日本葵	Inside Lot	4	3	320	834805.98	821877.77	23.87	Fair	Fair	Fair	Low	Low	No	No	No	Retain	Root restricted by toe planter, root restricted by other tree
T15	Albizia lebbeck	大葉合歡	Inside Lot	7	5	490	834805.92	821877.50	23.85	Fair	Poor	Fair	Low	Low	No	No	No	Retain	Unbalanced crown, co-dominant leaders, root restricted by toe planter, root
																			restricted by other tree
T16	Phoenix roebelenii	日本葵	Inside Lot	4	4	330	834802.97	821876.49	23.84	Fair	Fair	Fair	Low	Low	No	No	No	Retain	Root restricted by toe planter
T17	Phoenix roebelenii	日本葵	Inside Lot	3	3	320	834800.49	821875.61	23.90	Fair	Fair	Fair	Low	Low	No	No	No	Retain	Root restricted by toe planter
T18	Phoenix roebelenii	日本葵	Inside Lot	4	3	360	834797.55	821874.29	23.79	Fair	Fair	Fair	Low	Low	No	No	No	Retain	Root restricted by toe planter
T19	Phoenix roebelenii	日本葵	Inside Lot	4	3	390	834795.12	821873.15	23.53	Fair	Fair	Fair	Low	Low	No	No	No	Retain	Root restricted by toe planter
T20	Phoenix roebelenii	日本葵	Inside Lot	3	3	350	834792.57	821872.27	22.93	Fair	Fair	Fair	Low	Low	No	No	No	Retain	Leaning, root restricted by toe planter
T21	Phoenix roebelenii	日本葵	Inside Lot	4	3	320	834825.75	821846.33	23.88	Fair	Fair	Fair	Low	Low	No	No	No	Retain	Root restricted by toe planter
T22	Ficus hispida	青果榕	Inside Lot	10	6	890	834826.87	821844.43	23.81	Fair	Poor	Fair	Low	Low	No	No	No	Retain	Unbalanced crown, root restricted by toe planter
T23	Phoenix roebelenii	日本葵	Inside Lot	5	4	320	834826.90	821843.43	23.81	Poor	Poor	Fair	Low	Low	No	No	No	Retain	Sparse crown, root restricted by other tree
T24	Macaranga tanarius var. tomentosa	血桐	Inside Lot	8	6	500	834827.20	821842.58	23.79	Fair	Poor	Fair	Low	Low	No	No	No	Retain	Leaning, unbalanced crown, cavity at lower trunk, decay at root collar, root restricted by toe planter
T25	Phoenix roebelenii	日本葵	Inside Lot	5	4	340	834827.76	821840.86	23.79	Poor	Poor	Fair	Low	Low	No	No	No	Retain	Sparse crown, root restricted by toe planter
T26	Phoenix roebelenii	日本葵	Inside Lot	4	4	340	834839.28	821811.71	20.45	Fair	Fair	Fair	Low	Low	No	No	No	Retain	Root restricted by toe planter
T27	Phoenix roebelenii	日本葵	Inside Lot	5	4	350	834840.23	821809.62	20.47	Fair	Fair	Fair	Low	Low	No	No	No	Retain	Root restricted by toe planter
T28	Phoenix roebelenii	日本葵	Inside Lot	5	5	320	834841.45	821807.02	20.60	Poor	Poor	Fair	Low	Low	No	No	No	Retain	Sparse crown, root restricted by toe planter
T29	Ficus hispida	青果榕	Inside Lot	8	6	720	834842.65	821805.64	20.49	Fair	Poor	Fair	Low	Low	No	No	No	Retain	Unbalanced crown, root restricted by toe planter
T30	Phoenix roebelenii	日本葵	Inside Lot	5	4	320	834842.33	821804.27	20.55	Fair	Fair	Fair	Low	Low	No	No	No	Retain	Root restricted by toe planter, root restricted by other tree
T31	Phoenix roebelenii	日本葵	Inside Lot	4	4	330	834843.32	821801.70	20.48	Fair	Fair	Fair	Low	Low	No	No	No		Root restricted by toe planter
T32	Phoenix roebelenii	日本葵	Inside Lot	4	4	370	834845.75	821798.40	20.88	Fair	Fair	Fair	Low	Low	No	No	No	Retain	Root restricted by toe planter
T33	Ficus hispida	對葉榕	Inside Lot	5	5	420	834845.39	821798.76	20.33	Fair	Fair	Fair	Medium	Low	No	No	No		Co-dominant trunks, vined, root restricted by toe planter
T34	Phoenix roebelenii	日本葵	Inside Lot	4	4	340	834845.19	821796.76	20.49	Fair	Fair	Fair	Low	Low	No	No	No	Retain	Root restricted by toe planter
T35	Phoenix roebelenii	日本葵	Inside Lot	4	4	350	834845.81	821794.76	20.50	Fair	Fair	Fair	Low	Low	No	No No	No		Root restricted by toe planter
T36	Phoenix roebelenii	日本葵日本葵	Inside Lot	4	4 4	330	834847.29 834848.19	821791.34	20.53	Fair	Fair	Fair	Low	Low	No No	No No	No		Root restricted by toe planter
T37	Phoenix roebelenii Phoenix roebelenii	日本葵	Inside Lot Inside Lot	3	3	320 330	834848.89	821788.72 821785.99	20.45 20.54	Fair Fair	Fair Fair	Fair Fair	Low	Low	No No	No No	No No	Retain Retain	Root restricted by toe planter
T39	Phoenix roebelenii	日本葵	Inside Lot	4	3	340	834850.03	821783.21	20.56	Fair	Fair	Fair	Low	Low	No	No	No	Retain	Root restricted by toe planter Root restricted by toe planter, root restricted by other tree
T40	Celtis sinensis	朴樹	Inside Lot	6	5	350	834850.36	821782.24	20.51	Fair	Poor	Fair	Low	Low	No	No	No	Retain	Unbalanced crown, root restricted by toe planter, root restricted by other
T41	Phoenix roebelenii	日本葵	Inside Lot	4	4	310	834850.92	821780.62	20.54	Fair	Fair	Fair	Low	Low	No	No	No	Retain	Root restricted by toe planter
T42	Aporusa dioica	銀柴	Inside Lot	5	4	320	834856.68	821776.00	21.43	Poor	Poor	Fair	Low	Low	No	No	No	Retain	Unbalanced crown, sparse crown, grown from rock crevice
T43	Morus alba	桑	Inside Lot	6	5	760	834857.52		20.12	Poor	Poor	Fair	Low	Low	No	No	No		Severely leaning, unbalanced crown, sparse crown, wounds on trunk, grown from rock crevice
T44	Heteropanax fragrans	幌傘楓	Inside Lot	2	2	550	834859.96	821774.34	19.78	Fair	Poor	Fair	Low	Low	No	No	No	Retain	Regrowth from pruned trunks, root restricted by rock slope
T45	Macaranga tanarius var.	血桐	Inside Lot	6	6	410	834860.61	821774.14	20.07	Fair	Poor	Fair	Low	Low	No	No	No	Retain	Leaning, unbalanced crown, root restricted by rock slope
T48	Ficus microcarpa	細葉榕	Inside Lot	7	6	770	834824.07	821781.11	18.63	Fair	Poor	Fair	Low	Medium	No	No	No	Retain	Leaning, unbalanced crown, large pruning wound, root restricted by road
T50	Celtis sinensis	朴樹	Inside Lot	8	8	1270	834821.63	821780.13	18.32	Fair	Poor	Fair	Low	Low	No	No	No	Retain	Severely leaning, unbalanced crown, grown on slope
T51	Ficus microcarpa	細葉榕	Inside Lot	5	8	640	834827.61	821763.68	19.85	Fair	Poor	Fair	Medium	Low	No	No	No	Retain	Unbalanced crown, forked, severely root restricted by tree ring, root restricted by u-channel, grown on slope
T52	Ficus microcarpa	細葉榕	Inside Lot	13	10	2240	834818.43	821783.81	17.63	Fair	Poor	Fair	Medium	Medium	No	No	No	Retain	Unbalanced crown, root restricted by road, grown on slope
T53	Ficus microcarpa	細葉榕	Inside Lot	12	9	840	834821.01	821793.22	18.96	Poor	Poor	Fair	Low	Low	No	No	No	Retain	Sparse crown, root restricted by building, root restricted by road
T58	Livistona chinensis	蒲葵	Inside Lot	4	4	520	834789.87	821860.55	20.49	Fair	Fair	Good	Low	High	No	No	No	Retain	Grown in portable planter
T59	Livistona chinensis	蒲葵	Inside Lot	4	4	610		821855.95	20.23	Fair	Fair	Good	Low	High	No	No	No		Grown in portable planter
T60	Livistona chinensis	蒲葵	Inside Lot	4	4	540	834793.29		19.98	Fair	Fair	Good	Low	High	No	No	No		Grown in portable planter
T61	Livistona chinensis	蒲葵	Inside Lot	4	5	520	834794.92		19.77	Fair	Fair	Good	Low	High	No	No	No		Grown in portable planter
T62	Livistona chinensis	蒲葵	Inside Lot	3	4	500	_	821842.74	19.56	Fair	Fair	Good	Low	High	No	No	No		Grown in portable planter
T63	Livistona chinensis	蒲葵	Inside Lot	3	4	620	834798.50		19.28	Fair	Fair	Good	Low	High	No	No	No		Grown in portable planter
T64	Livistona chinensis	蒲葵	Inside Lot	3	4	530	834800.28	821833.68	19.05	Fair	Fair	Good	Low	High	No	No	No		Grown in portable planter
T65	Livistona chinensis	蒲葵	Inside Lot	3	4	660	834802.03	821829.23	18.76	Fair	Fair	Good	Low	High	No	No	No	Retain	Grown in portable planter
T46	Microcos nervosa	布渣葉	Outside Lot Boundary	7	5	340	834864.65	821775.65	21.72	Poor	Poor	Fair	Low	Low	No	No	No	Retain	Unbalanced crown, sparse crown, grown from rock crevice
T47	Albizia lebbeck	大葉合歡	Outside Lot Boundary	8	6	730	834866.63	821775.96	21.64	Poor	Poor	Fair	Low	Low	No	No	No	Retain	Unbalanced crown, sparse crown, grown from rock crevice

TREE IDENTIFICATION SCHEDULE

PROJECT: Resource Kit for Former North Kowloon Magistracy

Former North Kowloon Magistracy, no. 292 Tai Po Road, Sham Shui Po, Kowloon Third Submission - 27 June 2020 Site Location:

Topographic Survey: Tree Survey:

From Henry Chan Surveyors Ltd, drawing No. HC-15181/01 dated May 2020 By Wong Yun Keung (ISA-CA no. HK-0007BUM, TRAQ, HKILA-AA no. AA024) dated 16 May & 13 June 2020

This schedule to be read in conjunction with Tree Survey Plan Drawing No. TS-01

Tree ID Number	Tree Speci	ies ¹	Location ²		Tree Size ²	2	Coor	dinate ²	Top of Soil Level above Root Zone (mPD) ²	Health	Form	Structure	Amenity Value	Anticipated Survival Rate after Transplanting	Registered OVT/ Potential OVT ³	Conservatio n Status ^{1, 4}	Hazardous Tree	Proposed Treatment	Remarks
	Scientific name	Chinese name		Height (m)	Spread (m)	Girth (mm)	East	North		(Good/ Fair/ Poor/ Dead)	(Good/ Fair/ Poor)	(Good/ Fair/ Poor)	(High/ Medium/ Low)	(High/ Medium/ Low)	(OVT/ pOVT/ No)	(Cap 96/ Cap 586/ RPPHK/ IUCN/ No)	(Yes/ No)	(Retain/Transplant / Fell)	
T49	Macaranga tanarius var. tomentosa	血桐	Outside Lot Boundary	7	3	470	834786.43	821880.46	26.15	Fair	Poor	Fair	Low	Low	No	No	No	Retain	Unbalanced form, decay on trunk, root restricted by mass concrete, grown on slope
T54	Phoenix roebelenii	日本葵	Outside Lot Boundary	2	1	320	834789.33	821871.60	22.40	Fair	Poor	Fair	Low	Low	No	No	No	Retain	Leaning, root restricted by toe planter
T55	Phoenix roebelenii	日本葵	Outside Lot Boundary	2	1	350	834786.76	821870.98	22.14	Fair	Poor	Fair	Low	Low	No	No	No	Retain	Leaning, root restricted by toe planter
T56	Ligustrum sinense	山指甲	Outside Lot Boundary	4	4	380	834788.59	821872.61	23.51	Fair	Poor	Fair	Low	Low	No	No	No	Retain	Leaning, co-dominant trunks, root restricted by other tree, grown on slope
T57	Melia azedarach	苦棟	Outside Lot Boundary	10	9	2010	834788.00	821872.47	23.21	Fair	Poor	Fair	Low	Low	No	No	No	Retain	Unbalanced crown, co-dominant branches, root restricted by other tree, grown on slope
T66	Leucaena leucocephala	銀合歡	Outside Lot Boundary	15	10	970	834868.00	821769.89	21.61	Fair	Poor	Fair	Low	Low	No	No	No	Retain	Undesirable species, leaning, unbalanced crown, grows on wall, stems intercalated with chain-linked fence
T67	Peltophorum pterocarpum	雙翼豆	Outside Lot Boundary	13	9	1730	834781.54	821881.17	23.15	Fair	Fair	Fair	Medium	Low	No	No	No	Retain	Root restricted by u-channel, grown on slope
T68	Bombax ceiba	木棉	Outside Lot Boundary	9	7	1240	834787.62	821848.73	19.10	Fair	Fair	Good	Medium	Medium	No	No	No	Retain	Root restricted by road, grown in tree pit
T69	Bombax ceiba	木棉	Outside Lot Boundary	4	3	430	834789.43	821843.45	18.85	Fair	Poor	Good	Low	Medium	No	No	No	Retain	Unbalanced form, root restricted by road, grown in tree pit
T70	Bombax ceiba	木棉	Outside Lot Boundary	9	8	1510	834791.07	821839.54	18.73	Fair	Fair	Good	Medium	Medium	No	No	No	Retain	Root restricted by road, grown in tree pit
T71	Bombax ceiba	木棉	Outside Lot Boundary	4	4	610	834792.84	821834.42	18.35	Fair	Poor	Good	Low	Medium	No	No	No	Retain	Unbalanced form, root restricted by road, grown in tree pit
T72	Bombax ceiba	木棉	Outside Lot Boundary	7	5	640	834794.65	821830.04	18.15	Fair	Poor	Good	Low	Medium	No	No	No	Retain	Unbalanced form, root restricted by road, grown in tree pit
T73	Bombax ceiba	木棉	Outside Lot Boundary	6	4	520	834796.48	821825.40	17.92	Fair	Poor	Good	Low	Medium	No	No	No	Retain	Unbalanced form, root restricted by road, grown in tree pit
T74	Bombax ceiba	木棉	Outside Lot Boundary	9	6	930	834798.31	821820.70	17.72	Fair	Fair	Good	Medium	Medium	No	No	No	Retain	Root restricted by road, grown in tree pit
T75	Bombax ceiba	木棉	Outside Lot Boundary	7	6	740	834800.28	821815.88	17.46	Fair	Fair	Good	Medium	Medium	No	No	No	Retain	Root restricted by road, grown in tree pit
T76	Bombax ceiba	木棉	Outside Lot Boundary	7	5	640	834801.61	821811.48	17.24	Fair	Fair	Good	Medium	Medium	No	No	No	Retain	Dead branches, root restricted by road, grown in tree pit
T77	Bombax ceiba	木棉	Outside Lot Boundary	8	6	860	834818.23	821768.89	14.88	Fair	Fair	Good	Medium	Medium	No	No	No	Retain	Root restricted by road, grown in tree pit
T78	Bombax ceiba	木棉	Outside Lot Boundary	6	4	490	834820.22	821764.35	14.69	Fair	Poor	Fair	Low	Medium	No	No	No	Retain	Bent trunk, root restricted by road, grown in tree pit
T79	Bombax ceiba	木棉	Outside Lot Boundary	7	5	460	834821.81	821759.67	14.40	Fair	Poor	Good	Low	Medium	No	No	No	Retain	Unbalanced form, root restricted by road, grown in tree pit
T80	Bombax ceiba	木棉	Outside Lot Boundary	7	6	580	834823.64	821754.85	14.14	Fair	Poor	Good	Low	Medium	No	No	No	Retain	Unbalanced form, root restricted by road, grown in tree pit
T81	Celtis sinensis	朴樹	Outside Lot Boundary	7	4	430	834787.24	821879.25	26.09	Fair	Poor	Fair	Low	Low	No	No	No	Retain	Severely leaning, grown on slope


- Note:

 1. Tree species identification, name and protection status re adopted from Hong Kong Plant Record of Hong Kong Herbarium of AFCD.

 2. Tree location, size and top soil level above root zone are according to topographic survey information from Land Surveyor.
- 3. Registrated Old and Valuable Trees and potential Old and Valuable Trees are checked in accordance with DevB TC No. 5/2020.
- 4. Cap. 96 refers to plants scheduled under Forestry Regulations (subsidiary legislation of the Forests and Countryside Ordinance, Cap. 96);


Cap 586 refers to plants protected under The Protection of Endangered Species of Animals and Plants Ordinance, Cap. 586;

RPPHK refers to plants under Rare and Precious Plants of Hong Kong as recorded by AFCD 2003; IUCN refers to plants under IUCN Red List of Threatened Species from www.iucnredlist.org.

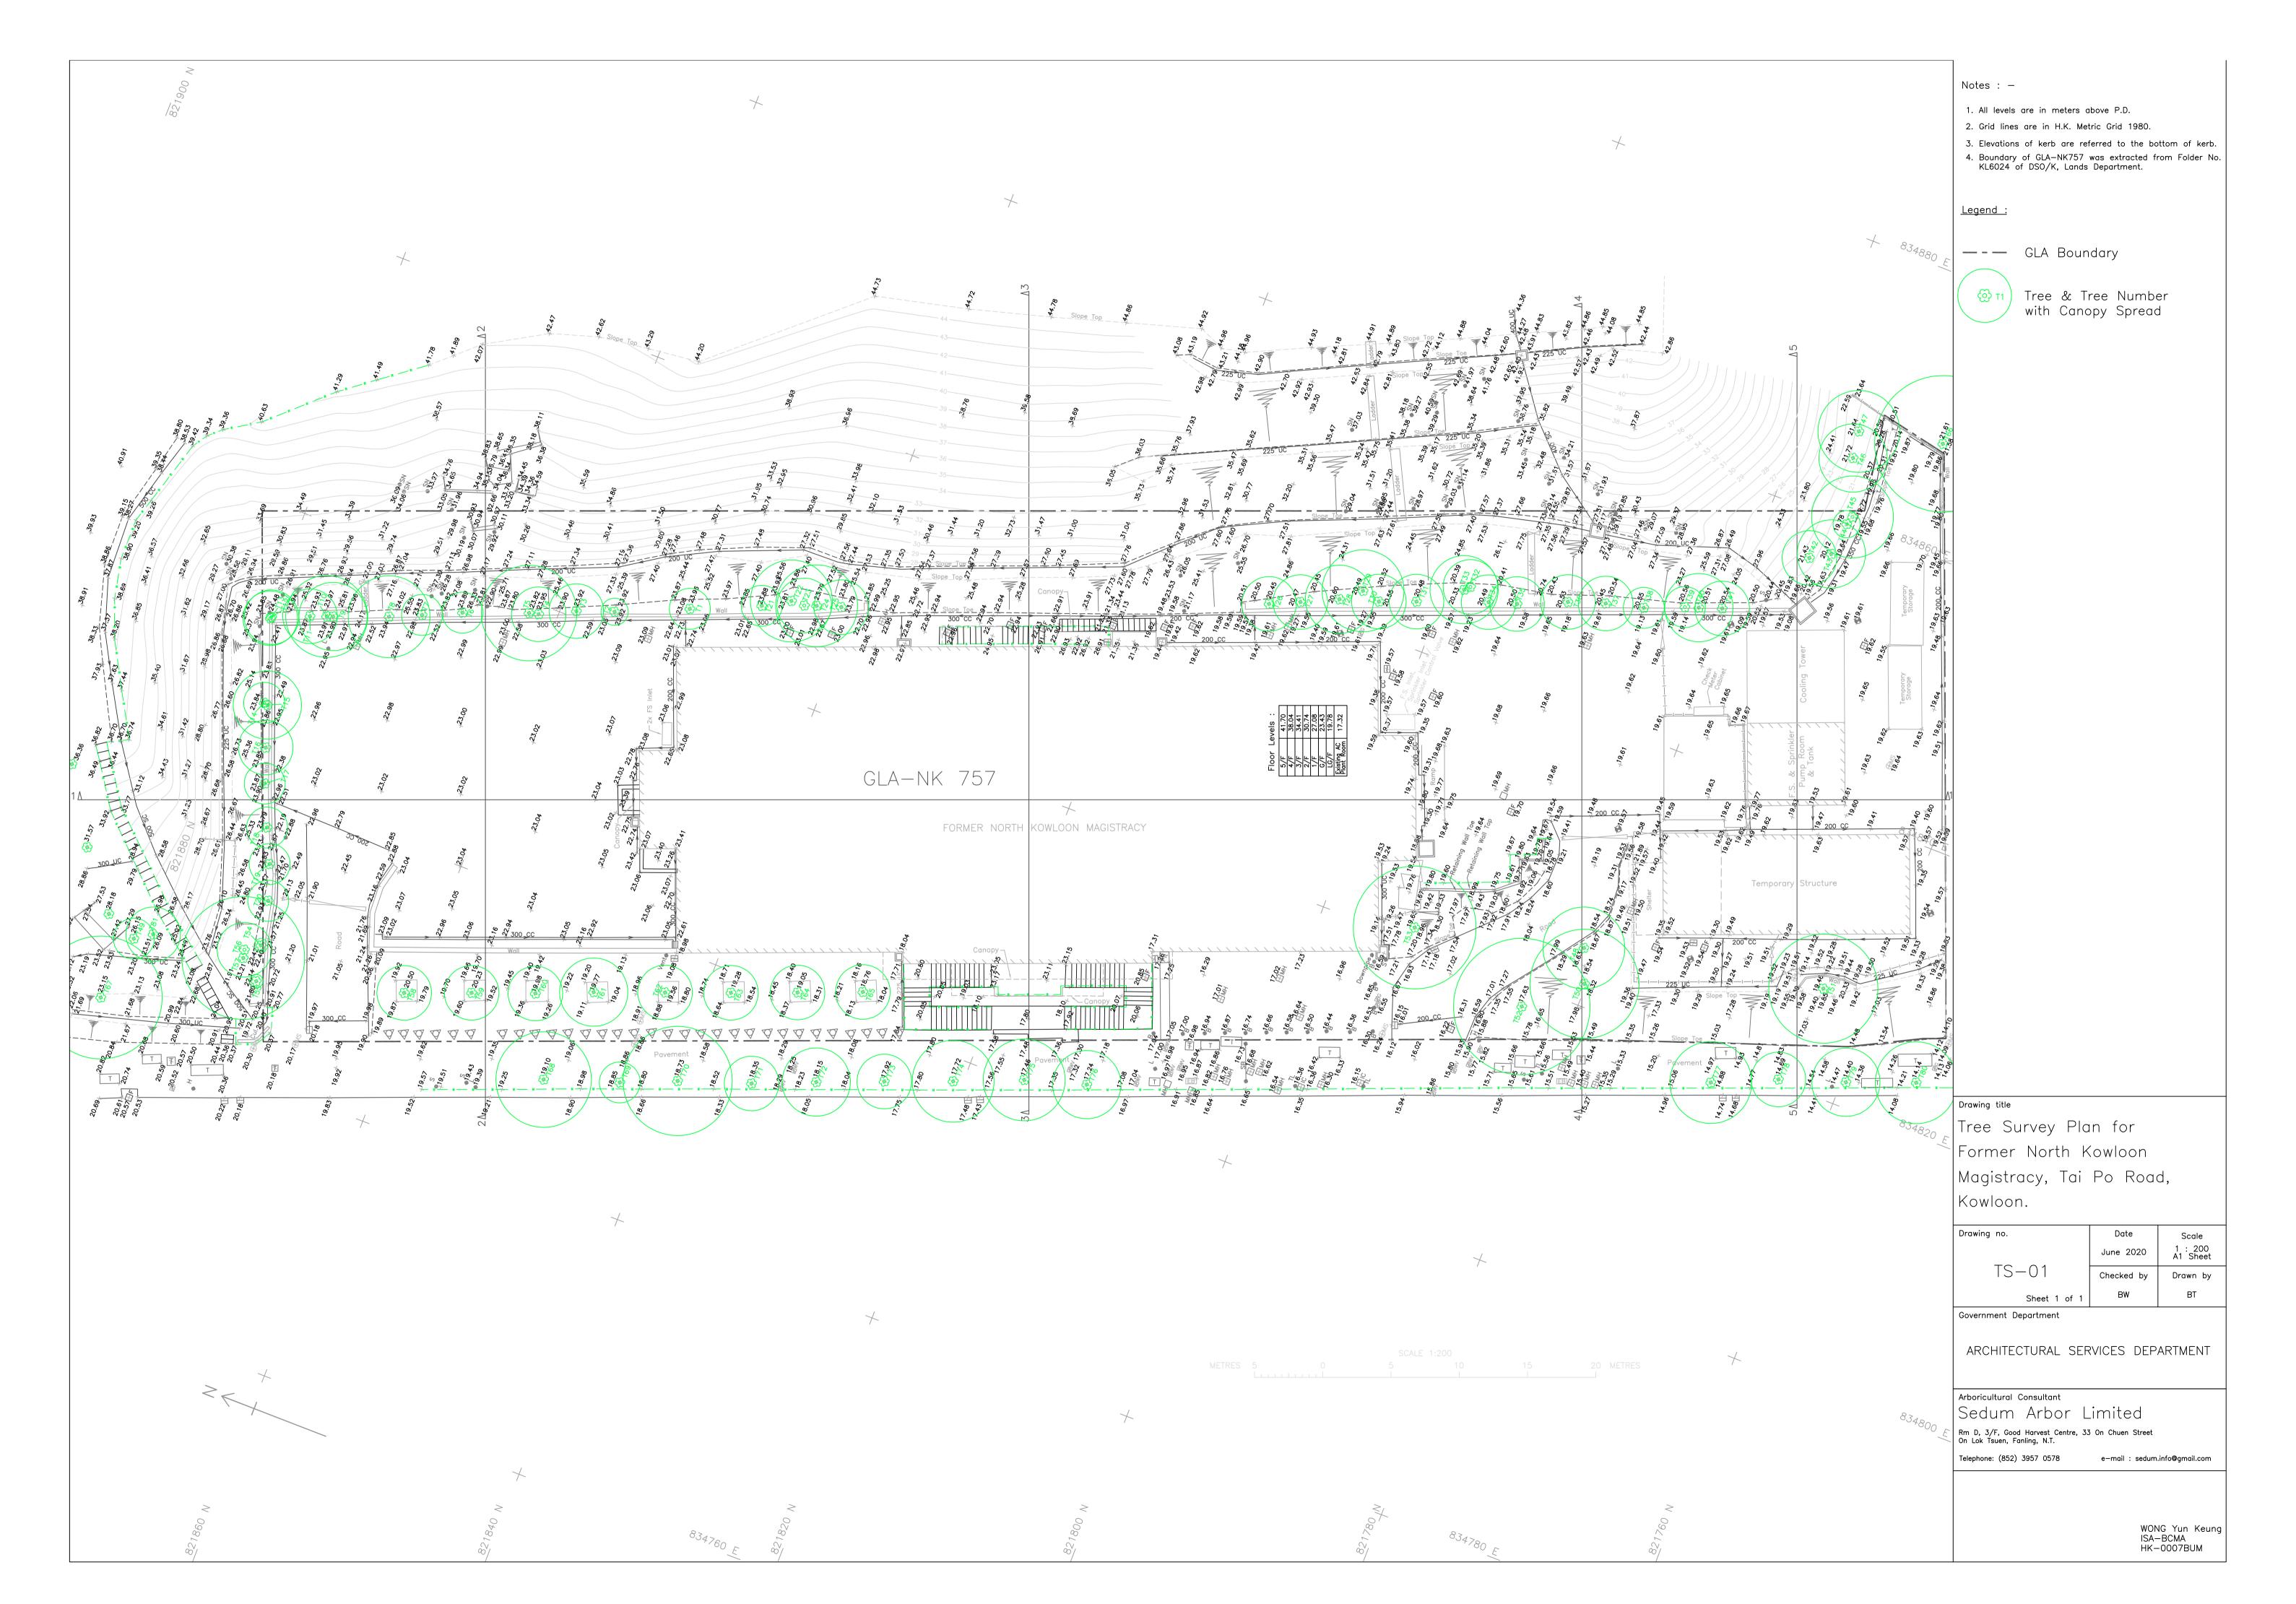

Appendix XV

Slope Features

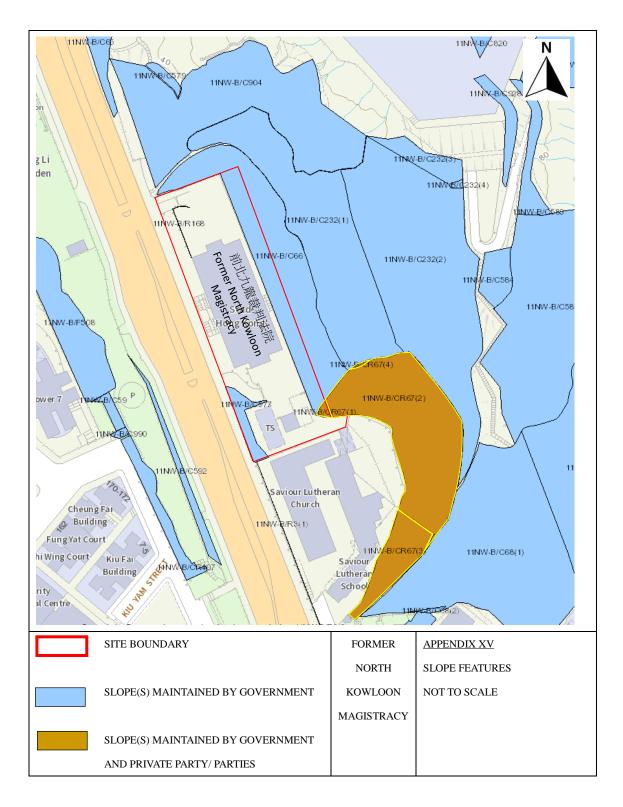

EXTRACT PLAN BASED ON WEBSITE SLOPE MAINTENANCE RESPONSIBILITY INFORMATION SYSTEM

Slope Maintenance Responsibility Report

(11NW-B/C66)



List of Slope Maintenance Responsibility Area(s)

1	11NW-B/C66		Sub-Division	Not Applicable				
	Location	WITHIN AND ADJOINING G	GLA-NK757					
	Responsible Lot/Party	Development Bureau	Maintenance Agent	Architectural Services Department				
	Remarks	For enquiries about the mainten Maintenance Agent direct.	ance of this slope / sub-division of	of the slope, please contact the				


- End of Report -

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Location Plan



Legend

Slope Area(s)

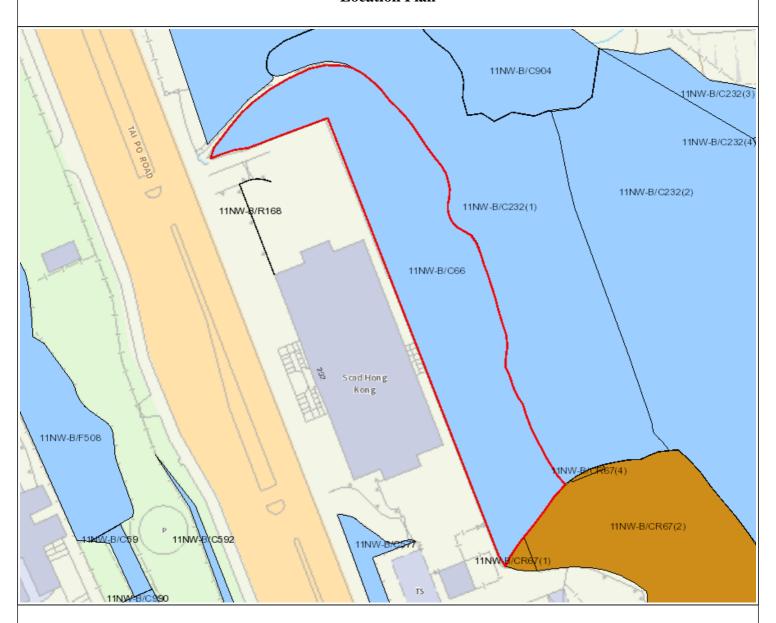Search Location

Slope(s) Maintained by Government

Slope(s) Maintained by Private Party/Parties

Slope(s) Maintained by Government and Private Party/Parties



ESTATE MANAGEMENT SECTION LANDS DEPARTMENT

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Slope Maintenance Responsibility Report

(11NW-B/C577)



List of Slope Maintenance Responsibility Area(s)

1	11NW-B/C577		Sub-Division	Not Applicable				
	Location	WITHIN GLA-NK757 & GOV	ERNMENT LAND NEAR SOU'	R SOUTH CORNER				
	Responsible Lot/Party	Development Bureau	Maintenance Agent	Architectural Services Department				
	Remarks	For enquiries about the maintenance of this slope / sub-division of the slope, please contact the Maintenance Agent direct.						


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Location Plan



Legend

Slope Area(s)

Search Location

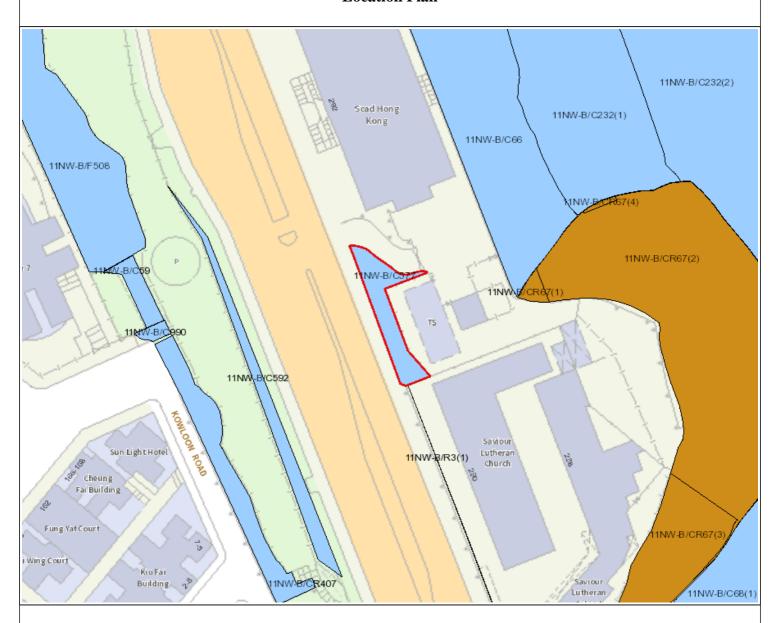Slope(s) Maintained by Government

Slope(s) Maintained by Private Party/Parties

Slope(s) Maintained by Government and Private Party/Parties



ESTATE MANAGEMENT SECTION LANDS DEPARTMENT

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Slope Maintenance Responsibility Report

(11NW-B/CR67)



List of Slope Maintenance Responsibility Area(s)

1	11NW-B/CR67		Sub-Division 1						
	Location	Partly within GLA-NK 757, par	tly on unallocated Government						
	Location	land adjoining NKIL 4456 &EX	T THERETO						
	Responsible Lot/Party	Development Bureau	Maintenance Agent Lands Department						
	Damauka	For enquiries about the maintenance of this slope / sub-division of the slope, please contact the							
	Remarks	Maintenance Agent direct.							

- End of Report -

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Location Plan



Legend

Slope Area(s)

Search Location

Slope(s) Maintained by Government

Slope(s) Maintained by Private Party/Parties

Slope(s) Maintained by Government and Private Party/Parties



ESTATE MANAGEMENT SECTION LANDS DEPARTMENT

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Search Criteria: 11NW-B/CR67

(11NW-B/CR67)



List of Slope Maintenance Responsibility Area(s)

1	11NW-B/CR67		Sub-Division 2				
	Location Partly within GLA-NK 757, partly within GLA-NK 739 and partly on unallocated C						
	Location	land adjoining NKIL 4456 &EXT THERETO					
	Responsible Lot/Party	Lands Department	Maintenance Agent	Lands Department			
	Remarks	For enquiries about the maintenance of this slope / sub-division of the slope, please contact the					
		Maintenance Agent direct.					

- End of Report -

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Location Plan



Legend

Slope Area(s)

Search Location

Slope(s) Maintained by Government

Slope(s) Maintained by Private Party/Parties

Slope(s) Maintained by Government and Private Party/Parties



ESTATE MANAGEMENT SECTION LANDS DEPARTMENT

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(11NW-B/CR67)



List of Slope Maintenance Responsibility Area(s)

1	11NW-B/CR67		Sub-Division	3		
	Partly within GLA-NK 757, partly within GLA-NK 739 and partly on unallocated Go					
	Location	land adjoining NKIL 4456 &EX	KT THERETO	HERETO		
	Responsible Lot/Party	NKIL 4456 &EXT	Maintenance Agent Not Applicable			
	Responsible Lour arty	Not Applicable				
	Remarks	Not Applicable				


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Location Plan



Legend

Slope Area(s)

Search Location

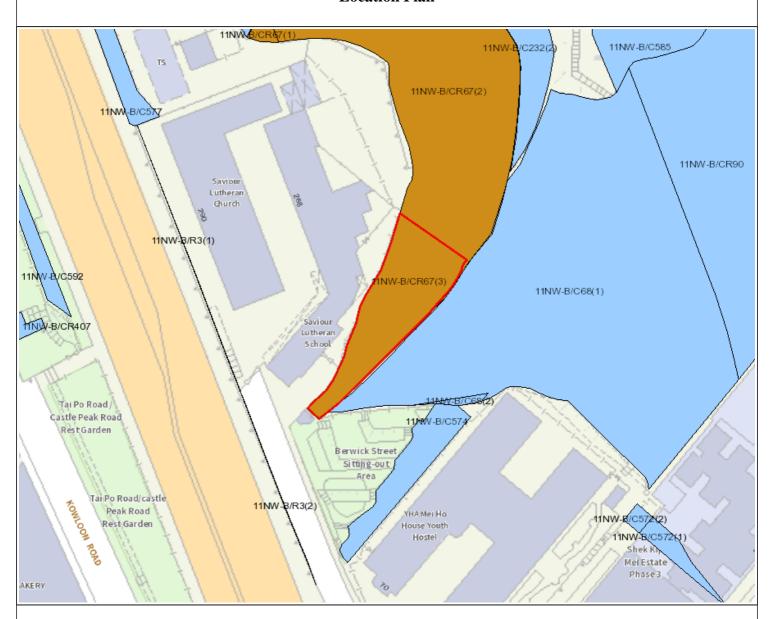Slope(s) Maintained by Government

Slope(s) Maintained by Private Party/Parties

Slope(s) Maintained by Government and Private Party/Parties



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(11NW-B/CR67)



List of Slope Maintenance Responsibility Area(s)

1	11NW-B/CR67		Sub-Division	4			
	Location Partly within GLA-NK 757, partly within GLA-NK 739 and partly on unalle						
	Location	land adjoining NKIL 4456 &EXT THERETO					
	Responsible Lot/Party	Leisure and Cultural Services	Maintenance Agent	Architectural Services			
	Responsible Lour arty	Department	Waintenance Agent	Department			
	Remarks	For enquiries about the maintenance of this slope / sub-division of the slope, please contact the					
		Maintenance Agent direct.					


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(11NW-B/R168)



List of Slope Maintenance Responsibility Area(s)

1	11NW-B/R168		Sub-Division	Not Applicable	
	Location	Within GLA-NK 757, Savannal	vannah College of Art and Design Hong Kong		
	Responsible Lot/Party Development Bureau		Maintenance Agent	Architectural Services Department	
	Remarks	For enquiries about the mainten Maintenance Agent direct.	ance of this slope / sub-division of	of the slope, please contact the	

- End of Report -
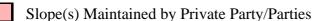
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Search Criteria: 11NW-B/R168

Appendix XVI

Recurrent Expenditure

Recurrent Expenditure

(A) Electricity Fee

Possible Use(s) ⁽¹⁾	GFA (m ²)	Net Gross Ratio	IFA (m ²)	Energy Consumption Indicator ⁽²⁾ (MJ/m ² /annum)	Energy Consumption per annum (kWh/annum) ⁽³⁾	Estimated Electricity Fee (\$) ⁽⁴⁾ per annum	Energy Consumption is based on the following Groups of Uses on EMSD's website ⁽²⁾
	(a)	(b)	(c)=(a)x(b)	(d)	(e)=(c)*(d)*0.2778		
Educational Institution				535	878,807.80	1,163,541.53	Adult Education/ Tutorial/ Vocational Schools
Eating Place				8,149	13,385,803.28	17,722,803.54	Other Eating and Drinking Places
Place of Recreation	7,673	77.1%	5,913	2,958	4,858,903.68	6,433,188.47	Common Areas of Commercial Complex/ Shopping Arcades
Research, Design and Development Centre				437	717,829.92	950,406.81	Creative and Performing Art Activities (Studios)

Notes:

- (1) It is assumed the length of operating hours is in line with the normal mode of operations, e.g. 10 hours for the Uses.
- (2) The respective "Energy Consumption Indicators" can be found at https://ecib.emsd.gov.hk/index.php/en/energy-utilisation-index-en/commercial-sector-en
- (3) $1MJ \times 0.2778 = 1kWh$
- (4) Electricity fee is based on the tariff charged by China Light and Power Co. Ltd. CLP: Rate of Energy Charge @\$1.016. Rate of Fuel Cost Adjustment @\$0.308. 1 Unit = 1 kWh.

The estimated electricity fee is for cost projection in the application only.

The actual fee will be subject to the then tariff and actual demand and consumption.

(B) Water and Sewage Charge

Possible Use(s) ⁽¹⁾	GFA (m ²)	Net Gross Ratio	IFA (m ²)	Estimated Water & Sewage Charge	Estimated Water & Sewage Charge
				(\$)/month	(\$) ⁽²⁾ /annum
	(a)	(b)	$(c) = (a) \times (b)$	(d)	$(e) = (d) \times 12$
Educational Institution				(d) = (c) $\times \$0.3^{(1)}$ 1,773.9	21,286.8
Eating Place				(d)=(Refer to Note 3) 16,524	198,288
Place of Recreation	7,673	77.1%	5,913	(d) = (c) $\times \$0.3^{(1)}$ 1,773.9	21,286.8
Research, Design and Development Centre				(d) = (c) $\times \$0.3^{(1)}$ 1,773.9	21,286.8

Notes:

- (1) According to the standard accommodation rate issued by the Government Property Agency, the estimated monthly water & sewage charges of Government-owned offices is = \$0.3 per m².
 - Based on the above estimate, it is assumed that the use of water per m² of:
 - Education institution, Place of Recreation or Research, Design and Development Centre = Offices
- (2) The estimated water and sewage charge is for cost projection in the application only. The applicants are free to make reference to other sources as appropriate. The actual water and sewage charge will be subject to the then tariff and actual consumption.
- (3) The estimated water and sewage charge per month of food and beverage and shop services
 - = [Nos. of sink x Operation Time (hours)] x Liter per second x Nos. of Seconds per hour x Estimated Water & Sewage Charge per m^2 x nos. of days operated per month
 - = (i) x (ii) x 3600 x (iii) x 30
 - = 127.5 x 0.00016 x 3600 x 7.5 x 30
 - = 16,524
 - (i) Say 30 nos. of sink operate per day and make an assumption below:
 - a) opening hours = 12 hours [Total water consumption -(0900 1200 (45 mins) + 1200 1500 (80 mins.) + <math>1500 1800 (70 mins.) + 1800 2100 (60 mins.) = 255 mins.)]
 - b) 255mins. X 30 nos. of sink operate = 7,650mins. (127.5 hours)
 - (ii) The water tap of sink flows 0.16 l/s (According to Members of Intuition of Plumbing Engineers Guide), therefore The water tap of sink flows = $0.00016 \text{ m}^3/\text{s}$
 - (iii) According to the standard accommodation rate issued by the Water Supplies Department, the estimated monthly water & sewage charges of Food and beverage services are \$4.58 per m³ and \$2.92 per m³. Therefore, Estimated Water & Sewage Charge(\$) is \$7.5 per m³.
 - (iv) Nos. of days the food and beverage services operates (say 30 days for month)

(C) Estimated Rates and Rent

Possible Use(s) ⁽¹⁾	GFA (m ²)	Site Area (m²)	Rateable Value ⁽¹⁾ (\$)	Rent/annum (\$)	Rent/annum (\$)	Rates & Rent/annum(\$)
			(a)	$(b) = (a) \times 5\%$	$(c) = (a) \times 3\%$	(d) = (b) + (c)
Educational Institution						
Eating Place						
Place of Recreation	7,673	4,815	11,520,000	576,000	345,600	921,600
Research, Design and Development Centre						

Notes:

(1) The above rateable values are rough estimate based on the possible uses and are for the cost projection in the application only. The actual assessment of rateable values will depend on the actual use, operating mode, extent of renovation, actual floor area, etc. of each historic building. The rateable value will be subject to annual revaluation by the Rating and Valuation Department.